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NO.	NO. NO.	LINE 3	LINE 4	LINE 5	LINE 6
			GENERAI		
	B4990-B	AVE 21 HYBRID	GENERAL	INDEX OF DRAWINGS	SHEET 1 OF 3
	B4991-B	AVE 21 HYBRID	GENERAL	INDEX OF DRAWINGS	SHEET 2 OF 3
	B4992-B	AVE 21 HYBRID	GENERAL	INDEX OF DRAWINGS	SHEET 3 OF 3
	B4993-B	AVE 21 HYBRID	GENERAL	ABBREVIATIONS, SYMBOLS & NOTES	SHEET 1 OF 1
	B5000-B	AVE 21 HYBRID		INDEX MAP	SHEET 1 OF 2
	B5001-B	AVE 21 HYBRID		INDEX MAP	SHEET 2 OF 2
	CB5000-B				SHEET 1 OF 1
	CB5001-B				SHEET 1 OF 1
	CB5002-B		GRADE SEPARATION - AVENUE 22	KEY MAP	SHEET 1 OF 1
	CB5003-B		GRADE SEPARATION - AVENUE 21 1		SHEET 1 OF 1
		AVE 21 HYBRID	GRADE SEPARATIONS	TYPICAL CROSS SECTIONS	SHEET 1 OF 1
		AVE 21 HYBRID		GENERAL STAGE CONSTRUCTION AND TRAI	
	C14993-B	AVE 21 HYBRID		GENERAL STAGE CONSTRUCTION AND TRAI	FFIC PLAN SHEET 2 OF 2
			AVENUE 21 HYBRID	- (LAYOUT)	·
1	CT0001-A	BNSF MAIN LINE - (AVE 21 HYBRID)	GRADE SEPARATION - AVENUE 9	LAYOUT	SHEET 1 OF 3
1	CT0002-A	BNSF MAIN LINE - (AVE 21 HYBRID)	GRADE SEPARATION - AVENUE 9	LAYOUT	SHEET 2 OF 3
1		BNSF MAIN LINE - (AVE 21 HYBRID)	GRADE SEPARATION - AVENUE 9	LAYOUT	SHEET 3 OF 3
2		BNSF MAIN LINE - (AVE 21 HYBRID)	GRADE SEPARATION - AVENUE 10	LAYOUT	SHEET 1 OF 3
2	CT0005-A CT0006-A		GRADE SEPARATION - AVENUE 10 GRADE SEPARATION - AVENUE 10	L AYOUT L AYOUT	SHEET 2 OF 3 SHEET 3 OF 3
3	CT0006-A		GRADE SEPARATION - AVENUE 10 GRADE SEPARATION - AVENUE 11	LAYOUT	SHEET 1 OF 3
3		BNSF MAIN LINE - (AVE 21 HYBRID)	GRADE SEPARATION - AVENUE 11	LAYOUT	SHEET 2 OF 3
3		BNSF MAIN LINE - (AVE 21 HYBRID)	GRADE SEPARATION - AVENUE 11	LAYOUT	SHEET 3 OF 3
4		BNSF MAIN LINE - (AVE 21 HYBRID)	GRADE SEPARATION - AVENUE 12	LAYOUT	SHEET 1 OF 3
4	CT0011-A	BNSF MAIN LINE - (AVE 21 HYBRID)	GRADE SEPARATION - AVENUE 12	LAYOUT	SHEET 2 OF 3
4		BNSF MAIN LINE - (AVE 21 HYBRID)	GRADE SEPARATION - AVENUE 12	LAYOUT	SHEET 3 OF 3
5	CT0013-A	BNSF MAIN LINE - (AVE 21 HYBRID)	GRADE SEPARATION - AVENUE 13	LAYOUT	SHEET 1 OF 4
5	CT0014-A		GRADE SEPARATION - AVENUE 13	LAYOUT	SHEET 2 OF 4
5	CT0015-A		GRADE SEPARATION - AVENUE 13	LAYOUT	SHEET 3 OF 4
5		BNSF MAIN LINE - (AVE 21 HYBRID)	GRADE SEPARATION - AVENUE 13	LAYOUT	SHEET 4 OF 4
6		BNSF MAIN LINE - (AVE 21 HYBRID)	GRADE SEPARATION - AVENUE 15	LAYOUT	SHEET 1 OF 3
6		BNSF MAIN LINE - (AVE 21 HYBRID)	GRADE SEPARATION - AVENUE 15	LAYOUT	SHEET 2 OF 3
6		BNSF MAIN LINE - (AVE 21 HYBRID)	GRADE SEPARATION - AVENUE 15	LAYOUT	SHEET 3 OF 3
7	CT0020-A	BNSF MAIN LINE - (AVE 21 HYBRID) BNSF MAIN LINE - (AVE 21 HYBRID)	GRADE SEPARATION - AVENUE 15 1 GRADE SEPARATION - AVENUE 15 1		SHEET 1 OF 3 SHEET 2 OF 3
7	CT0021-A		GRADE SEPARATION - AVENUE 15 1		SHEET 3 OF 3
1	CTOOZZ A	DIGST WATER CINE (AVE 21 HIDRID)	ORADE SELARATION AVENUE 13 1	7E ENTOOT	SHEET S OF S
9	CT0026-A	BNSF MAIN LINE - (AVE 21 HYBRID)	GRADE SEPARATION - AVENUE 17	LAYOUT	SHEET 1 OF 3
9	CT0027-A		GRADE SEPARATION - AVENUE 17	LAYOUT	SHEET 2 OF 3
9	CT0028-A		GRADE SEPARATION - AVENUE 17	LAYOUT	SHEET 3 OF 3
10	CT0029-A		GRADE SEPARATION - ROAD 27	LAYOUT	SHEET 1 OF 3
10	CT0030-A		GRADE SEPARATION - ROAD 27	LAYOUT	SHEET 2 OF 3
10	CT0031-A	BNSF MAIN LINE - (AVE 21 HYBRID)	GRADE SEPARATION - ROAD 27	LAYOUT	SHEET 3 OF 3
11		BNSF MAIN LINE - (AVE 21 HYBRID)	GRADE SEPARATION - ROAD 26	LAYOUT	SHEET 1 OF 3
11	CT0033-A		GRADE SEPARATION - ROAD 26	LAYOUT	SHEET 2 OF 3
11		BNSF MAIN LINE - (AVE 21 HYBRID)	GRADE SEPARATION - ROAD 26	LAYOUT	SHEET 3 OF 3
90	CT0066-A		GRADE SEPARATION - AVENUE 20	LAYOUT	SHEET 1 OF 3
90 90	CT0067-A		GRADE SEPARATION - AVENUE 20	LAYOUT	SHEET 2 OF 3
90	CT0068-A CT0069-A		GRADE SEPARATION - AVENUE 20 GRADE SEPARATION - AVENUE 20 1	LAYOUT /2 LAYOUT	SHEET 3 OF 3 SHEET 1 OF 3
91	CT0069-A		GRADE SEPARATION - AVENUE 20 1		SHEET 2 OF 3
91	CT0070-A		GRADE SEPARATION - AVENUE 20 1		SHEET 3 OF 3
92	CT0073-A		GRADE SEPARATION - ROAD 22	LAYOUT	SHEET 1 OF 3
92	CT0074-A		GRADE SEPARATION - ROAD 22	LAYOUT	SHEET 2 OF 3
92	CT0075-A		GRADE SEPARATION - ROAD 22	LAYOUT	SHEET 3 OF 3
25	CT0076-A	BNSF MAIN LINE - (AVE 21 HYBRID)	GRADE SEPARATION - ROAD 20	LAYOUT	SHEET 1 OF 3
25	CT0077-A	BNSF MAIN LINE - (AVE 21 HYBRID)	GRADE SEPARATION - ROAD 20	LAYOUT	SHEET 2 OF 3
25	CT0078-A		GRADE SEPARATION - ROAD 20	LAYOUT	SHEET 3 OF 3
26	CT0079-A		GRADE SEPARATION - ROAD 18 1/2		SHEET 1 OF 3
26	CT0080-A	·	GRADE SEPARATION - ROAD 18 1/2		SHEET 2 OF 3
26	CT0081-A		GRADE SEPARATION - ROAD 18 1/2		SHEET 3 OF 3
65	CT0146-A		GRADE SEPARATION - AVENUE 7 GRADE SEPARATION - AVENUE 7	LAYOUT LAYOUT	SHEET 1 OF 3
65 65	CT0147-A CT0148-A	,	GRADE SEPARATION - AVENUE 7	LAYOUT	SHEET 2 OF 3 SHEET 3 OF 3
64	CT0149-A			LAYOUT	SHEET 1 OF 1
12	CT5000-B			LAYOUT	SHEET 1 OF 4
	CT5000 B			LAYOUT	SHEET 2 OF 4
	1010001 0				SHEET 3 OF 4
12	CT5002-B	UPKK/SK99 MAINLINE/WYE - LAVE 21 HYRK	D) GRADE SEPARATION - ROAD IN	LAYOUT	1 2000 1 3 00 4
		UPRR/SR99 MAINLINE/WYE - (AVE 21 HYBR UPRR/SR99 MAINLINE/WYE - (AVE 21 HYBR		LAYOUT	SHEET 4 OF 4

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					DESIGNED BY R. LI	
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2	02/24/12	RG			CHECKED BY A. SILVER	
1	12/28/11	RG			IN CHARGE A. BOONE	
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Technical Services, Inc.
2020 L Street, Suite 300
Socramento, CA 95811
CH2MHILL



CALIFORNIA HIGH-SPEED TRAIN PROJECT MERCED TO FRESNO

AVE 21 HYBRID

GENERAL
INDEX OF DRAWINGS
SHEET 1 OF 3

CONTRACT NO. HSR06-007
DRAWING NO. B4990-B
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OCATION NO.	SHT NO.		DRAWING TITLE Line 3		ING TITLE	DRAWING TITLE LINE 5	DRAWING TITL LINE 6
13			UPRR/SR99 MAINLINE/WYE - (AVE 21 HYBRID)			LAYOUT	SHEET 1 OF 4
13			UPRR/SR99 MAINLINE/WYE - (AVE 21 HYBRID)			LAYOUT	SHEET 2 OF 4
13			UPRR/SR99 MAINLINE/WYE - (AVE 21 HYBRID)			LAYOUT	SHEET 3 OF 4
13			UPRR/SR99 MAINLINE/WYE - (AVE 21 HYBRID)			LAYOUT	SHEET 4 OF 4
14			UPRR/SR99 WYE - (AVE 21 HYBRID)	GRADE SEPARATION -		LAYOUT	SHEET 1 OF 3
14			UPRR/SR99 WYE - (AVE 21 HYBRID)	GRADE SEPARATION -		LAYOUT	SHEET 2 OF 3
14			UPRR/SR99 WYE - (AVE 21 HYBRID)	GRADE SEPARATION -		LAYOUT	SHEET 3 OF 3
15		CT5019-B	UPRR/SR99 WYE - (AVE 21 HYBRID)	GRADE SEPARATION -	- AVENUE 21 1/2	LAYOUT	SHEET 1 OF 4
15		CT5020-B	UPRR/SR99 WYE - (AVE 21 HYBRID)	GRADE SEPARATION -	- AVENUE 21 1/2	LAYOUT	SHEET 2 OF 4
15		CT5021-B	UPRR/SR99 WYE - (AVE 21 HYBRID)	GRADE SEPARATION -	- AVENUE 21 1/2	LAYOUT	SHEET 3 OF 4
15		CT5022-B	UPRR/SR99 WYE - (AVE 21 HYBRID)	GRADE SEPARATION -	- AVENUE 21 1/2	LAYOUT	SHEET 4 OF 4
				AVENUE 21	HYBRID - (PROFI	 LE)	
		СТ5700-В	AVE 21 HYBRID	GRADE SEPARATION		SUPERELEVATION TEMPLATE	SHEET 1 OF 4
			AVE 21 HYBRID	GRADE SEPARATION		SUPERELEVATION TEMPLATE	SHEET 2 OF 4
		CT5702-B	AVE 21 HYBRID	GRADE SEPARATION		SUPERELEVATION TEMPLATE	SHEET 3 OF 4
		CT5703-B	AVE 21 HYBRID	GRADE SEPARATION		SUPERELEVATION TEMPLATE	SHEET 4 OF 4
1			BNSF MAIN LINE - (AVE 21 HYBRID)	GRADE SEPARATION -		PROF ILE	SHEET 1 OF 3
1			BNSF MAIN LINE - (AVE 21 HYBRID)	GRADE SEPARATION -		PROFILE	SHEET 2 OF 3
1			BNSF MAIN LINE - (AVE 21 HYBRID)	GRADE SEPARATION -		PROFILE	SHEET 3 OF 3
2			BNSF MAIN LINE - (AVE 21 HYBRID)	GRADE SEPARATION -		PROFILE	SHEET 1 OF 3
2			BNSF MAIN LINE - (AVE 21 HYBRID)	GRADE SEPARATION -		PROFILE	SHEET 2 OF 3
2			BNSF MAIN LINE - (AVE 21 HYBRID)	GRADE SEPARATION -		PROFILE	SHEET 3 OF 3
3 3			BNSF MAIN LINE - (AVE 21 HYBRID) BNSF MAIN LINE - (AVE 21 HYBRID)	GRADE SEPARATION - GRADE SEPARATION -		PROFILE PROFILE	SHEET 1 OF 3 SHEET 2 OF 3
3				GRADE SEPARATION -		PROFILE	SHEET 3 OF 3
<u>3</u>			BNSF MAIN LINE - (AVE 21 HYBRID) BNSF MAIN LINE - (AVE 21 HYBRID)	GRADE SEPARATION -		PROFILE PROFILE	SHEET 1 OF 3
4			BNSF MAIN LINE - (AVE 21 HYBRID)	GRADE SEPARATION -		PROFILE PROFILE	SHEET 2 OF 3
4			BNSF MAIN LINE - (AVE 21 HIDRID)	GRADE SEPARATION -		PROFILE PROFILE	SHEET 3 OF 3
5			BNSF MAIN LINE - (AVE 21 HIDRID)	GRADE SEPARATION -		PROFILE PROFILE	SHEET 1 OF 3
5			BNSF MAIN LINE - (AVE 21 HYBRID)	GRADE SEPARATION -		PROFILE PROFILE	SHEET 2 OF 3
5			BNSF MAIN LINE - (AVE 21 HYBRID)	GRADE SEPARATION -		PROFILE	SHEET 3 OF 3
6			BNSF MAIN LINE - (AVE 21 HYBRID)	GRADE SEPARATION -		PROFILE	SHEET 1 OF 3
6			BNSF MAIN LINE - (AVE 21 HYBRID)	GRADE SEPARATION -		PROFILE	SHEET 2 OF 3
6		CT1017-A	BNSF MAIN LINE - (AVE 21 HYBRID)	GRADE SEPARATION -		PROFILE	SHEET 3 OF 3
7			BNSF MAIN LINE - (AVE 21 HYBRID)	GRADE SEPARATION -		PROF I LE	SHEET 1 OF 3
7			BNSF MAIN LINE - (AVE 21 HYBRID)	GRADE SEPARATION -		PROF ILE	SHEET 2 OF 3
7		CT1020-A	BNSF MAIN LINE - (AVE 21 HYBRID)	GRADE SEPARATION -	- AVENUE 15 1/2	PROF ILE	SHEET 3 OF 3
9		CT1024-A	BNSF MAIN LINE - (AVE 21 HYBRID)	GRADE SEPARATION -	- AVENUE 17	PROF ILE	SHEET 1 OF 3
9		CT1025-A	BNSF MAIN LINE - (AVE 21 HYBRID)	GRADE SEPARATION -		PROF I LE	SHEET 2 OF 3
9		CT1026-A	BNSF MAIN LINE - (AVE 21 HYBRID)	GRADE SEPARATION -	- AVENUE 17	PROFILE	SHEET 3 OF 3
10		CT1029-A	BNSF MAIN LINE - (AVE 21 HYBRID)	GRADE SEPARATION -	- ROAD 27	PROFILE	SHEET 1 OF 3
10		CT1030-A	BNSF MAIN LINE - (AVE 21 HYBRID)	GRADE SEPARATION -		PROFILE	SHEET 2 OF 3
10			BNSF MAIN LINE - (AVE 21 HYBRID)	GRADE SEPARATION -		PROFILE	SHEET 3 OF 3
11			BNSF MAIN LINE - (AVE 21 HYBRID)	GRADE SEPARATION -		PROF ILE	SHEET 1 OF 3
11			BNSF MAIN LINE - (AVE 21 HYBRID)	GRADE SEPARATION -		PROF ILE	SHEET 2 OF 3
11			BNSF MAIN LINE - (AVE 21 HYBRID)	GRADE SEPARATION -		PROFILE	SHEET 3 OF 3
90			BNSF MAIN LINE - (AVE 21 HYBRID)	GRADE SEPARATION -		PROFILE	SHEET 1 OF 3
90			BNSF MAIN LINE - (AVE 21 HYBRID)	GRADE SEPARATION -		PROFILE	SHEET 2 OF 3
90			BNSF MAIN LINE - (AVE 21 HYBRID)	GRADE SEPARATION -	- AVENUE 20	PROFILE	SHEET 3 OF 3
91			BNSF MAIN LINE - (AVE 21 HYBRID)	GRADE SEPARATION -		PROFILE	SHEET 1 OF 3
91			BNSF MAIN LINE - (AVE 21 HYBRID)	GRADE SEPARATION -		PROFILE	SHEET 2 OF 3
91			BNSF MAIN LINE - (AVE 21 HYBRID)	GRADE SEPARATION -		PROFILE	SHEET 3 OF 3
92			BNSF MAIN LINE - (AVE 21 HYBRID) BNSF MAIN LINE - (AVE 21 HYBRID)	GRADE SEPARATION -		PROFILE	SHEET 1 OF 3 SHEET 2 OF 3
92 92			BNSF MAIN LINE - (AVE 21 HYBRID)	GRADE SEPARATION -		PROFILE PROFILE	SHEET 3 OF 3
25			BNSF MAIN LINE - (AVE 21 HYBRID)	GRADE SEPARATION -		PROFILE PROFILE	SHEET 1 OF 3
25			BNSF MAIN LINE - (AVE 21 HYBRID)	GRADE SEPARATION -		PROFILE PROFILE	SHEET 2 OF 3
25			BNSF MAIN LINE - (AVE 21 HYBRID)	GRADE SEPARATION -		PROFILE PROFILE	SHEET 3 OF 3
26			BNSF MAIN LINE - (AVE 21 HYBRID)	GRADE SEPARATION -		PROFILE	SHEET 1 OF 3
26			BNSF MAIN LINE - (AVE 21 HYBRID)	GRADE SEPARATION -		PROFILE	SHEET 2 OF 3
26			BNSF MAIN LINE - (AVE 21 HYBRID)	GRADE SEPARATION -		PROFILE	SHEET 3 OF 3
65			BNSF MAIN LINE - (AVE 21 HYBRID)	GRADE SEPARATION -		PROFILE	SHEET 1 OF 3
65			BNSF MAIN LINE - (AVE 21 HYBRID)	GRADE SEPARATION -		PROFILE	SHEET 2 OF 3
65			BNSF MAIN LINE - (AVE 21 HYBRID)	GRADE SEPARATION -		PROFILE	SHEET 3 OF 3
64				GRADE SEPARATION -		PROFILE	SHEET 1 OF 1
12			UPRR/SR99 MAINLINE/WYE - (AVE 21 HYBRID)			PROFILE	SHEET 1 OF 4
				GRADE SEPARATION -		PROFILE	SHEET 2 OF 4
12							
12 12		CT6002-B	UPRR/SR99 MAINLINE/WYE - (AVE 21 HYBRID)	GRADE SEPARATION -	- ROAD 16	PROFILE	SHEET 3 OF 4

7								
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AVE 21 HYBRID GENERAL INDEX OF DRAWINGS SHEET 2 OF 3

CONTRACT NO. HSR06-007
DRAWING NO. B4991-B
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SHEET NO. ### OF ###

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NO.	NO. NO.	LINE 3	LINE 4	LINE 5	LINE 6
13	CT6004-B	UPRR/SR99 MAINLINE/WYE - (AVE 21 HYBRID)	GRADE SEPARATION - ROAD 17 1/2	PROF ILE	SHEET 1 OF 4
13	CT6005-B	UPRR/SR99 MAINLINE/WYE - (AVE 21 HYBRID)	GRADE SEPARATION - ROAD 17 1/2	PROFILE	SHEET 2 OF 4
13	CT6006-B	UPRR/SR99 MAINLINE/WYE - (AVE 21 HYBRID)	GRADE SEPARATION - ROAD 17 1/2	PROFILE	SHEET 3 OF 4
13	CT6007-B	UPRR/SR99 MAINLINE/WYE - (AVE 21 HYBRID)	GRADE SEPARATION - ROAD 17 1/2	PROFILE	SHEET 4 OF 4
14	CT6016-B	UPRR/SR99 WYE - (AVE 21 HYBRID)	GRADE SEPARATION - AVENUE 22	PROF ILE	SHEET 1 OF 3
14	CT6017-B	UPRR/SR99 WYE - (AVE 21 HYBRID)	GRADE SEPARATION - AVENUE 22	PROF I LE	SHEET 2 OF 3
14	CT6018-B	UPRR/SR99 WYE - (AVE 21 HYBRID)	GRADE SEPARATION - AVENUE 22	PROF I LE	SHEET 3 OF 3
15	CT6019-B	UPRR/SR99 WYE - (AVE 21 HYBRID)	GRADE SEPARATION - AVENUE 21 1/2	PROFILE	SHEET 1 OF 5
15		UPRR/SR99 WYE - (AVE 21 HYBRID)	GRADE SEPARATION - AVENUE 21 1/2	PROF ILE	SHEET 2 OF 5
15	CT6021-B	UPRR/SR99 WYE - (AVE 21 HYBRID)	GRADE SEPARATION - AVENUE 21 1/2	PROF ILE	SHEET 3 OF 5
15		UPRR/SR99 WYE - (AVE 21 HYBRID)	GRADE SEPARATION - AVENUE 21 1/2	PROFILE	SHEET 4 OF 5
15	CT6023-B	UPRR/SR99 WYE - (AVE 21 HYBRID)	GRADE SEPARATION - AVENUE 21 1/2	PROF I LE	SHEET 5 OF 5
	CT1477A	BNSF MAIN LINE	AVENUE 24/SR 152/AVENUE 21	ROAD 11 GRADE SEPARATION	PLAN AND PROFILE
	CT1478A	BNSF MAIN LINE	AVENUE 24/SR 152/AVENUE 21	ROAD 11 GRADE SEPARATION	PLAN AND PROFILE
	CT1481A	BNSF MAIN LINE	AVENUE 24/SR 152/AVENUE 21	ROBERTSON BLVD GRADE SEPARATION	PLAN AND PROFILE
	CT1482A	BNSF MAIN LINE	AVENUE 24/SR 152/AVENUE 21	ROBERTSON BLVD GRADE SEPARATION	PLAN AND PROFILE
	CT1484A	BNSF MAIN LINE	AVENUE 24/SR 152/AVENUE 21	ROAD 14 GRADE SEPARATION	PLAN AND PROFILE
	CT1485A	BNSF MAIN LINE	AVENUE 24/SR 152/AVENUE 21	ROAD 14 GRADE SEPARATION	PLAN AND PROFILE
	CT1926	BNSF MAIN LINE	AVENUE 21	PLAN AND PROFILE	ROAD 9 / HEMLOCK ROAD GRADE SEPARATIO
	CT1927	BNSF MAIN LINE	AVENUE 21	PLAN AND PROFILE	ROAD 9 / HEMLOCK ROAD GRADE SEPARATIO
	CT1928	BNSF MAIN LINE	AVENUE 21	PLAN AND PROFILE	ROAD 9 / HEMLOCK ROAD GRADE SEPARATIO
	CT1929	BNSF MAIN LINE	AVENUE 21	PLAN AND PROFILE	ROAD 11 GRADE SEPARATION
	CT1930	BNSF MAIN LINE	AVENUE 21	PLAN AND PROFILE	ROAD 11 GRADE SEPARATION
	CT1931	BNSF MAIN LINE	AVENUE 21	PLAN AND PROFILE	ROAD 11 GRADE SEPARATION
	CT1932	BNSF MAIN LINE	AVENUE 21	PLAN AND PROFILE	ROBERTSON BLVD GRADE SEPARATION
	CT1933	BNSF MAIN LINE	AVENUE 21	PLAN AND PROFILE	ROBERTSON BLVD GRADE SEPARATION
	CT1934	BNSF MAIN LINE	AVENUE 21	PLAN AND PROFILE	ROBERTSON BLVD GRADE SEPARATION
	CT1935	BNSF MAIN LINE	AVENUE 21	PLAN AND PROFILE	ROAD 14 GRADE SEPARATION
	CT1936	BNSF MAIN LINE	AVENUE 21	PLAN AND PROFILE	ROAD 14 GRADE SEPARATION
	CT1937	BNSF MAIN LINE	AVENUE 21	PLAN AND PROFILE	ROAD 14 GRADE SEPARATION

DRAWING TITLE

DRAWING TITLE

DRAWING TITLE

						DESIGNED BY R. LI
						DRAWN BY A. TRINH
						CHECKED BY A. SILVER
						IN CHARGE A. BOONE
REV	DATE	ВΥ	СНК	APP	DESCRIPTION	DATE 06/30/2011

RECORD SET 15% DESIGN SUBMITTAL NOT FOR CONSTRUCTION

DRAWING TITLE

LOCATION SHT DWG





CALIFORNIA HIGH-SPEED TRAIN PROJECT MERCED TO FRESNO

AVE 21 HYBRID GENERAL INDEX OF DRAWINGS SHEET 3 OF 3

CONTRACT NO. HSR06-007
DRAWING NO. B4992-B
SCALE

NONE SHEET NO. ###

MISCELLANEOUS

ALIGN	IMENT
ВС	HORIZONTAL BEGINNING OF CURVE
EC PC PCC	END OF CURVE POINT OF CURVE POINT OF COMPOUNT CURVES
PI POB POC	POINT OF INTERSECTION OF TWO TANGENTS POINT OF BEGINNING POINT ON CURVE
POE POT PRC	POINT OF ENDING POINT ON TANGENT POINT OF REVERSE CURVES
PT R V, DS	POINT OF TANGENCY RADIUS OF CURVATURE IN FEET DESIGN VELOCITY IN MILES PER HOUR
BVC	<u>VERTICAL</u> BEGIN OF VERTICAL CURVE
EVC PVC PVI PVT	END OF VERTICAL CURVE POINT OF VERTICAL CURVE (BEGINNING OF CURVE) POINT OF VERTICAL INTERSECTION (OF TANGENTS) POINT OF VERTICAL TANGENCY (ENDING OF CURVE)
VC	VERTICAL CURVE

	AL TERMATIVE
ALT	ALTERNATIVE
AVE	AVENUE
BB	BEGIN BRIDGE
BEG	BEGIN
BLVD	BOULEVARD
Q.	CENTER LINE
CL	CENTERLINE, CLASS
CLR	CLEAR
COL	COLUMN
DWG	DRAWING
EB	END BRIDGE
ELEV	ELEVATION
EQ	EQUATION
ES	EDGE OF SIDEWALK
ETW	EDGE OF TRAVELED WAY
EXIST(E)	EXISTING
FL	FLOW LINE
HORIZ	HORIZONTAL
HP	HINGE POINT
HST	HIGH SPEED TRAIN
HWY	HIGHWAY
IC	INTERCHANGE
IN	INCH
L	LENGTH
LT	LEFT
MBGR	METAL BEAM GUARD RAIL
ML	MAINLINE
MPH	MILES PER HOUR
MAX	MAXIMUM
MIN	MINIMUM
N	NORTH
NB	NORTH BOUND
No, NO	NUMBER
NTS	NOT TO SCALE
OG	ORIGINAL GROUND
O/H OH	OVERHEAD
PG&E	PACIFIC GAS & ELECTRIC
PGL, FG	PROFILE GRADE LINE
RET	RETAINING
RR	RAILROAD
RD	ROAD
R/W	RIGHT OF WAY
RT	RIGHT
SB	SOUTH BOUND
SHLD	SHOULDER
SR	STATE ROUTE
SHT	SHEET
SS	SANITARY SEWER
SSD	STOPPING SIGHT DISTANCE
ST	STREET
STA	STATION
STD	STANDARD
SD STRUCT STR	STORM DRAIN
STRUCT, STR	STRUCTURE
T	TANGENT
TEL	TELEPHONE
	(OH) OVERHEAD LINE

TOR TK	TOP OF RAIL TRACK
TYP TBD TF	TYPICAL TO BE DETERMINED TELECOMMUNICATIONS FIBER OPTIC
UPRR VAR V VERT W	UNION PACIFIC RAILROAD VARIES VERTICAL WATER, WEST

	MATCH LINE
	HST TRACK
	PROPOSED HST RIGHT-OF-WAY
	FREIGHT/PASSENGER TRACK - EXISTING
	EXISTING OR EXISTING RIGHT-OF-WAY BRIDGE FEATURES
	RETAINING WALLS
	ORIGINAL GROUND
G16	GAS LINE (16")
— TC ——	COMMUNICATION LINE
- —— w ——— ——	WATER LINE
—— FO —— ——	FIBER OPTIC LINE
—— -E———	ELECTRICAL LINE
X	ELECTRICAL TOWER
S	SEWER LINE
	STORM DRAIN LINE
	FUEL LINE
—TC ——	TELEPHONE LINE
———— P12 ———	PETROLEUM LINE (12")
——— (OH) ———	OVERHEAD
	NORTH ARRROW
A	PVI
	MBGR
	DIRECTION OF TRAVEL
250	PROPOSED CONTOUR

7/0						DESIGNED BY R. LI
						DRAWN BY A. TRINH
\vdash						CHECKED BY A. SILVER
						IN CHARGE A. BOONE
OS REV	DATE	ВΥ	СНК	APP	DESCRIPTION	DATE 06/30/2011

RECORD SET
15% DESIGN
SUBMITTAL
NOT FOR

CONSTRUCTION

(UG) UNDERGROUND LINE

AECOM
Technical Services, inc.
2020 L Street, Suite 300
Sacramento, CA 95811
CH2MHILL



CALIFORNIA HIGH-SPEED TRAIN PROJECT MERCED TO FRESNO

AVE 21 HYBRID


GENERAL


ABBREVIATIONS, SYMBOLS AND NOTES


SHEET 1 OF 1

CONTRACT NO. HSRO6-007
DRAWING NO. B4993-B
SCALE NO SCALE

SHEET NO. ### OF ###

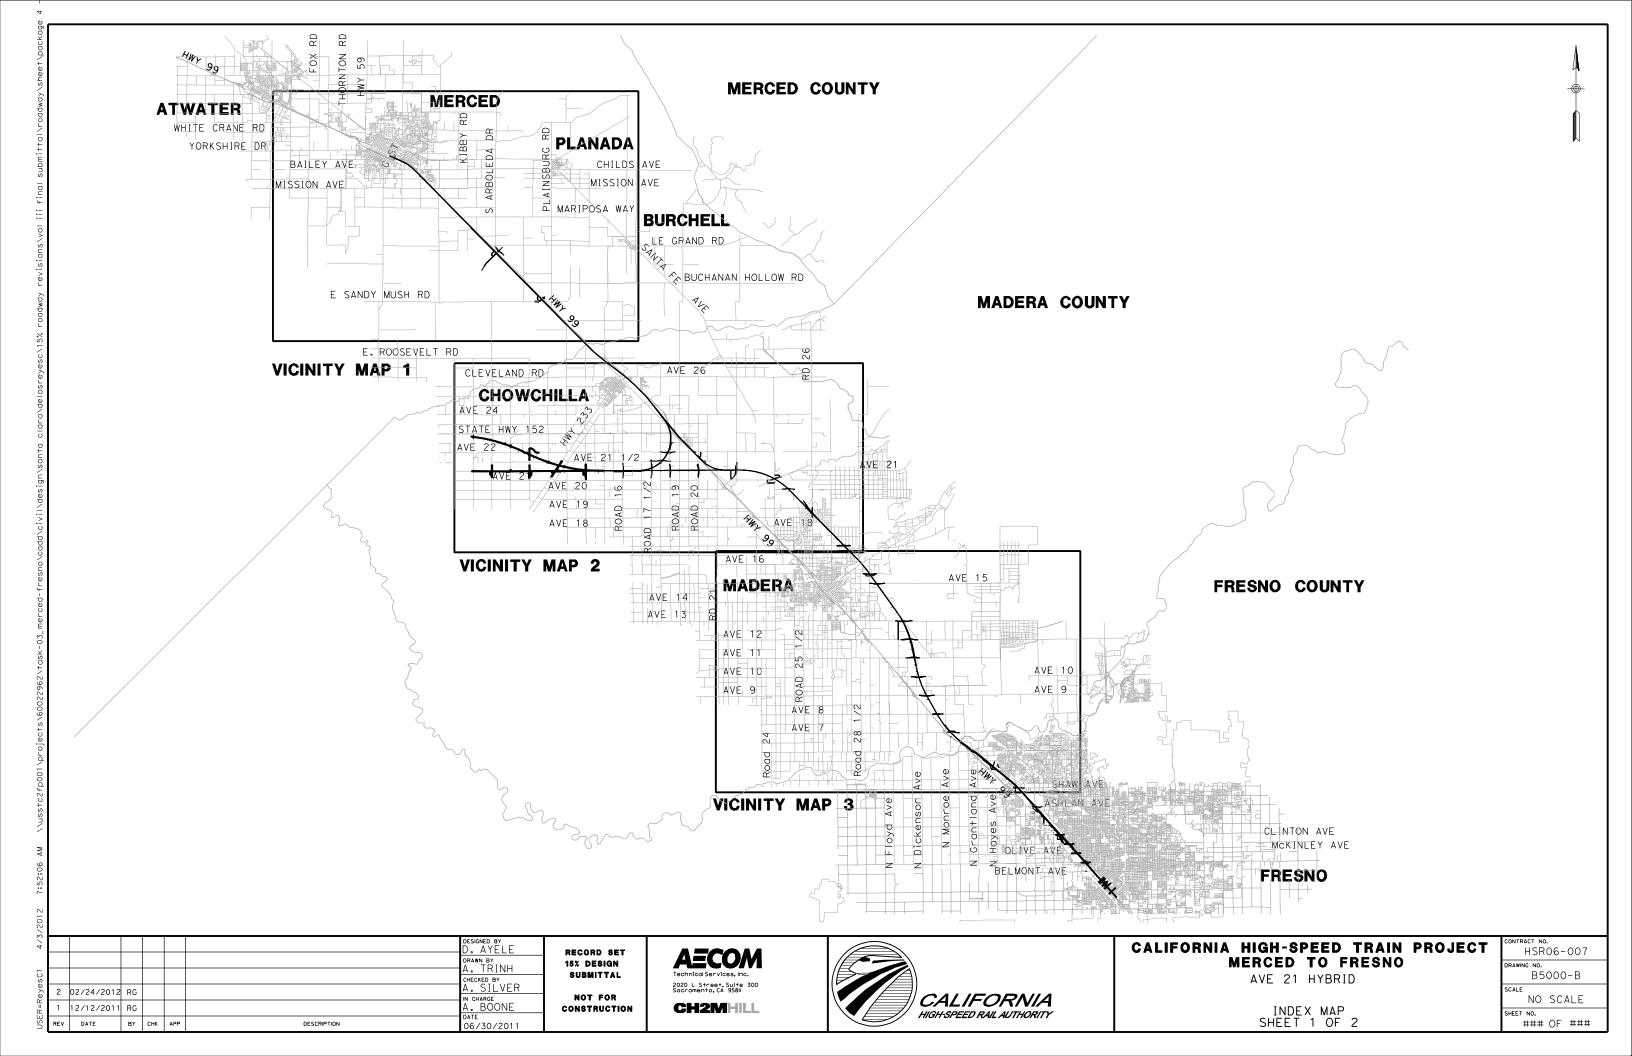

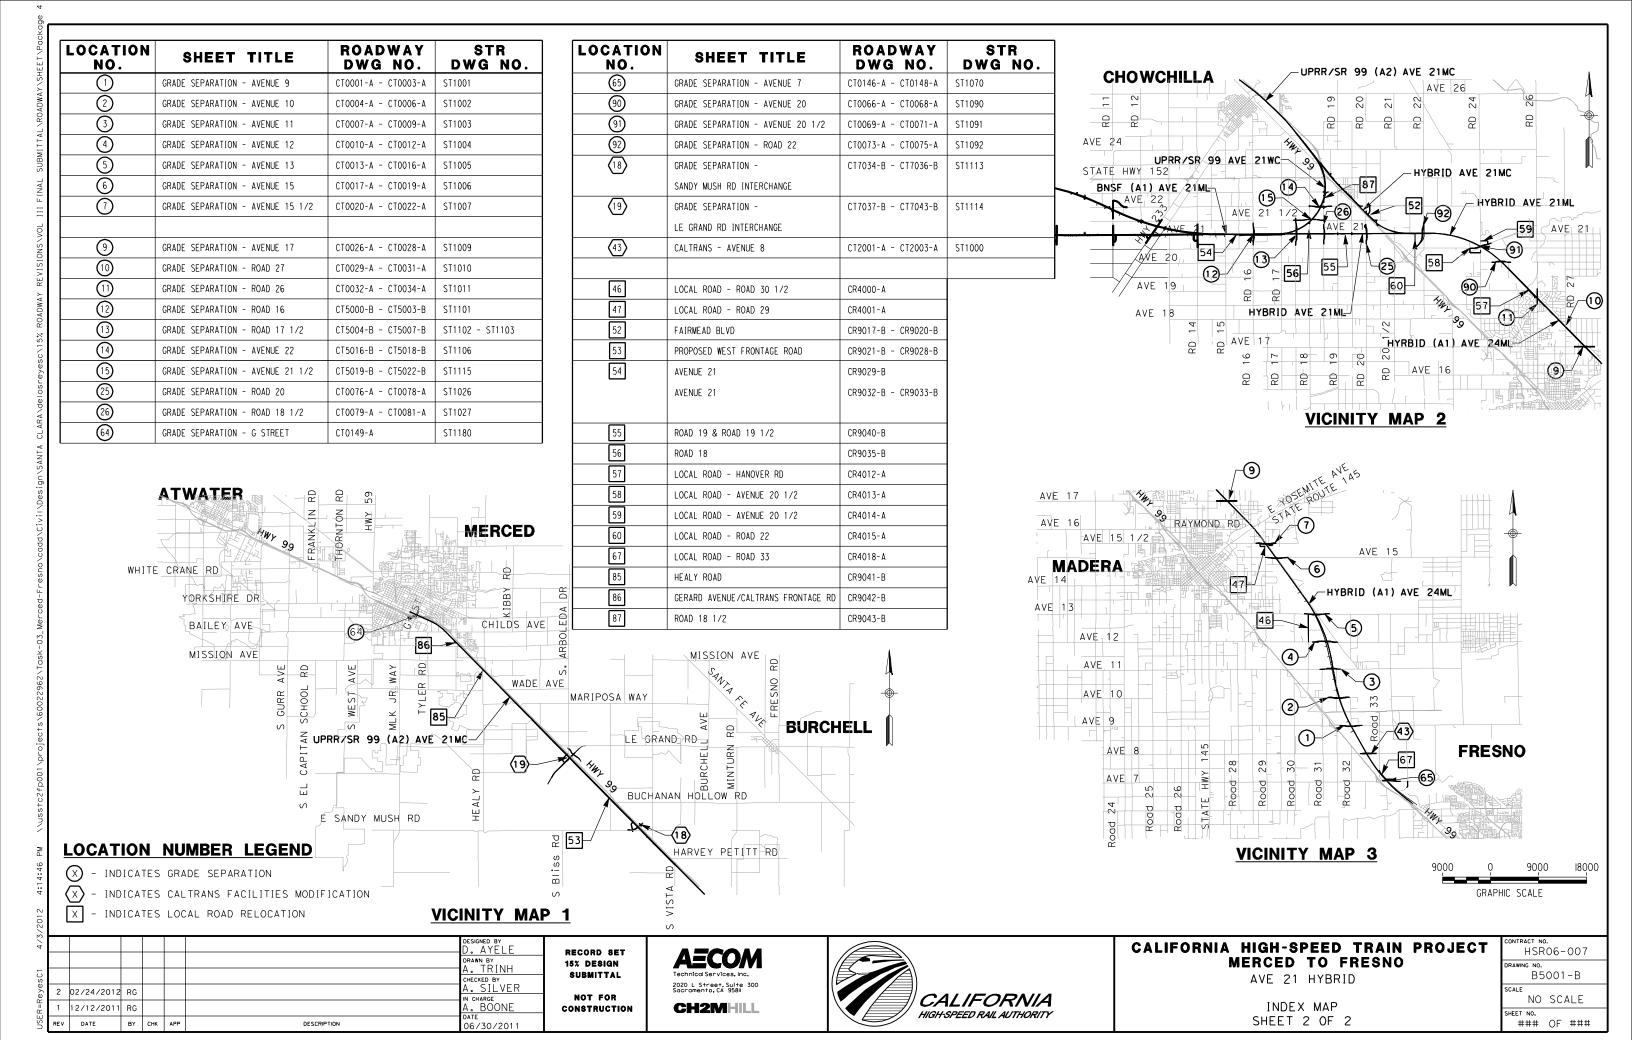

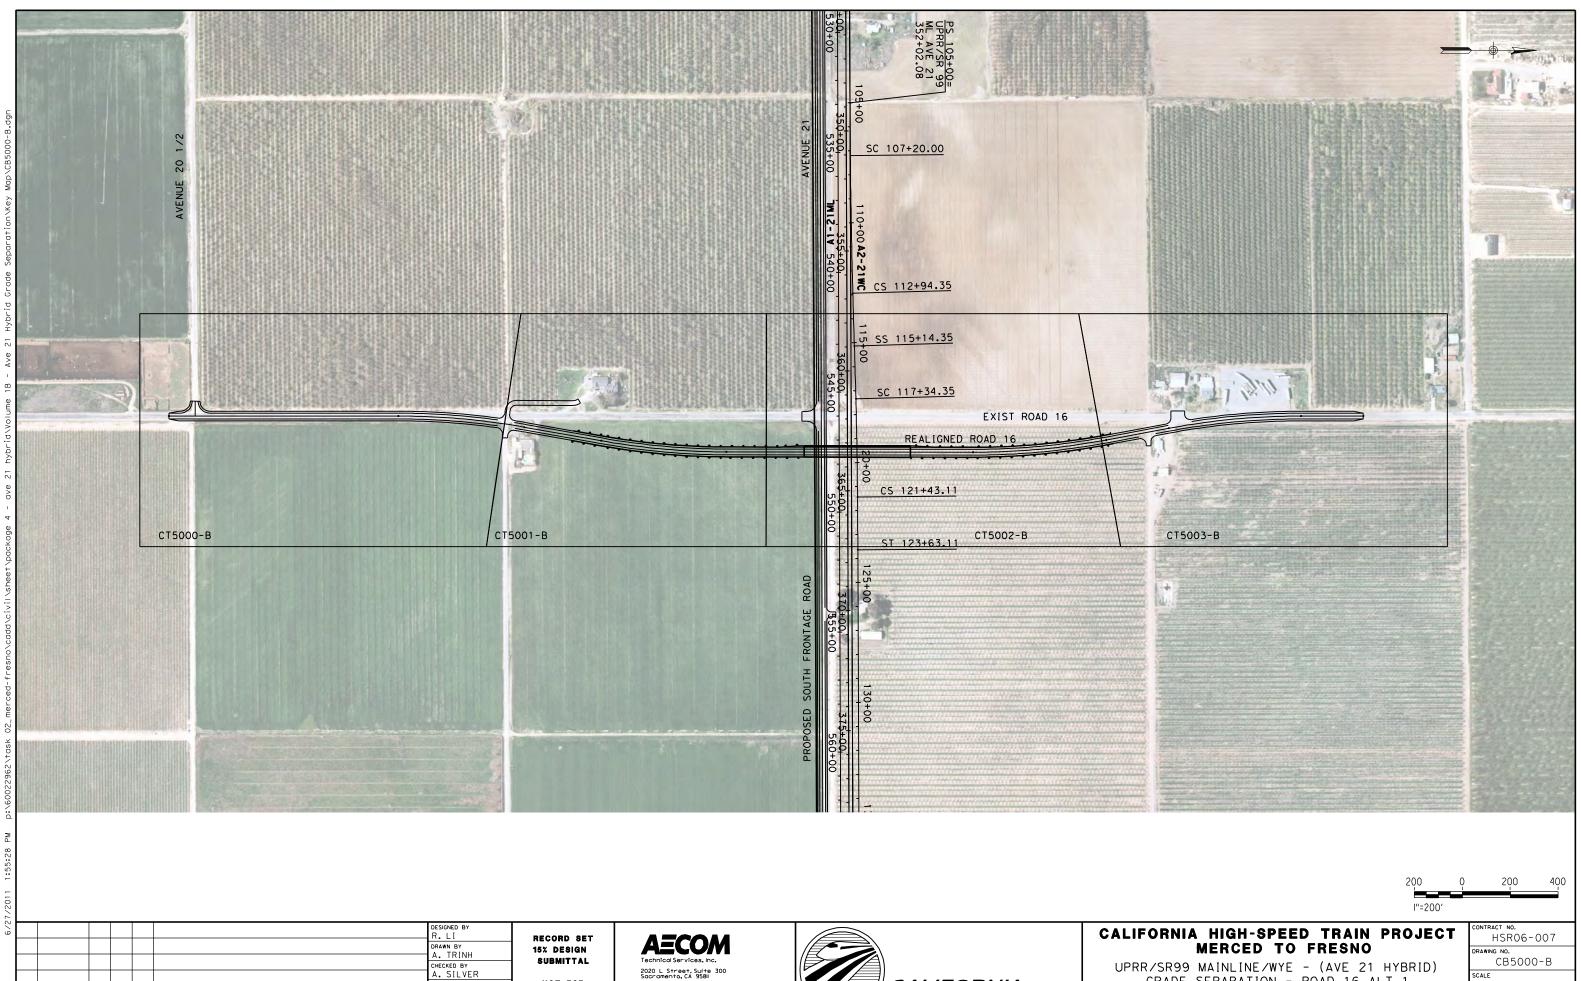

2020 L Street, Suite 300 Sacramento, CA 958II CH2MHILL

NOT FOR

CONSTRUCTION

IN CHARGE A. BOONE DATE 06/30/2011

BY CHK APP


DESCRIPTION





UPRR/SR99 MAINLINE/WYE - (AVE 21 HYBRID) GRADE SEPARATION - ROAD 16 ALT 1 KEY MAP SHEET 1 OF 1

CONTR	ACT NO		Τ
	HSR	06-007	
DRAWIN	IG NO.		_
	CB:	5000-B	
SCALE			
	ΑS	SHOWN	
SHEET	NO.	,	

OF

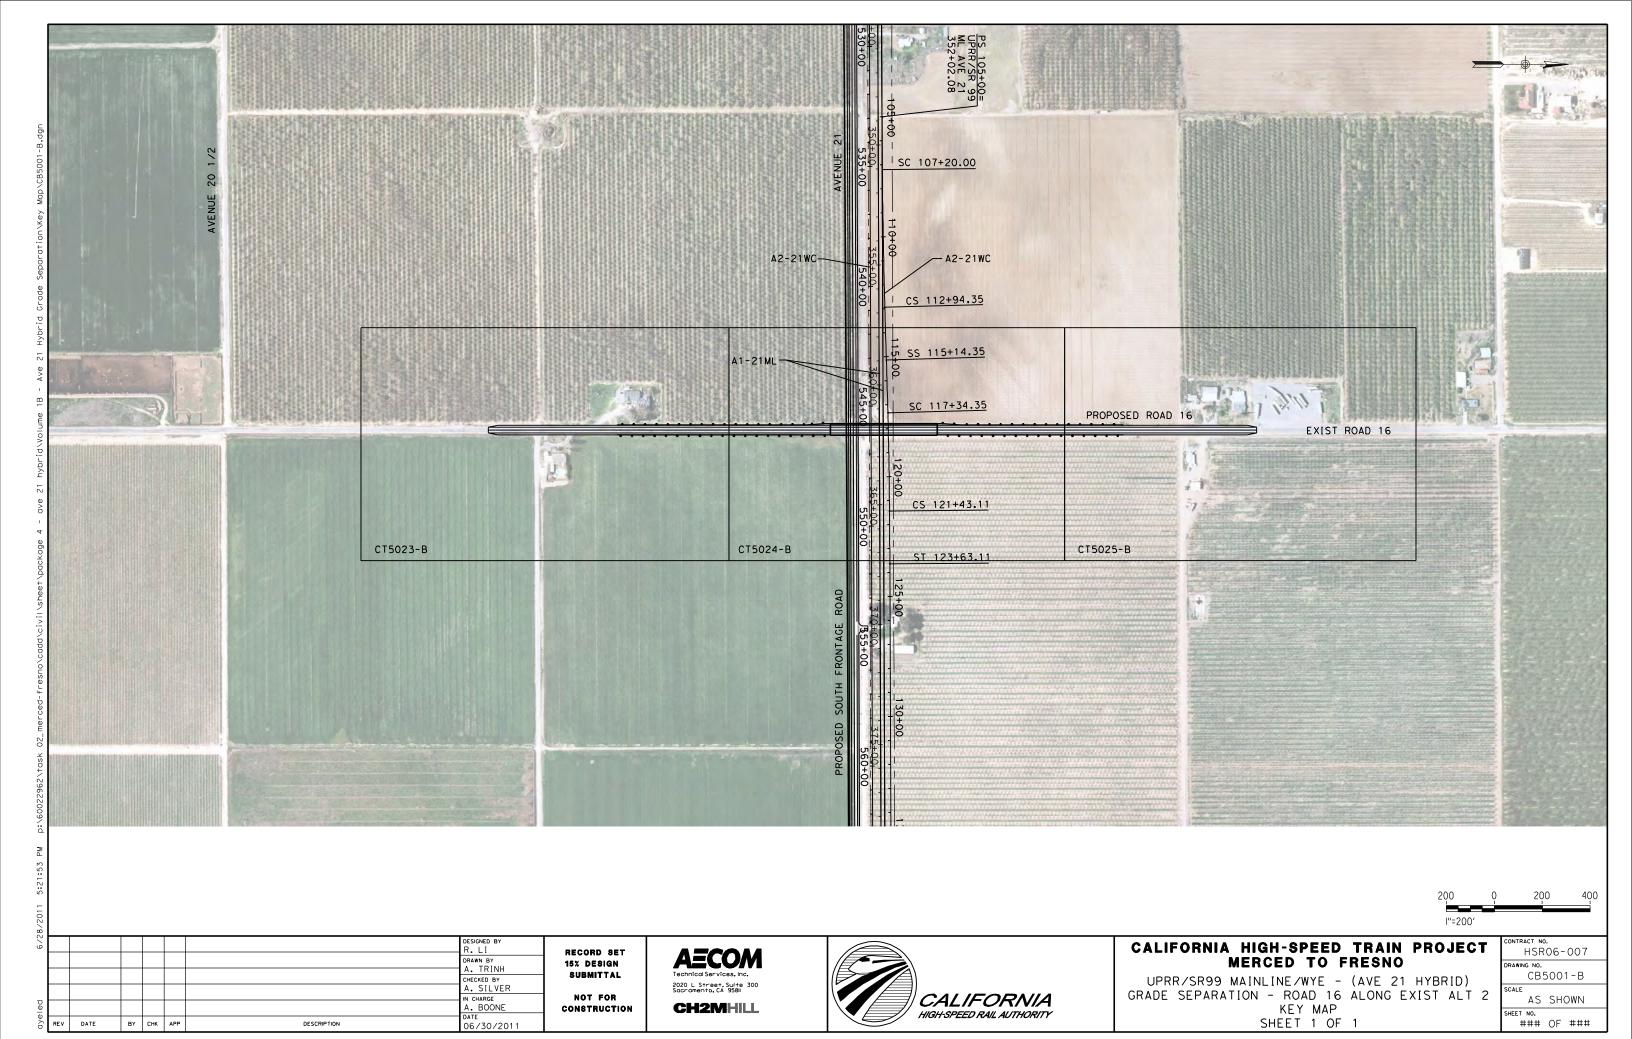


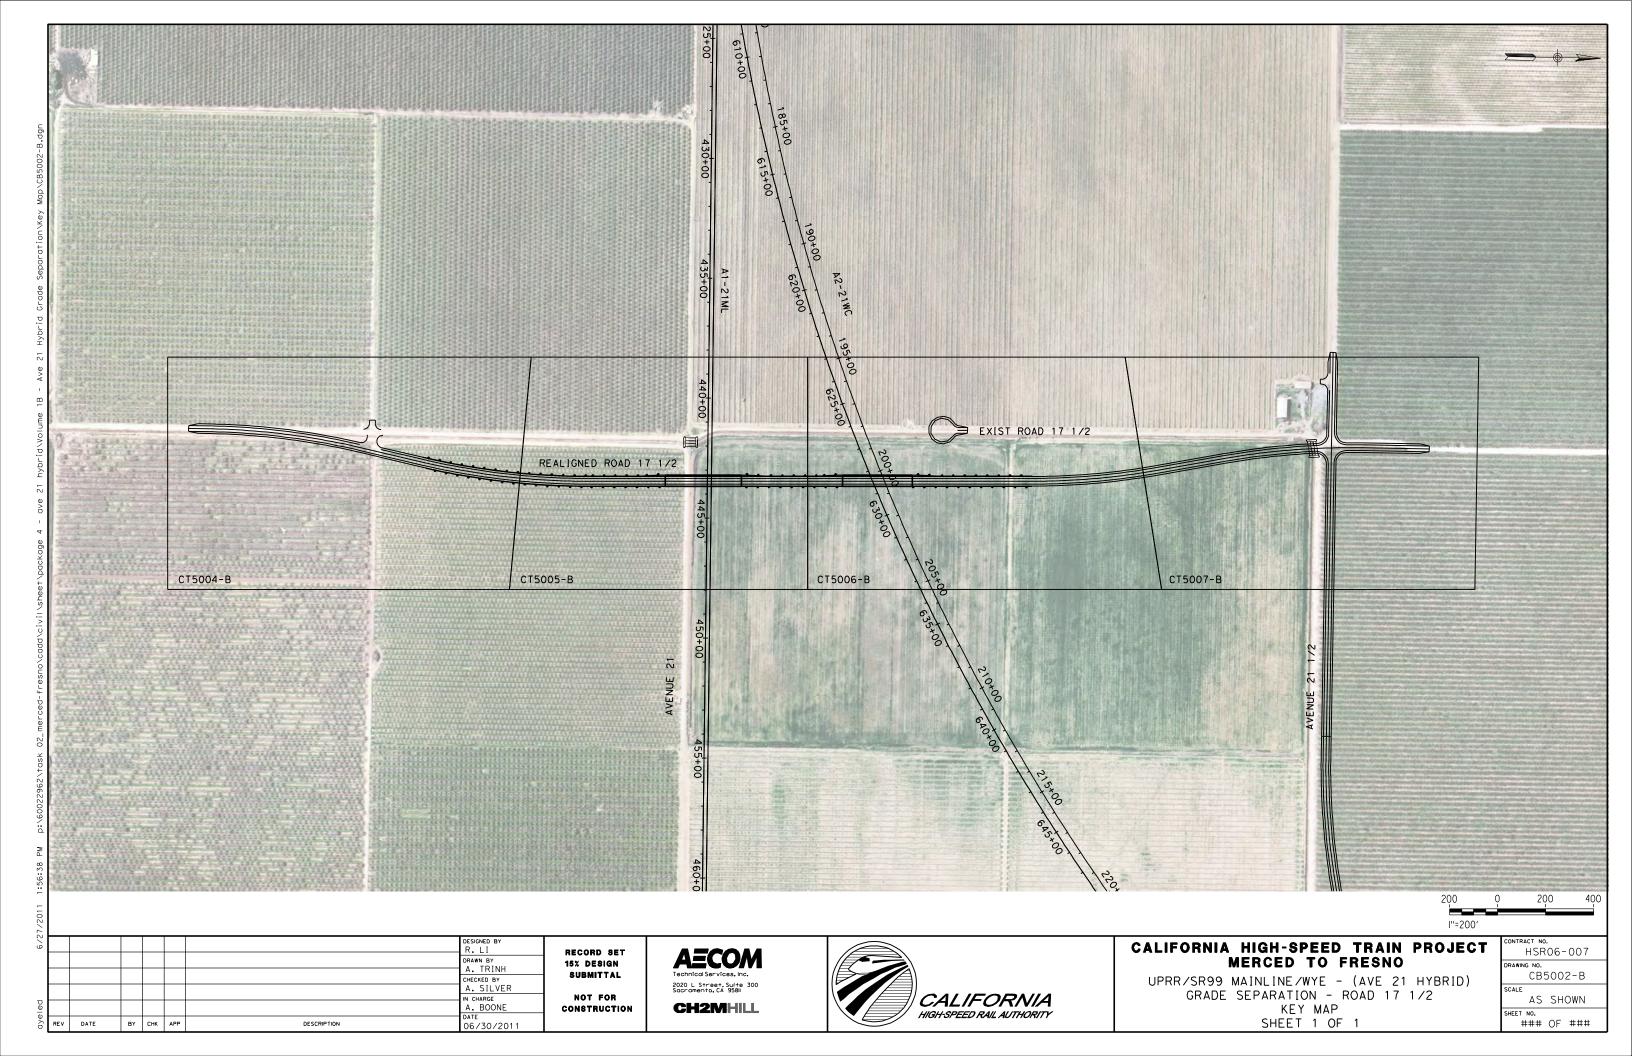

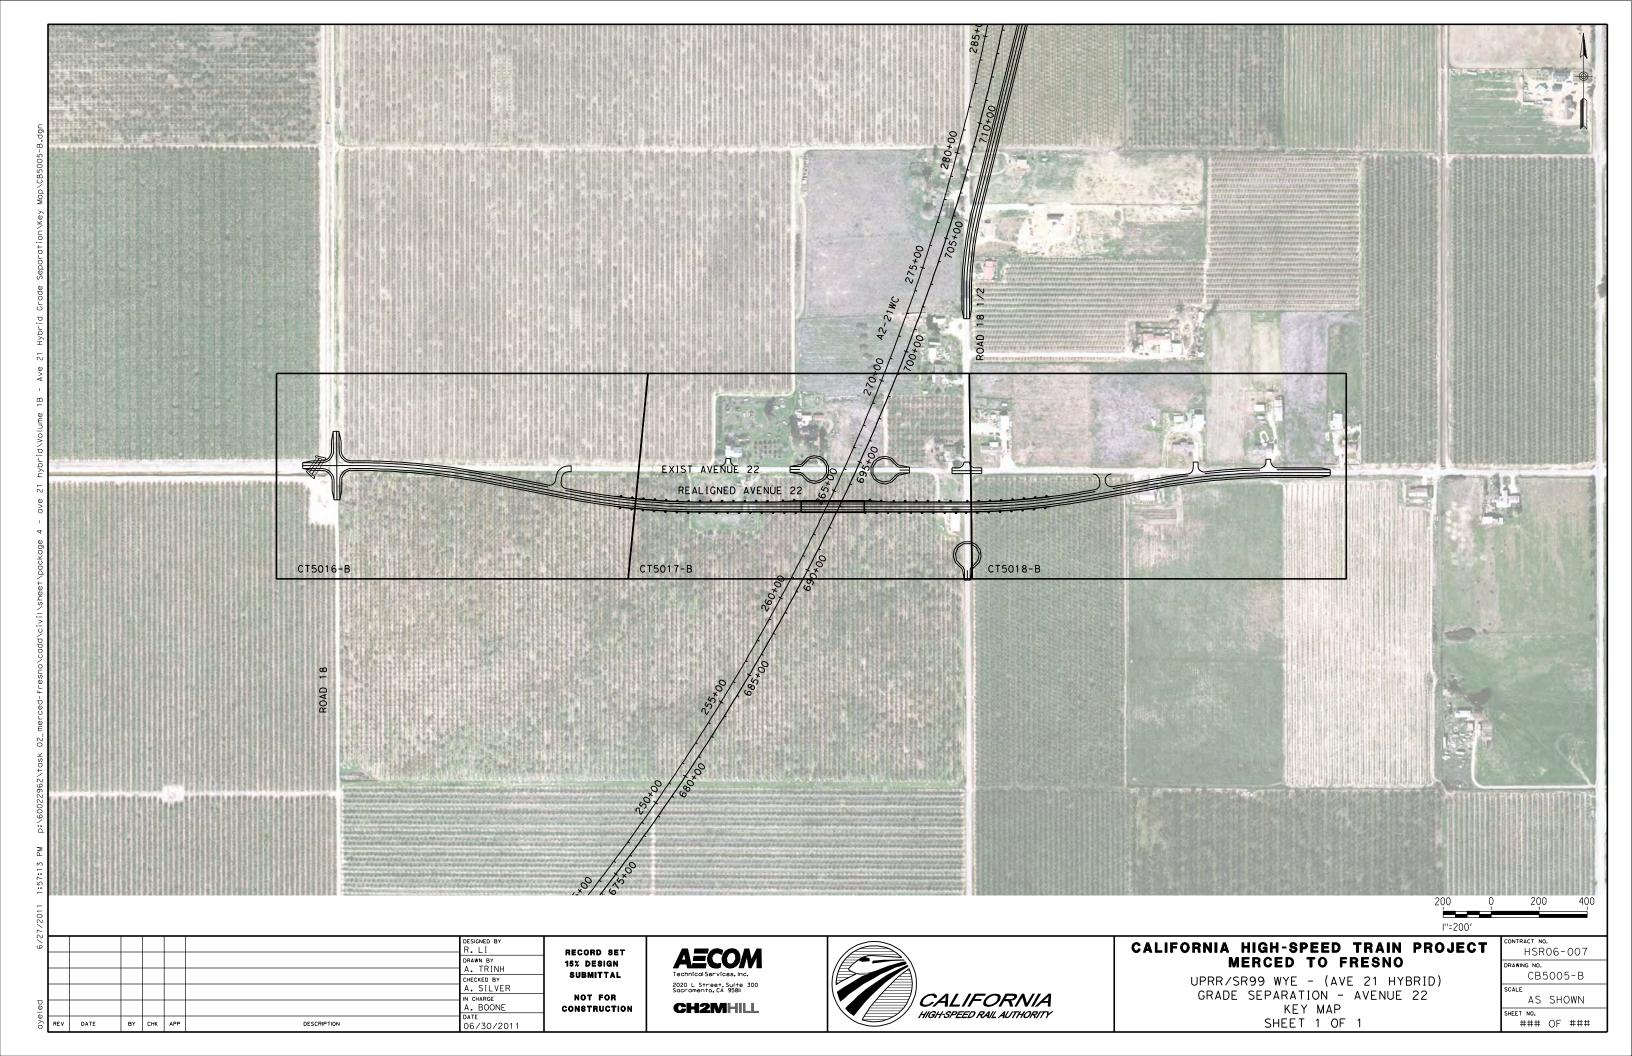

NOTES:

- 1. DIMENSIONS OF EXISTING PAVEMENT WIDTHS ARE BASED ON MEASUREMENTS MADE IN THE FIELD AND ARE APPROXIMATE.
- 2. PAVEMENT SECTIONS ARE TO BE DETERMINED. GEOTECHNICAL INVESTIGATIONS WILL BE CONDUCTED IN A SUBSEQUENT PHASE TO DETERMINE STRUCTURAL SECTIONS FOR EACH
- 3. SPACING OF BENCHES ON PROPOSED FILL SECTIONS ARE TO BE DETERMINED.
- 4. RIGHT-OF-WAY (R/W) WIDTH IS FOR INFORMATION ONLY. EXACT WIDTH TO BE DETERMINED IN COORDINATION WITH AFFECTED AGENCY.

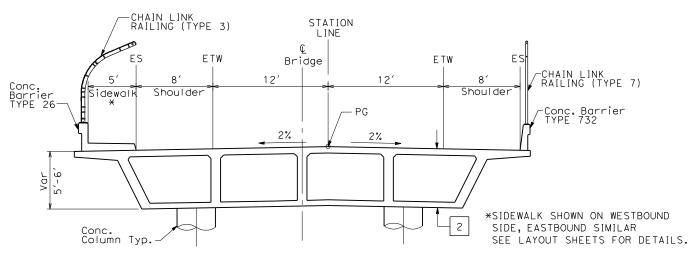

OVERHEAD STRUCTURE


SEE STRUCTURAL PLANS

STATION

STRUCTURAL SECTIONS:

HMA TYPE A AB CLASS 2

CAST IN PLACE / PRESTRESSED BOX GIRDER (6' STRUCTURE DEPTH)

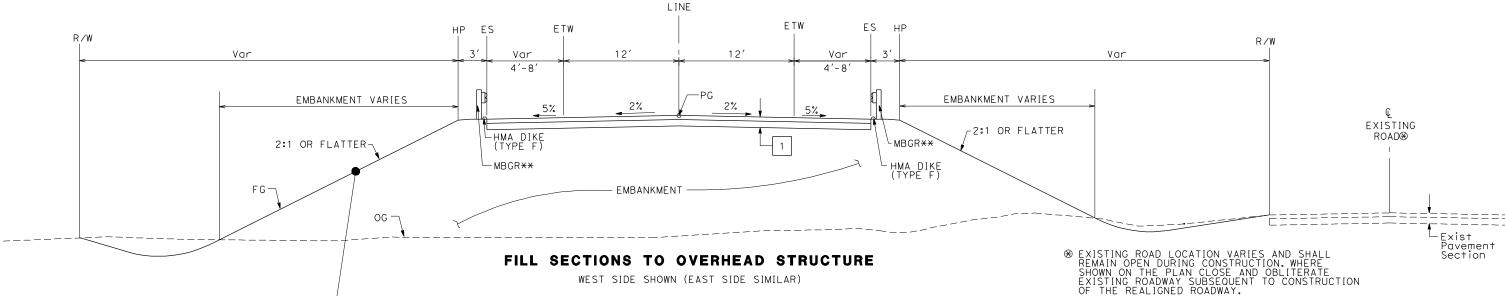

LINE E_.S ES ETW Var Var Var Var 0'-2 11'-12' 11'-12'

-PG

STATION

Exist -Pavement Section

EXISTING LOCAL ROAD

WEST SIDE SHOWN (EAST SIDE SIMILAR) SEE LAYOUT SHEETS FOR ACTUAL ROADWAY WIDTHS AT EACH CROSSING TYPICAL CROSS SECTIONS ON THIS SHEET APPLY TO THE FOLLOWING ROADWAYS FOR AVE 21 HYBRID:

NO.	STREET NAME	NO.	STREET NAME
1	ROAD 16		
2	ROAD 17-1/2	13	AVENUE 17
3	AVENUE 22	14	AVENUE 20
4	AVENUE 21 1/2	15	AVENUE 20 1/2
5	AVENUE 9	16	ROAD 18 1/2
6	AVENUE 10	17	AVENUE 7
7	AVENUE 11	18	G ST
8	AVENUE 12	19	ROAD 20
9	AVENUE 13	20	ROAD 26
10	AVENUE 15	21	ROAD 22
11	AVENUE 15 1/2		

REV	DATE	BY	СНК	APP	DESCRIPTION	DATE 06/30/2011	
1	12/12/2011	RG				A. BOONE	
eyesu						CHECKED BY A. SIL VER	
4/3						DESIGNED BY K. OAKS DRAWN BY K. OAKS	

2%

BENCHING DETAIL

RECORD SET 15% DESIGN SUBMITTAL NOT FOR CONSTRUCTION

OG -

2020 L Street, Suite 300 Sacramento, CA 95811 CH2MHILL




CALIFORNIA HIGH-SPEED TRAIN PROJECT MERCED TO FRESNO


** EXACT LIMITS OF MBGR PER AGENCY REQUIREMENTS.


AVE 21 HYBRID GRADE SEPARATIONS TYPICAL CROSS SECTIONS SHEET 1 OF 1

CONTRACT NO.
HSR06-007
DRAWING NO.
CT4990-B
SCALE
NTS

SHEET NO. ### OF ###

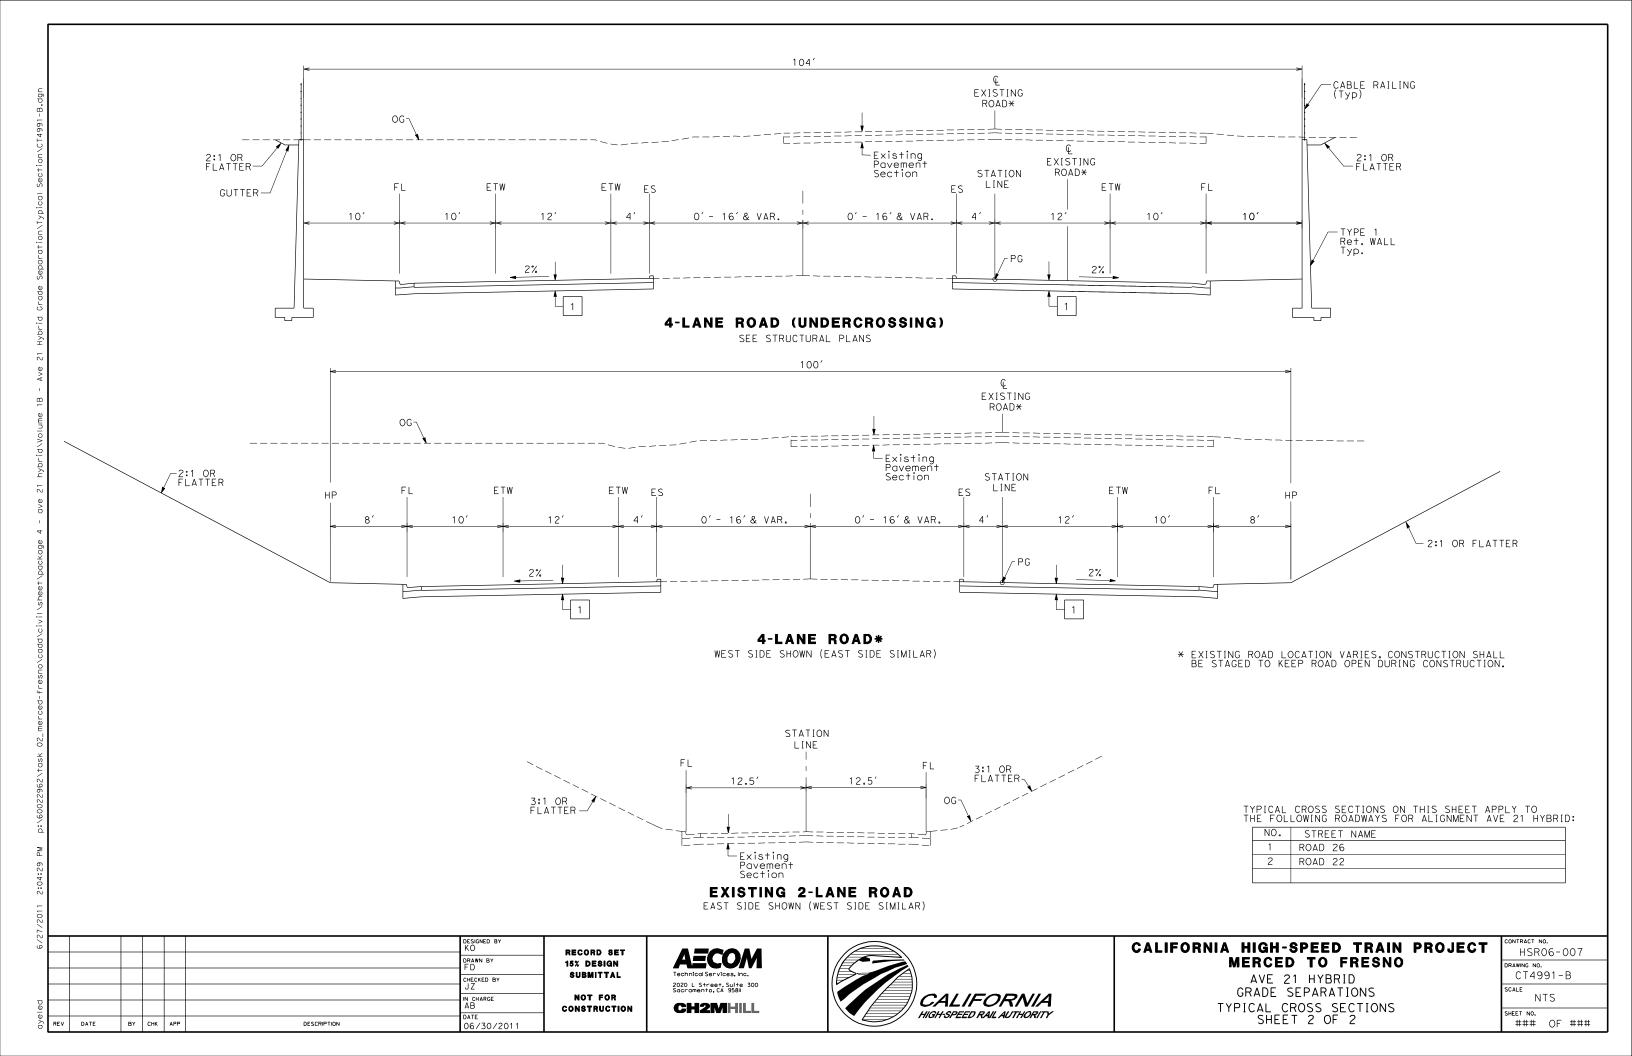

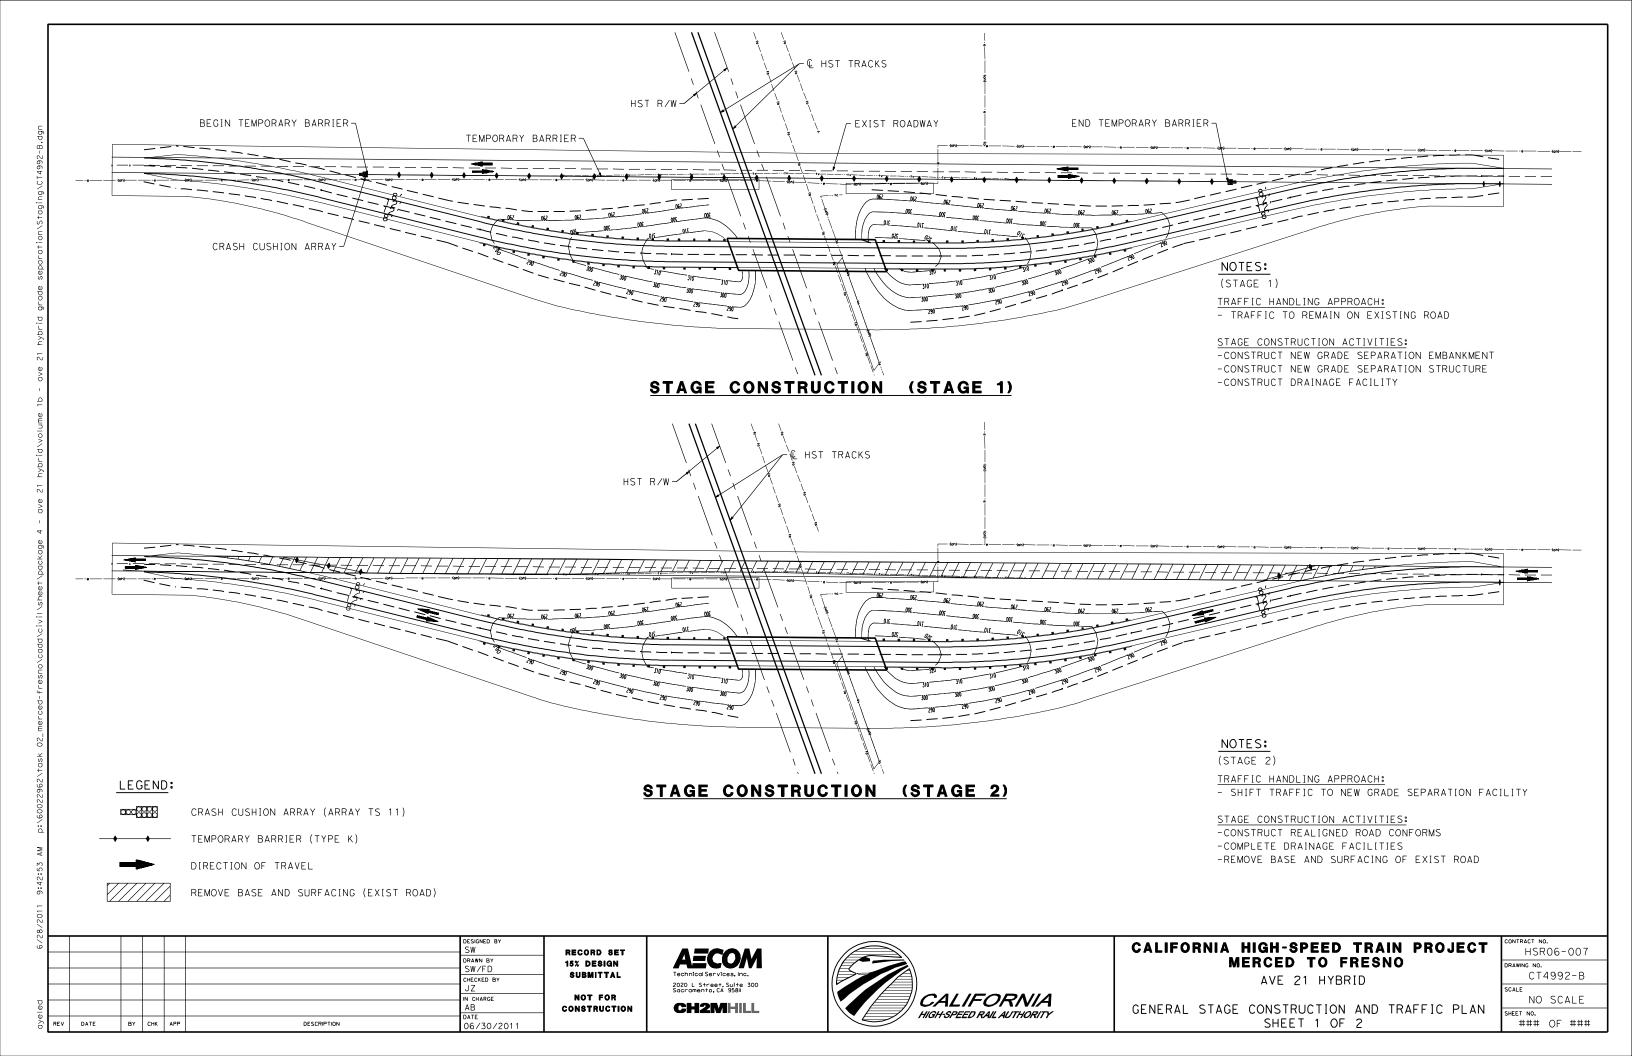

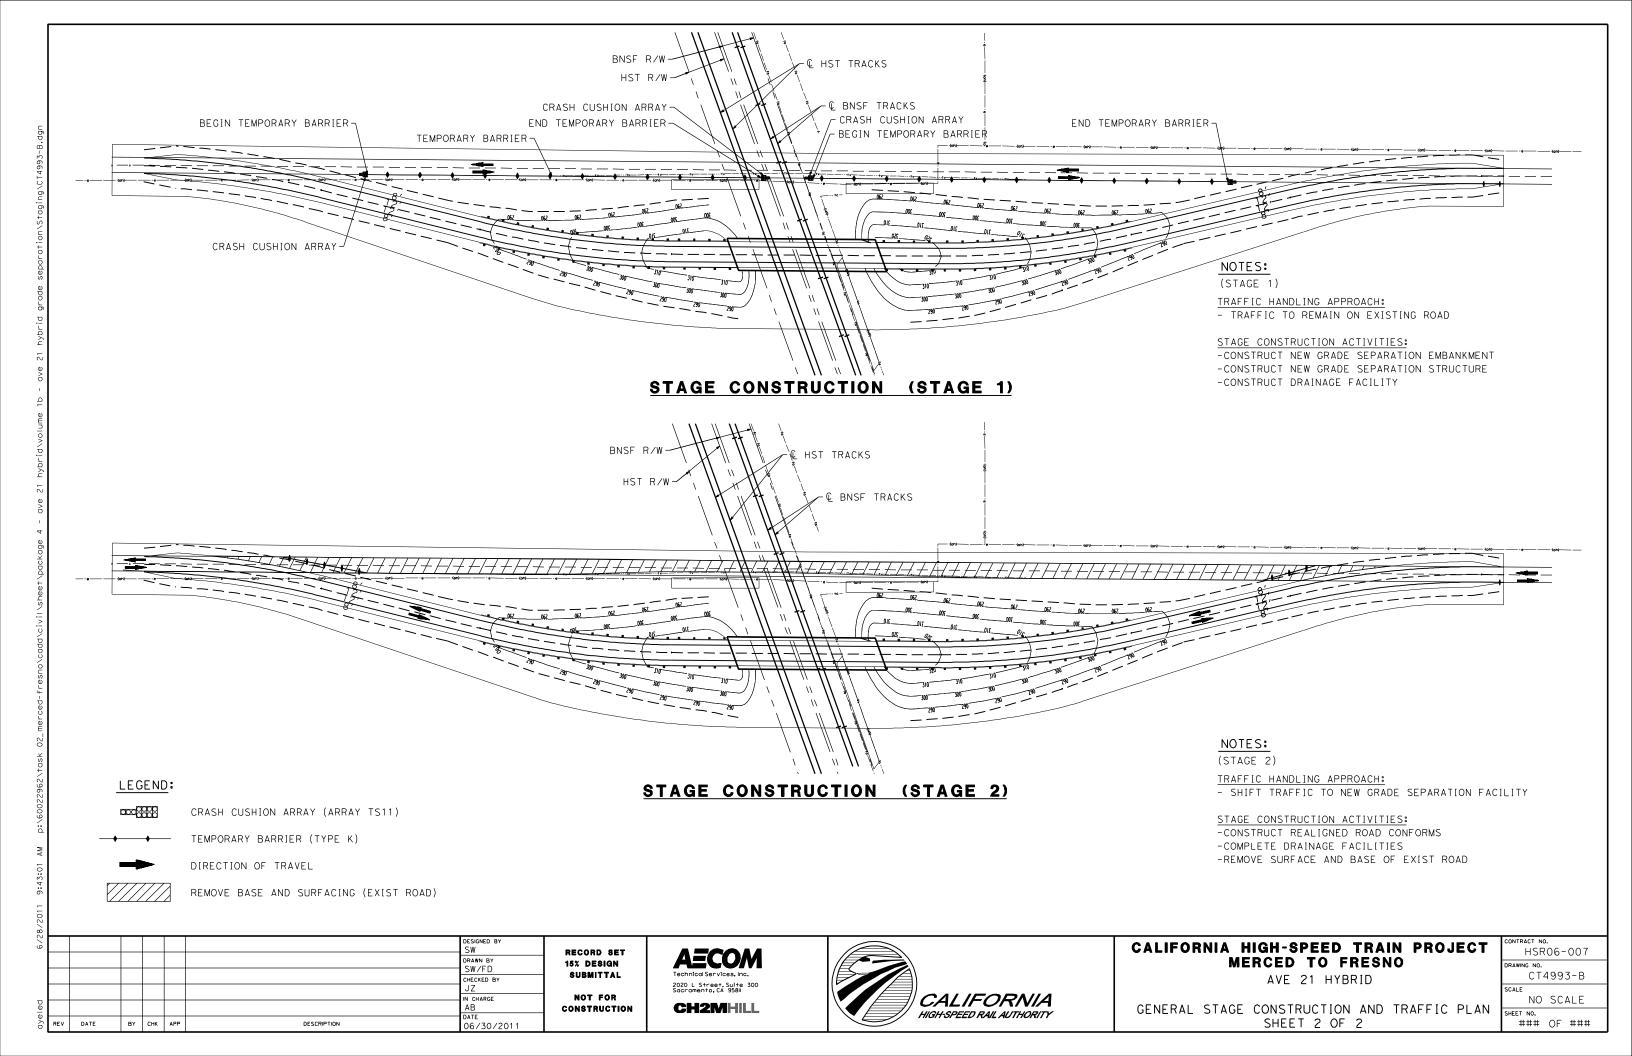

DESIGNED BY R. GIBSON DRAWN BY H. PHAN CHECKED BY
J. ZANDIAN IN CHARGE A. BOONE BY CHK APP DESCRIPTION 06/30/2011

LOCATION 1

AVE 9

NTS

NOTE:

RECORD SET 15% DESIGN SUBMITTAL NOT FOR CONSTRUCTION

2020 L Street, Suite 300 Sacramento, CA 95811 CH2MHILL





BNSF MAIN LINE - (AVE 21 HYBRID) GRADE SEPARATION - AVENUE 9 LAYOUT SHEET 1 OF 3

CONTRACT NO.	
HST06-007	
DRAWING NO.	
CT0001-A	
SCALE	
AS SHOWN	

OF

CURVE DATA

② 5000.00′ 6°52′32" 300.36′ 600.00′ 45 MPH

300.36′ 600.00′ 45 MPH

① 5000.00′ 6°52′32"



1. FOR ROADWAY PROFILE, SEE DRAWINGS CT1000-A THROUGH CT1002-A.

1/2

DESIGNED BY R. GIBSON DRAWN BY H. PHAN CHECKED BY
J. ZANDIAN IN CHARGE A. BOONE BY CHK APP DESCRIPTION 06/30/2011

LOCATION 1

AVE 9

15% DESIGN SUBMITTAL NOT FOR CONSTRUCTION

RECORD SET

AECOM 2020 L Street, Suite 300 Sacramento, CA 95811 CH2MHILL





BNSF MAIN LINE - (AVE 21 HYBRID) GRADE SEPARATION - AVENUE 9 LAYOUT SHEET 2 OF 3


'	CONTRACT NO. HST06-007
	DRAWING NO.
	CT0002-A
	SCALE
	AS SHOWN
	SHEET NO.
	### OF ###

CURVE DATA

3 5000.00' 6°52'32" 300.36' 600.00' 45 MPH

300.36′ 600.00′ 45 MPH

② 5000.00′ 6°52′32"

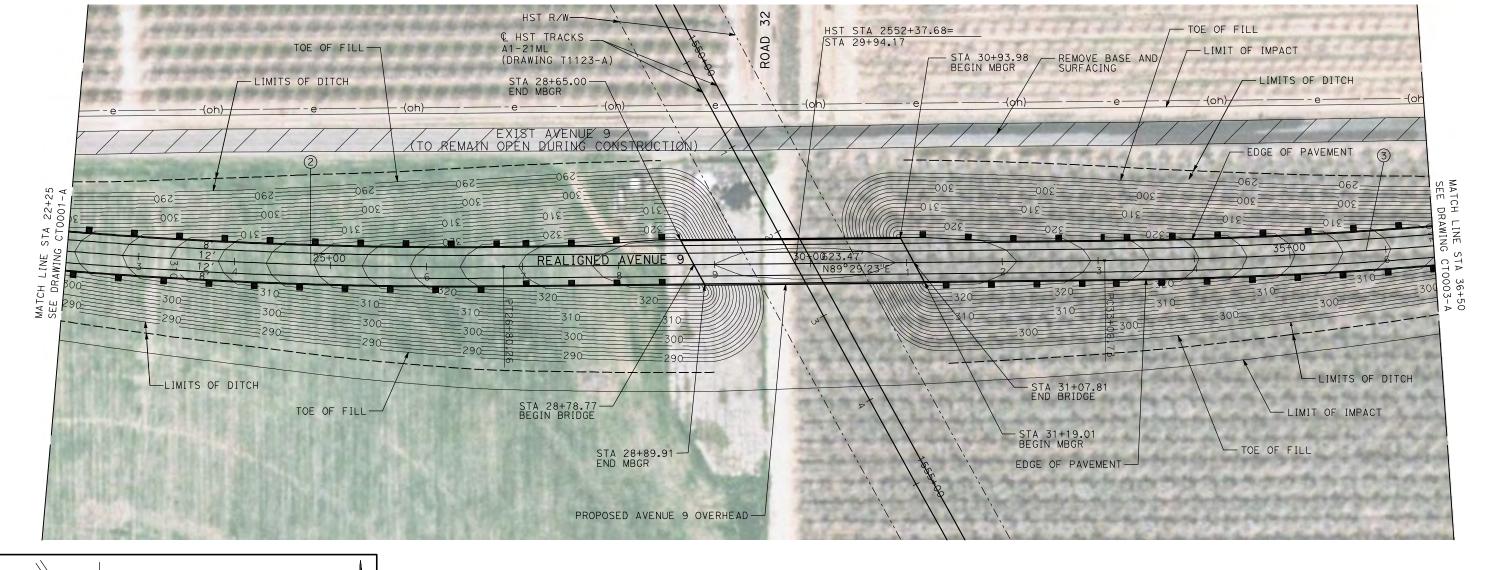


NOTE:

NTS

1. FOR ROADWAY PROFILE, SEE DRAWINGS CT1000-A THROUGH CT1002-A.



CURVE DATA 3 5000.00' 6°52'32" 300.36' 600.00' 45 MPH 4 5000.00' 6°52'32" 300.36' 600.00' 45 MPH

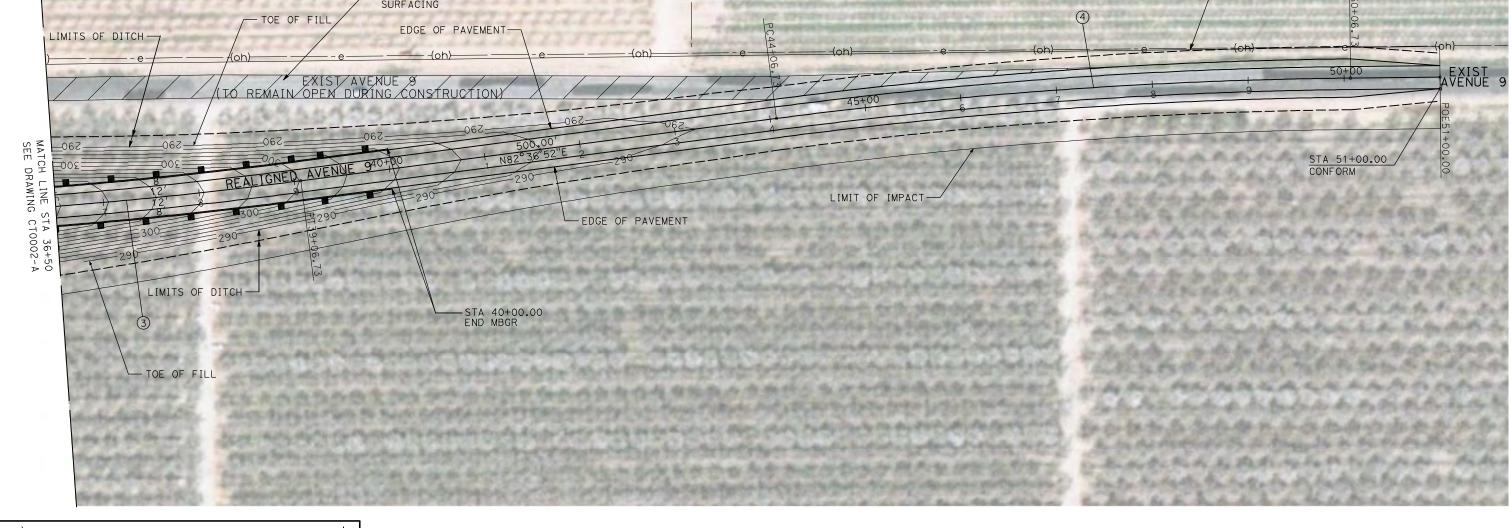

DESCRIPTION

BY CHK APP



CALIFORNIA HIGH-SPEED TRAIN PROJECT MERCED TO FRESNO

BNSF MAIN LINE - (AVE 21 HYBRID) GRADE SEPARATION - AVENUE 9 LAYOUT SHEET 3 OF 3

CONTRA		06-007	
DRAWIN		003-A	
SCALE	AS	SHOWN	
SHEET	NO.		

OF

IZ/28/II RG
V DATE BY CHK APP DESCRIPTION

AVE 10

RECORD SET
15% DESIGN
SUBMITTAL
NOT FOR
CONSTRUCTION

NTS

R. GIBSON

CHECKED BY
J. ZANDIAN

RAWN BY

n charge A. BOONE AECOM
Technical Services, Inc.
2020 L Street, Suite 300
Sacramento, CA 958II
CH2MHILL

1. FOR PROFILES, SEE DRAWINGS CT1003-A THROUGH CT1005-A.



CALIFORNIA HIGH-SPEED TRAIN PROJECT MERCED TO FRESNO


BNSF MAIN LINE - (AVE 21 HYBRID)
GRADE SEPARATION - AVENUE 10
LAYOUT
SHEET 1 OF 3

T	HST06-007
	DRAWING NO. CTOOO4-A
	SCALE

CURVE DATA


① 5000.00′ 6°52′32" 300.36′ 600.00′ 45 MPH ② 5000.00′ 6°52′32" 300.36′ 600.00′ 45 MPH

AS SHOWN
SHEET NO.
OF

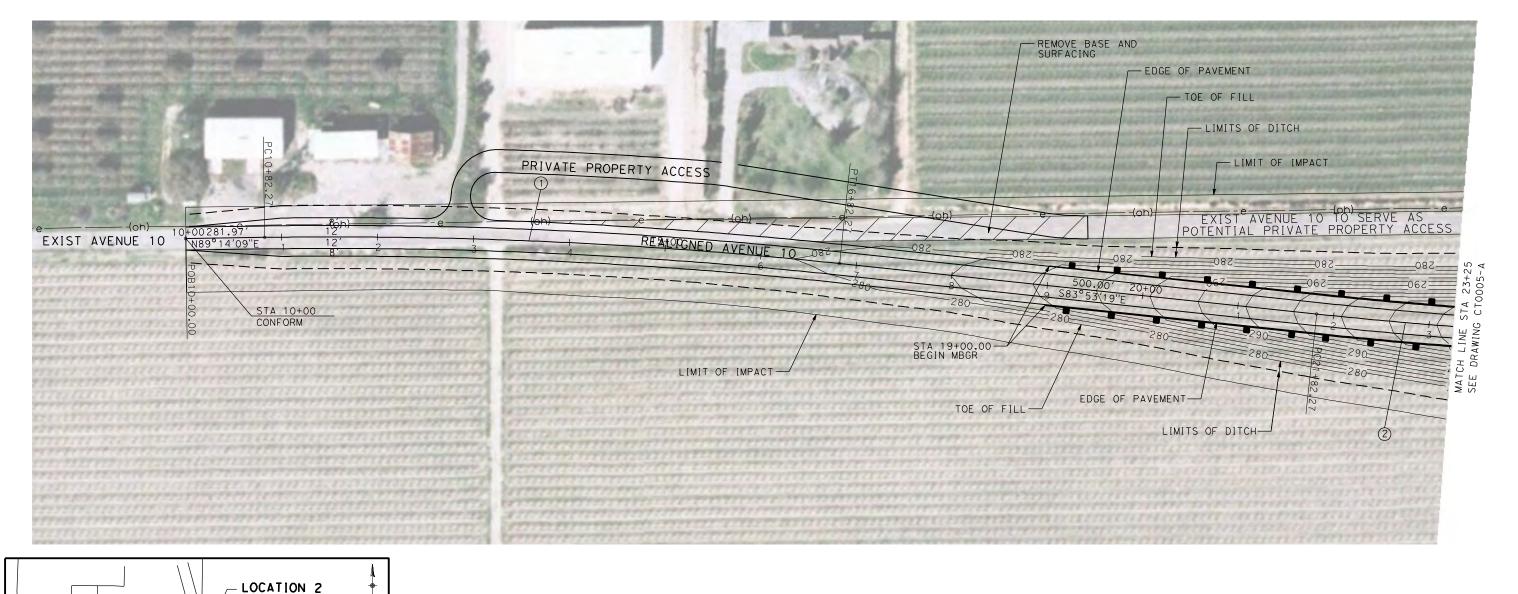



12/28/11

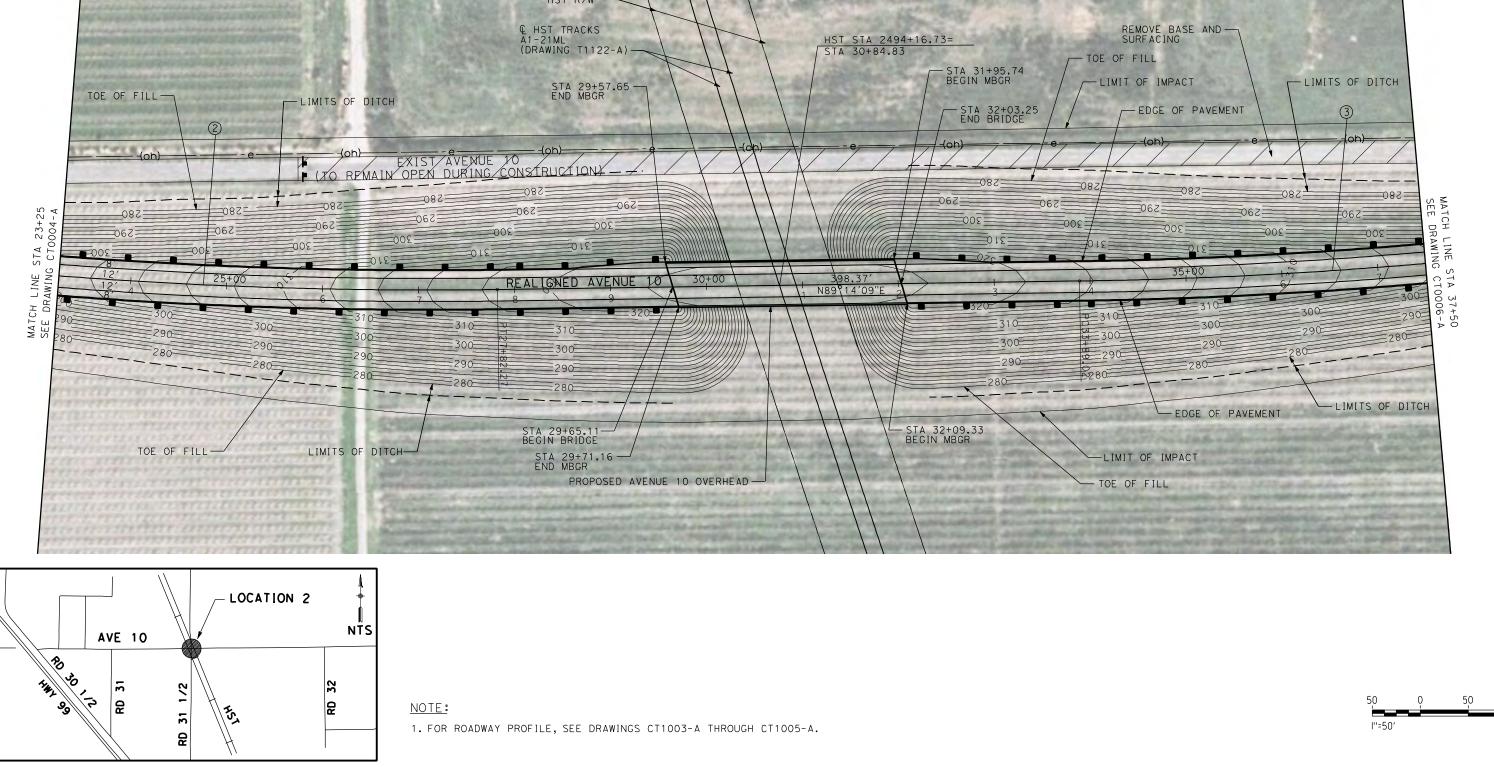

CALIFORNIA

HIGH-SPEED RAIL AUTHORITY

R. GIBSON

CHECKED BY
J. ZANDIAN

n charge A. BOONE

DESCRIPTION

RAWN BY

RECORD SET

SUBMITTAL

NOT FOR

CONSTRUCTION

2020 L Street, Suite 300 Socramento, CA 95811

CH2MHILL

15% DESIGN

CURVE DATA

3 5000.00' 6°52'32" 300.36' 600.00' 45 MPH

CALIFORNIA HIGH-SPEED TRAIN PROJECT

MERCED TO FRESNO

BNSF MAIN LINE - (AVE 21 HYBRID)

GRADE SEPARATION - AVENUE 10

LAYOUT

SHEET 2 OF 3

300.36' 600.00' 45 MPH

HST06-007


CT0005-A


AS SHOWN

OF


AWING NO.

12/28/11

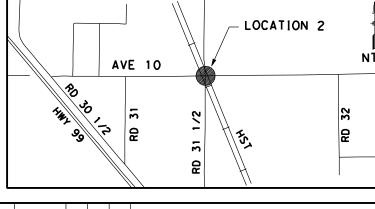

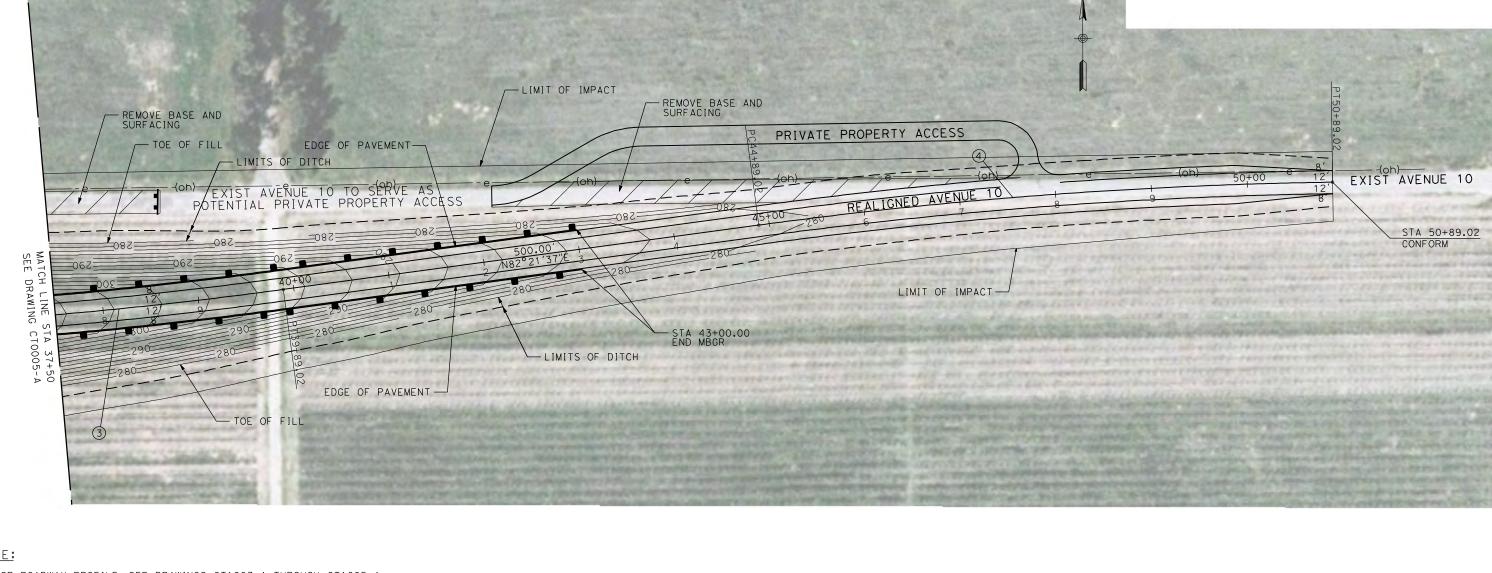

1. FOR ROADWAY PROFILE, SEE DRAWINGS CT1003-A THROUGH CT1005-A.

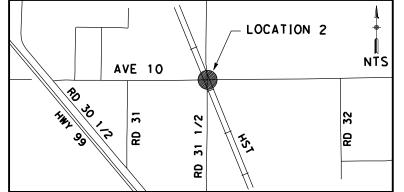

DESCRIPTION

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CH2MHILL



CALIFORNIA HIGH-SPEED TRAIN PROJECT MERCED TO FRESNO

BNSF MAIN LINE - (AVE 21 HYBRID) GRADE SEPARATION - AVENUE 10 LAYOUT SHEET 3 OF 3

	CONTRACT NO. HST06-007 DRAWING NO. CT0006-A			
	SCALE A	S	SHO	NWC
	SHEET NO ###		OF	###

CURVE DATA
 NO.
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 ∆
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 ③
 5000.00′
 6°52′32″
 300.36′
 600.00′
 45 MPH
 4 5000.00' 6°52'32" 300.36' 600.00' 45 MPH

RAWN BY 15% DESIGN CHECKED BY
J. ZANDIAN n charge A. BOONE CONSTRUCTION

R. GIBSON

RECORD SET

SUBMITTAL

NOT FOR

LOCATION 3-

AVE 11

R. GIBSON RAWN BY CHECKED BY
J. ZANDIAN n charge A. BOONE 12/28/11 DESCRIPTION

31 1/2

NTS

RECORD SET 15% DESIGN SUBMITTAL NOT FOR CONSTRUCTION

2020 L Street, Suite 300 Socramento, CA 95811 CH2MHILL

1. FOR ROADWAY PROFILE, SEE DRAWINGS CT1006-A THROUGH CT1008-A.




CALIFORNIA HIGH-SPEED TRAIN PROJECT MERCED TO FRESNO

BNSF MAIN LINE - (AVE 21 HYBRID) GRADE SEPARATION - AVENUE 11 LAYOUT SHEET 1 OF 3

Г	CONTRACT NO. HST06-007				
	113100-001				
	DRAWING NO.				
	CT0007-A				
	SCALE				
	AS SHOWN				

SHEET NO. ### OF ###

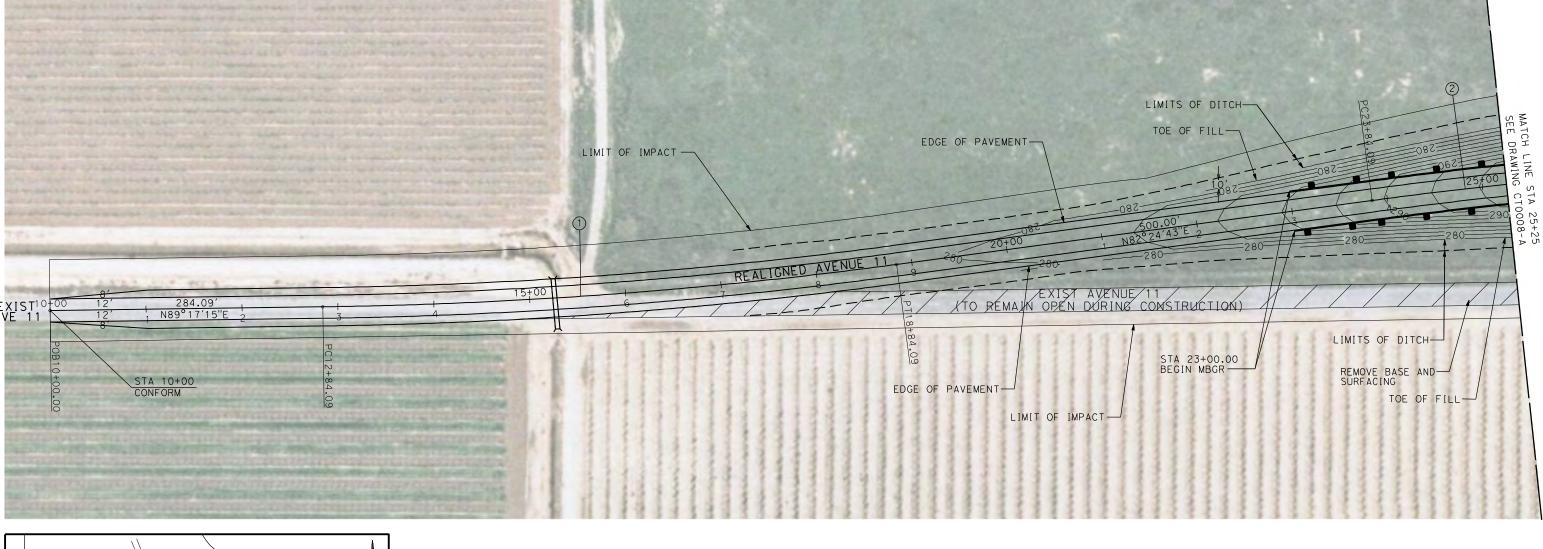

② 5000.00′ 6°52′32" 300.36′ 600.00′ 45 MPH

CURVE DATA

300.36′ 600.00′ 45 MPH

LOCATION 3-

AVE 11

DESIGNED BY R. GIBSON RAWN BY CHECKED BY
J. ZANDIAN IN CHARGE A. BOONE 12/28/11 BY CHK APP DESCRIPTION 07/27/2011

15% DESIGN SUBMITTAL NOT FOR CONSTRUCTION

RECORD SET

HST R/W -

Q HST TRACKS A1-21ML (DRAWING T1121-A)

STA 31+77.58-BEGIN BRIDGE

STA 31+73.25 END MBGR —

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HST STA 2437+20.18= STA 32+85.63

466.66′ V \ 2N89° \ 7′15"E \ \

STA 33+89.95 BEGIN MBGR

-STA 33+94.28 END BRIDGE



BNSF MAIN LINE - (AVE 21 HYBRID) GRADE SEPARATION - AVENUE 11 LAYOUT

•	CONTRACT NO. HST06-007				
	DRAWING NO. CTOOO8-A				
	SCALE AS SHOWN				
	SHEET NO. ### OF ###				

SHEET 2 OF 3

062 008 006	300	280 280 280 280 280 280 280 280
0	7	L INE
290 280 280	290 280	290 290 290 W W Z Z Z Z Z Z Z Z Z Z Z Z Z Z Z Z Z
ТС	DE OF FILL	444444444
	DE OF FILL PAVEMENT	REMOVE BASE AND SURFACING

- EDGE OF PAVEMENT

- LIMIT OF IMPACT

CURVE DATA

② 5000.00′ 6°52′32" 300.36′ 600.00′ 45 MPH 3 3000.00' 8°44'53" 229.47' 458.05' 45 MPH

- LIMITS OF DITCH

TOE OF FILL

NTS 31

LIMITS OF DITCH-TOE OF FILL-

TOE OF FILL-

LIMITS OF DITCH-

(TO REMAIN OPEN DURING CONSTRUCTION)

LIMIT OF IMPACT -

1. FOR ROADWAY PROFILE, SEE DRAWINGS CT1006-A THROUGH CT1008-A.

PROPOSED AVENUE 11 OVERHEAD —

LOCATION 3-

AVE 11

DESIGNED BY R. GIBSON DRAWN BY H. PHAN CHECKED BY
J. ZANDIAN IN CHARGE A. BOONE 12/28/11 DATE 07/27/2011 BY CHK APP DESCRIPTION

RECORD SET 15% DESIGN SUBMITTAL NOT FOR CONSTRUCTION CH2MHILL



MERCED TO FRESNO

GRADE SEPARATION - AVENUE 11 LAYOUT SHEET 3 OF 3

-	CONTRACT NO.				
	HST06-007				
-	113100-001				
	DRAWING NO.				
	CT0009-A				
	SCALE				
	AS SHOWN				
	AS SHOWN				
	SHEET NO.				
	### OF ###				

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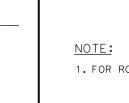
 ④
 3000.00′
 8°44′53″
 229.47′
 458.05′
 45 MPH

CALIFORNIA HIGH-SPEED TRAIN PROJECT BNSF MAIN LINE - (AVE 21 HYBRID)

LIMITS OF DITCH TOE OF FILL EDGE OF PAVEMENT STA 42+00.00 END MBGR	LIMIT OF IMPACT	
WATCH LINE STATE OF THE STATE O	45+00	
REMOVE BASE AND SURFACING TOE OF FILL LIMIT OF IMPACT	EDGE OF PAVEMENT LIMITS OF DITCH STA 49+24.29 CONFORM	



1. FOR ROADWAY PROFILE, SEE DRAWINGS CT1006-A THROUGH CT1008-A.





LOCATION 5-

AVE 13

DESIGNED BY R. GIBSON DRAWN BY H. PHAN CHECKED BY
J. ZANDIAN N CHARGE A. BOONE 12/28/11 BY CHK APP DESCRIPTION 07/27/2011

AVE 13

15% DESIGN SUBMITTAL NOT FOR CONSTRUCTION

RECORD SET

NTS

NOTE:

B

2020 L Street, Suite 300 Sacramento, CA 95811 CH2MHILL

1. FOR ROADWAY PROFILE, SEE DRAWINGS CT1012-A THROUGH CT1014-A.



CALIFORNIA HIGH-SPEED TRAIN PROJECT MERCED TO FRESNO

BNSF MAIN LINE - (AVE 21 HYBRID) GRADE SEPARATION - AVENUE 13 LAYOUT SHEET 1 OF 4


Γ	HST06-007			
	DRAWIN		0013-A	
	SCALE			
		ΑS	SHOWN	

CURVE DATA
 NO.
 R
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 T
 L
 V

 ①
 5000.00′
 6°52′32″
 300.36′
 600.00′
 45 MPH
 ② 5000.00′ 6°52′32" 300.36′ 600.00′ 45 MPH

SHEET NO. ### OF ###

	PC10+62.86	LIMIT OF IMPACT	TOE OF FILL	EDGE OF PAVEMENT	LIMITS OF DITCH— ②
PRINCIPLE TO STATE OF THE PARTY	10±280 .97′ 12′ 12′ 12′ 12′ 8′ 12′ 8′ 12′ 8′ 12′ 12′ 12′ 12′ 12′ 12′ 12′ 12′ 12′ 12	REALIGNED AVENUE+003	60 N 80 60		
(oh)	-e	e(oh)	C 7 (01)	e	1 NE STA 2 3 4 1 2 5 0 0 0 0 0 0 0 0 0 0 0 0 0 0 0 0 0 0
tan		LIMIT OF IMPACT————————————————————————————————————	PROPOSED ROAD 301/2 (SEE DRAWING CR4000-A)	R=25' STA 20+00.00 BEGIN MBGR EDGE OF PAVEMENT	300 300 300 SEE DRA
	'n	LIM	IIT OF IMPACT	TOE OF FILL— LIMIT OF IMPACT LIMITS OF DI LI	TCH— IMIT OF IMPACT—

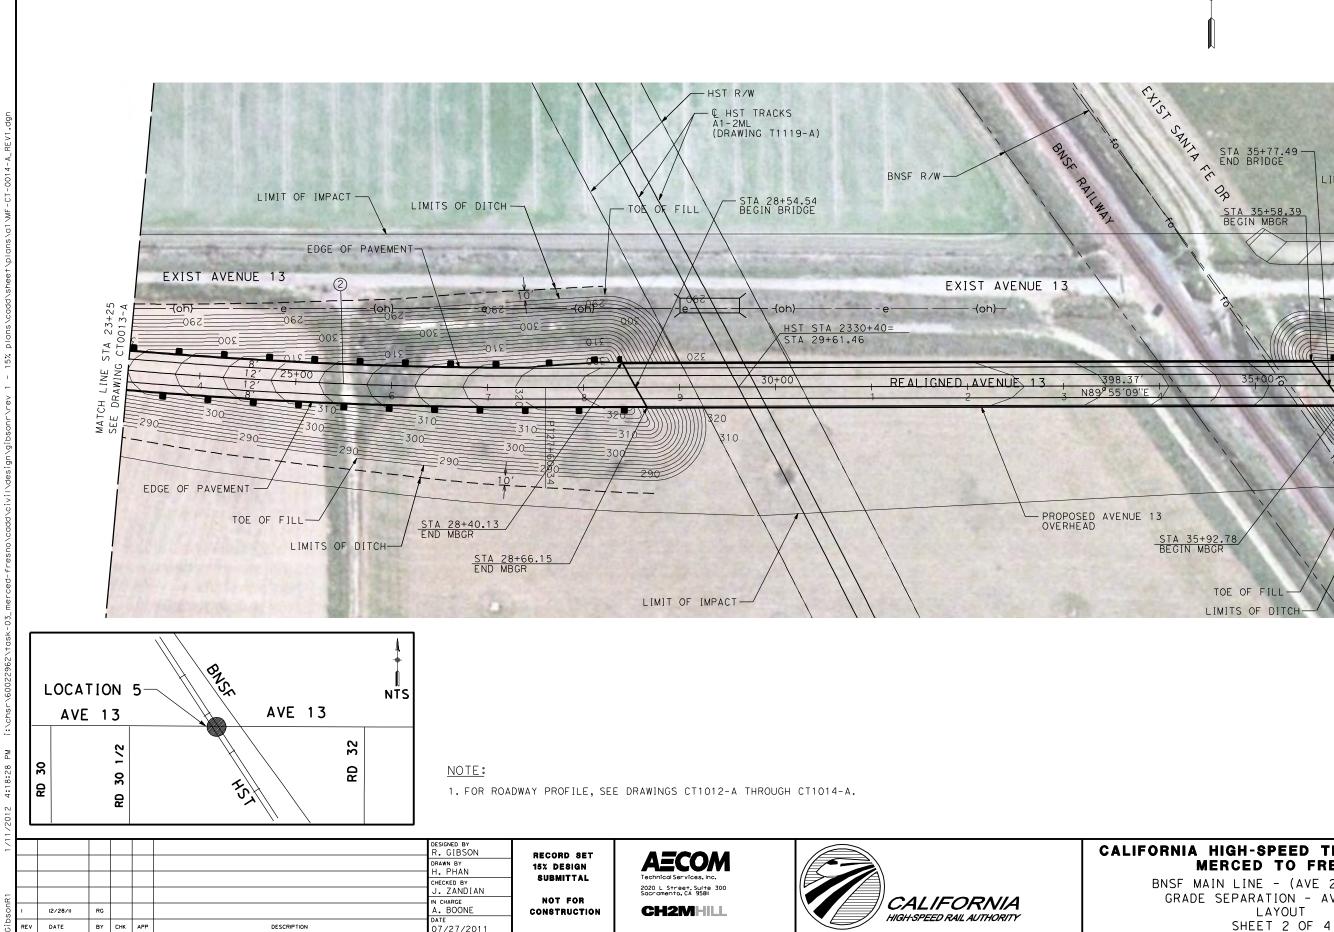

CALIFORNIA HIGH-SPEED TRAIN PROJECT MERCED TO FRESNO BNSF MAIN LINE - (AVE 21 HYBRID) GRADE SEPARATION - AVENUE 13

CURVE DATA

② 5000.00' 6°52'32" 300.36' 600.00' 45 MPH

TOE OF FILL -

LIMITS OF DITCH -

HST06-007 AWING NO. CT0014-A AS SHOWN HEET NO. ### OF ###

S S

LOCATION 5-

AVE 13

R. GIBSON RAWN BY CHECKED BY
J. ZANDIAN n charge A. BOONE 12/28/11 BY CHK APP DESCRIPTION

AVE 13

NÎS

NOTE:

8

15% DESIGN SUBMITTAL NOT FOR CONSTRUCTION

RECORD SET

2020 L Street, Suite 300 Socramento, CA 95811 CH2MHILL

1. FOR ROADWAY PROFILE, SEE DRAWINGS CT1012-A THROUGH CT1014-A.



CALIFORNIA HIGH-SPEED TRAIN F MERCED TO FRESNO


BNSF MAIN LINE - (AVE 21 HYBRID) GRADE SEPARATION - AVENUE 13 LAYOUT SHEET 3 OF 4

CONTRACT NO.				
HST06-007				
DRAWING NO.				
CT0015-A				
SCALE				
AS SHOWN				
SHEET NO.				
### OF ###				

I''=50'	
PROJECT	CONTRACT NO.
	HST06-007

CURVE DATA

3 5000.00′ 6°49′51" 298.41′ 596.11′ 45 MPH 4 5000.00′ 6°52′32" 300.36′ 600.00′ 45 MPH

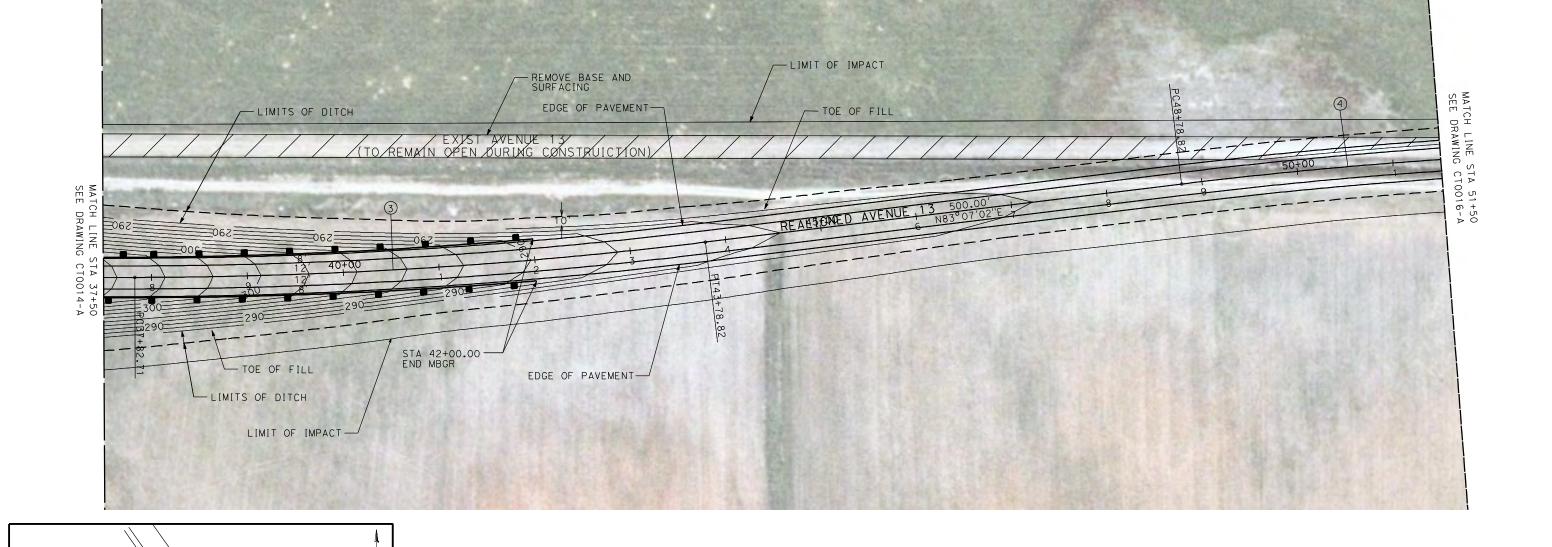

LOCATION 5-

AVE 13

S S

DESIGNED BY R. GIBSON RAWN BY CHECKED BY
J. ZANDIAN N CHARGE A. BOONE 12/28/11 07/27/2011 BY CHK APP DESCRIPTION

AVE 13

NÎS

8


RECORD SET 15% DESIGN SUBMITTAL NOT FOR CONSTRUCTION **AECOM** 2020 L Street, Suite 300 Sacramento, CA 95811 CH2MHILL




CALIFORNIA HIGH-SPEED TRAIN PROJECT MERCED TO FRESNO

BNSF MAIN LINE - (AVE 21 HYBRID) GRADE SEPARATION - AVENUE 13 LAYOUT SHEET 4 OF 4

CONTRACT NO. HST06-007
DRAWING NO. CTOO16-A
SCALE AS SHOWN
SHEET NO. ### OF ###

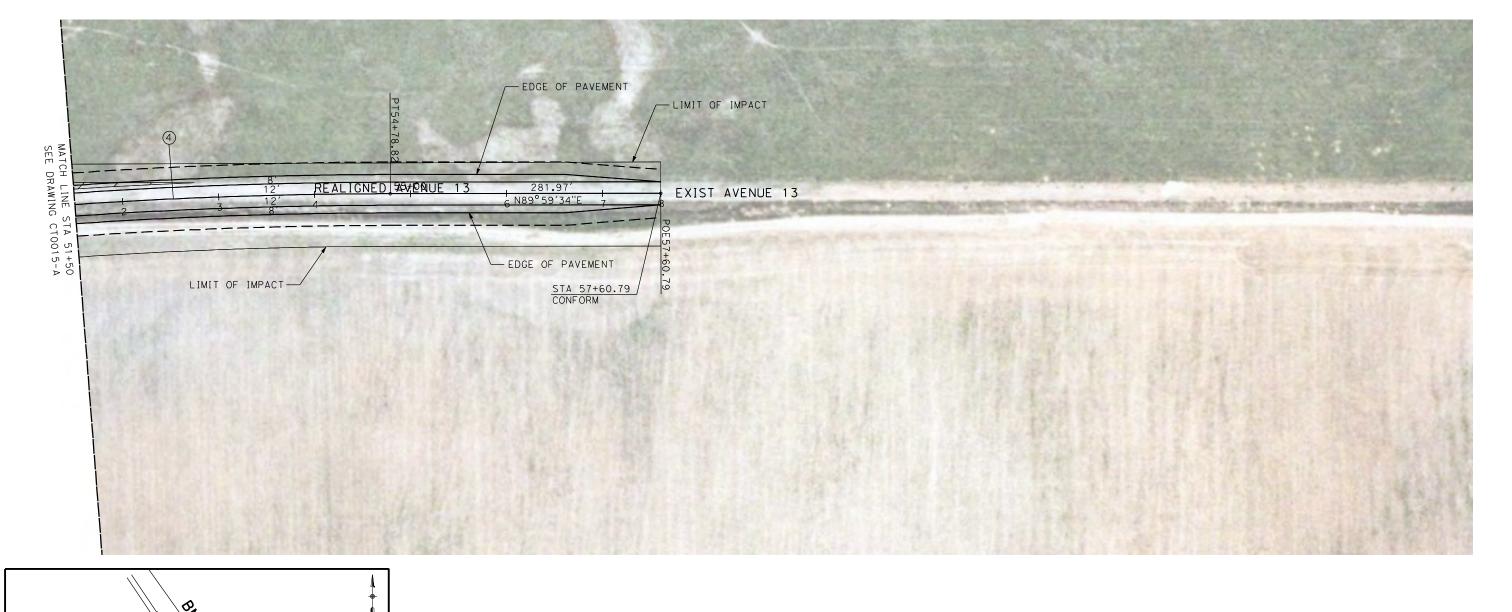



1. FOR ROADWAY PROFILE, SEE DRAWINGS CT1012-A THROUGH CT1014-A.

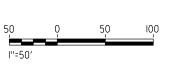


CURVE DATA
 NO.
 R
 ∆
 T
 L
 V

 ②
 5000.00′
 6°52′32″
 300.36′
 600.00′
 45 MPH

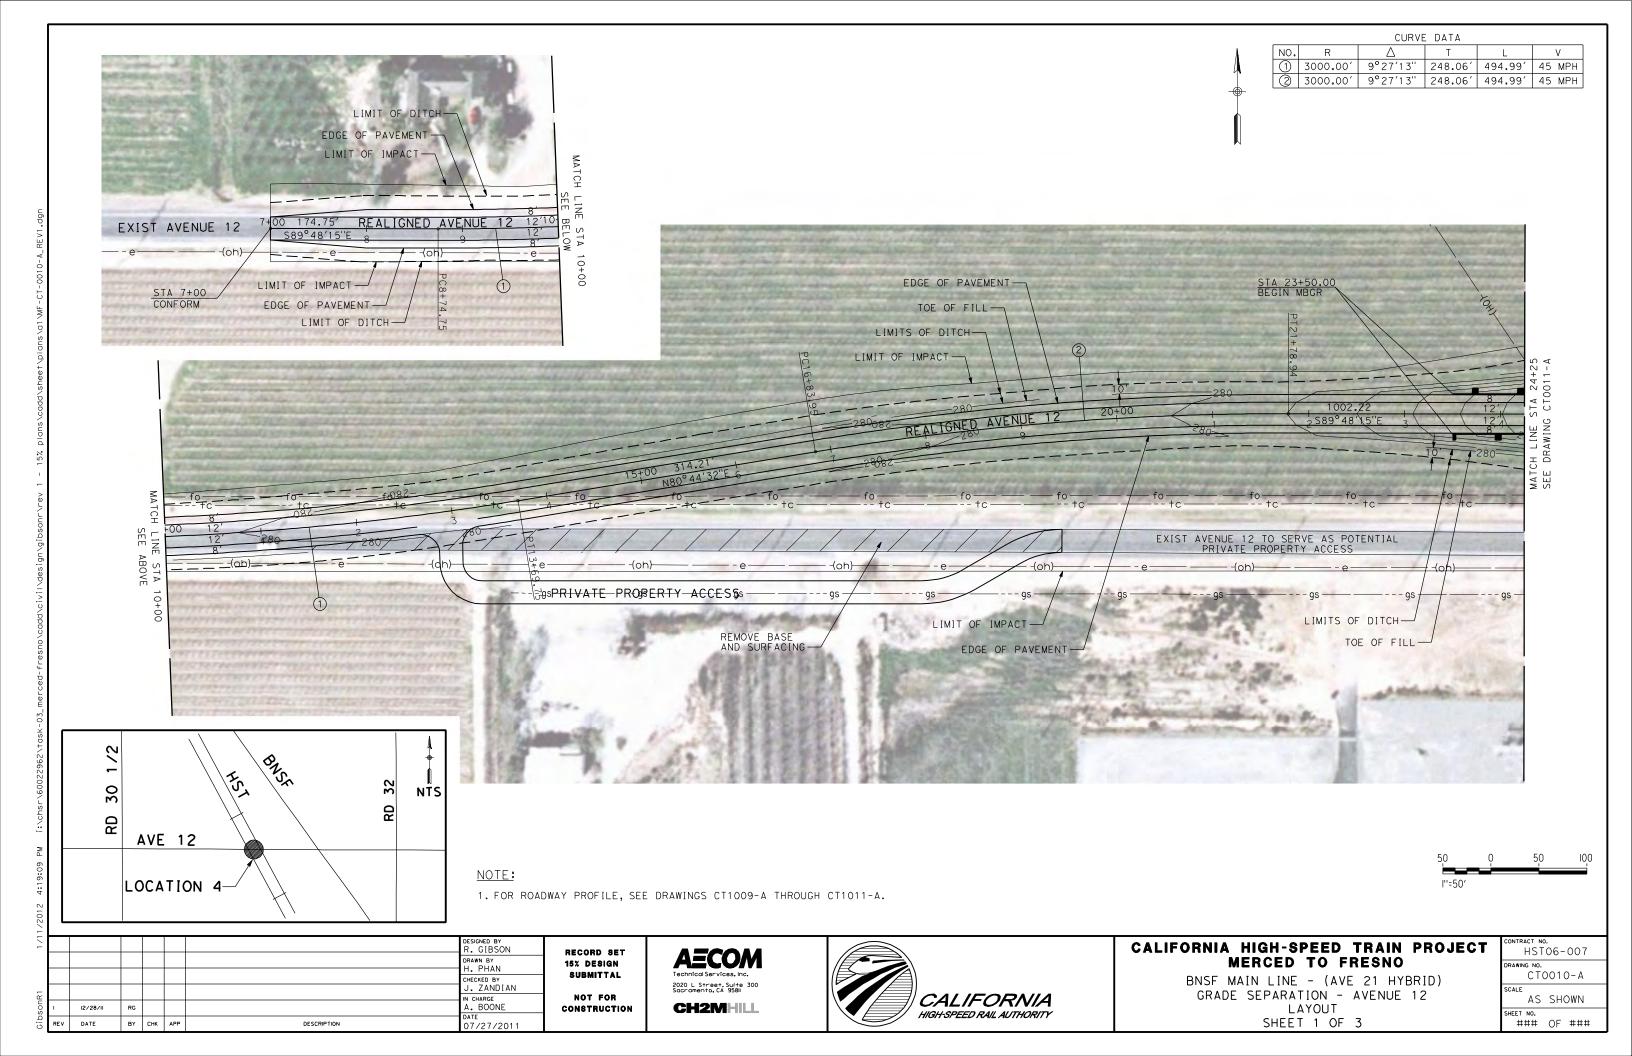

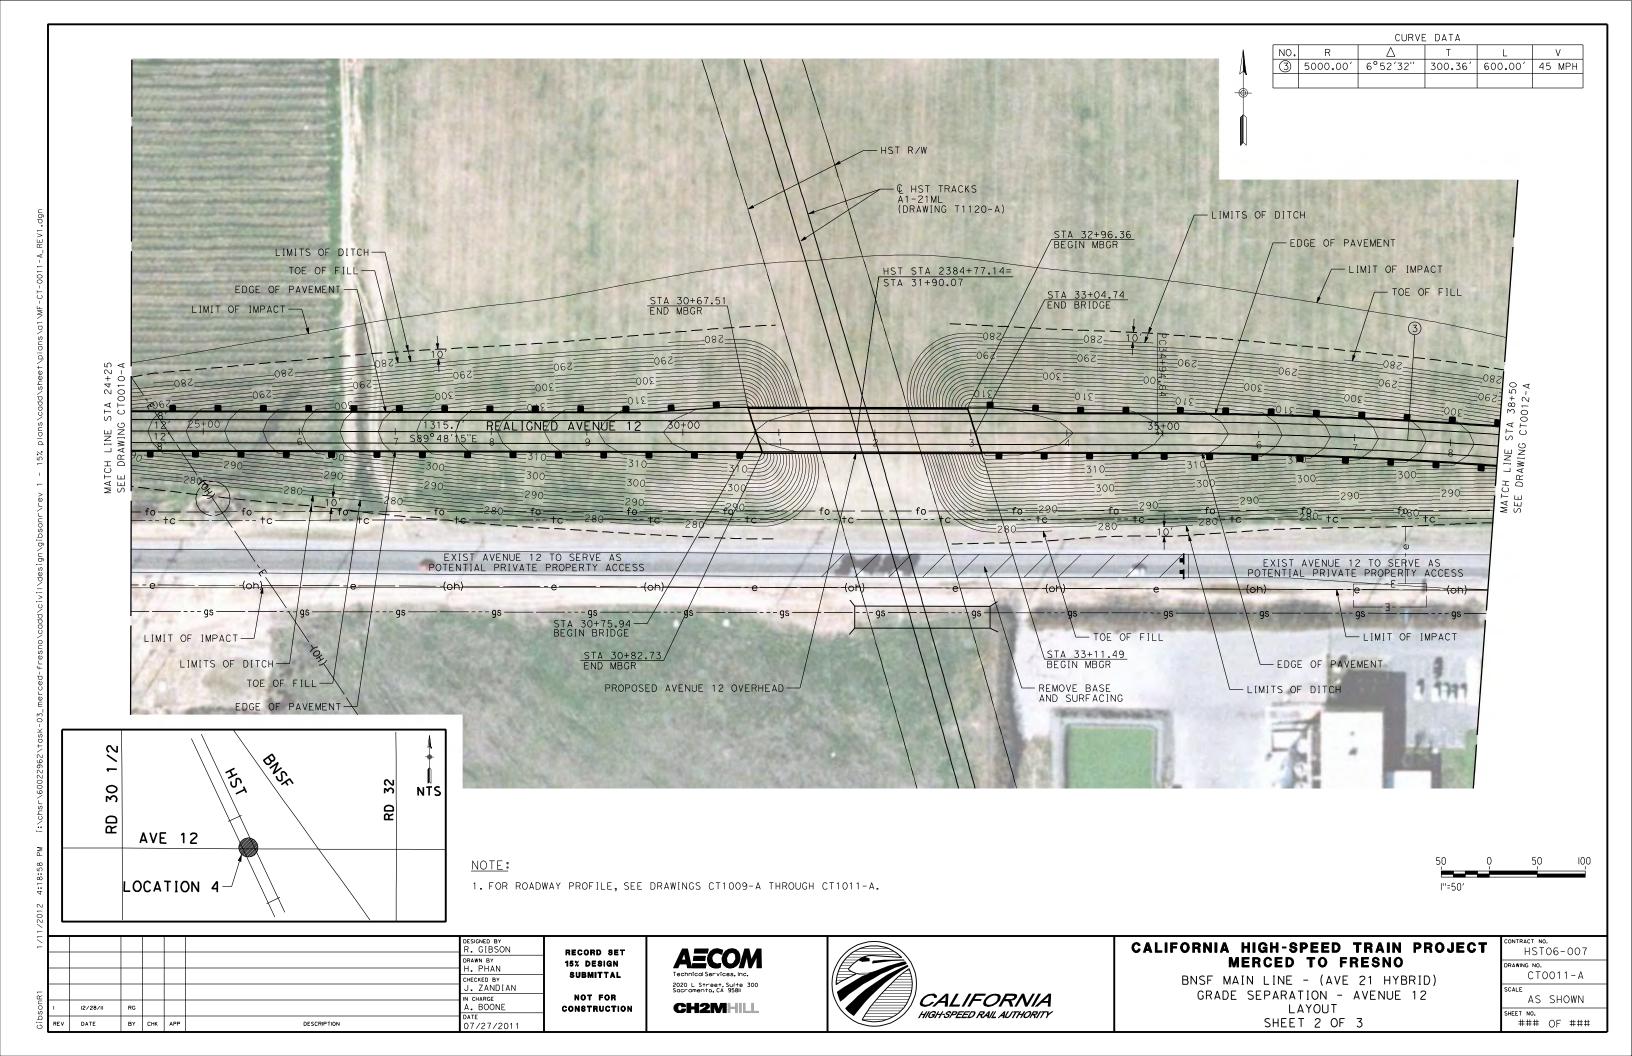

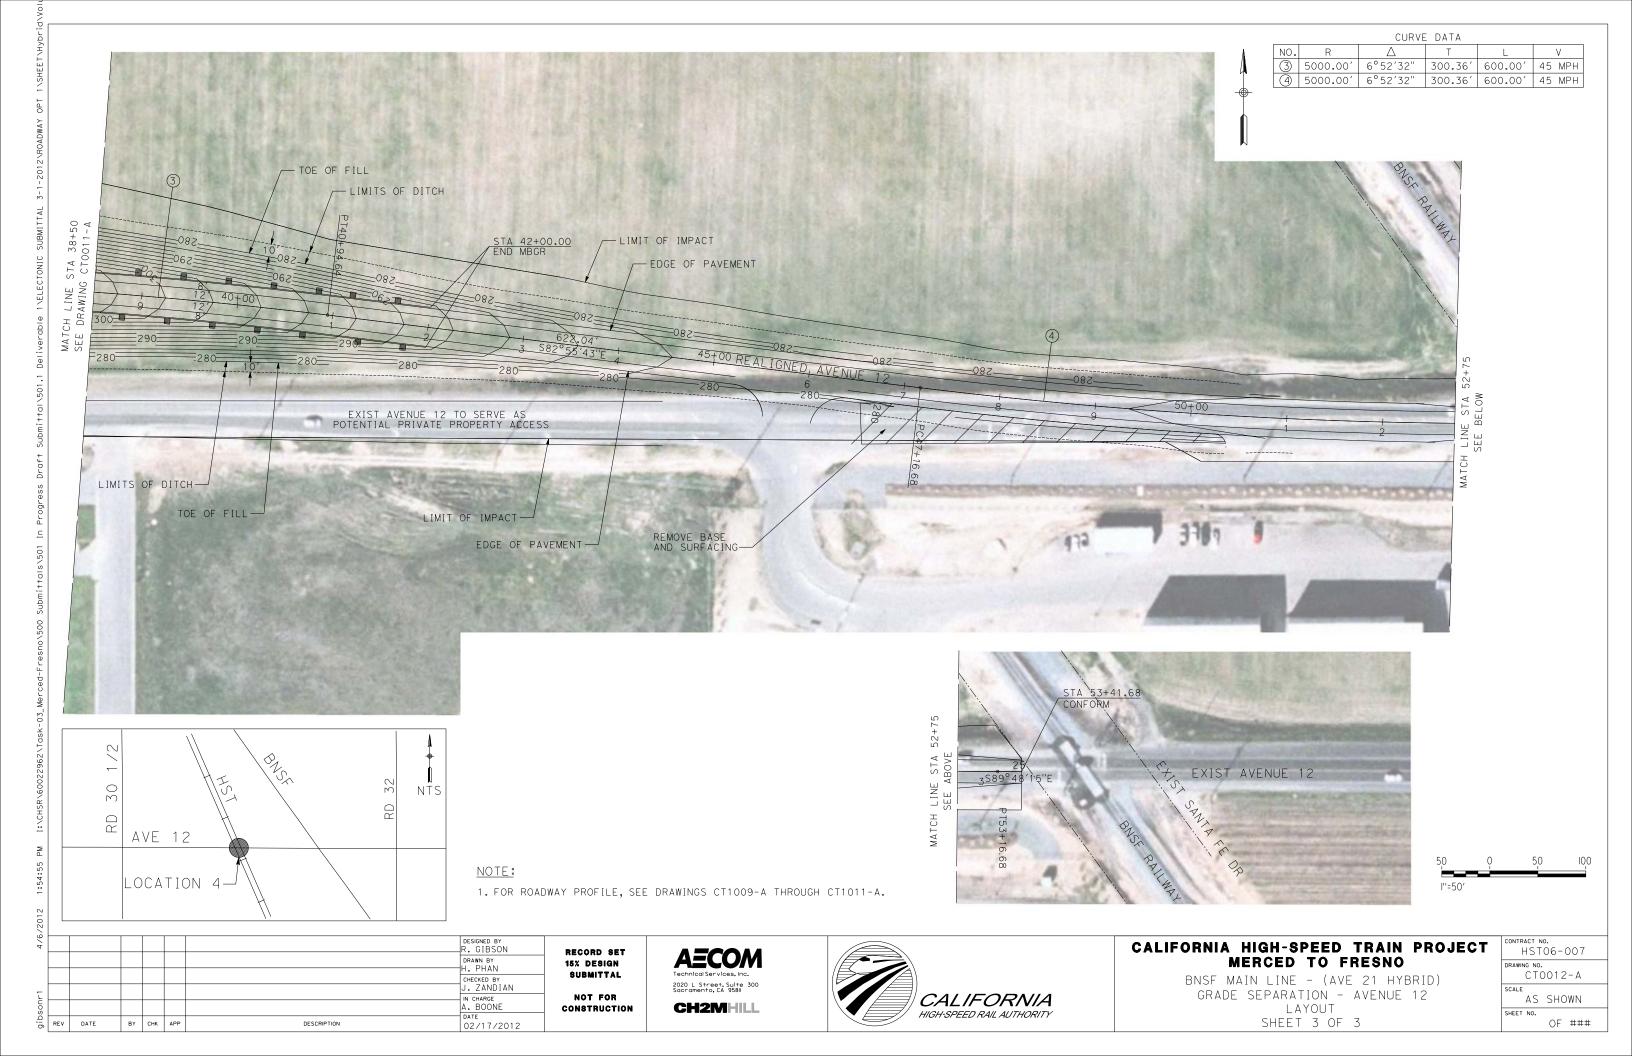

AVE 15

DESIGNED BY R. GIBSON DRAWN BY H. PHAN CHECKED BY
J. ZANDIAN IN CHARGE A. BOONE DATE 06/30/2011 BY CHK APP DESCRIPTION

AVE 15

RECORD SET 15% DESIGN SUBMITTAL NOT FOR CONSTRUCTION

NOTE:

AECOM 2020 L Street, Suite 300 Sacramento, CA 95811 CH2MHILL


1. FOR ROADWAY PROFILE, SEE DRAWINGS CT1015-A THROUGH CT1017-A.



CALIFORNIA HIGH-SPEED TRAIN PROJECT MERCED TO FRESNO

BNSF MAIN LINE - (AVE 21 HYBRID) GRADE SEPARATION - AVENUE 15 LAYOUT SHEET 1 OF 3

CONTRACT NO.
HST06-007
DRAWING NO.
CT0017-A
SCALE
AS SHOWN
SHEET NO.
OF

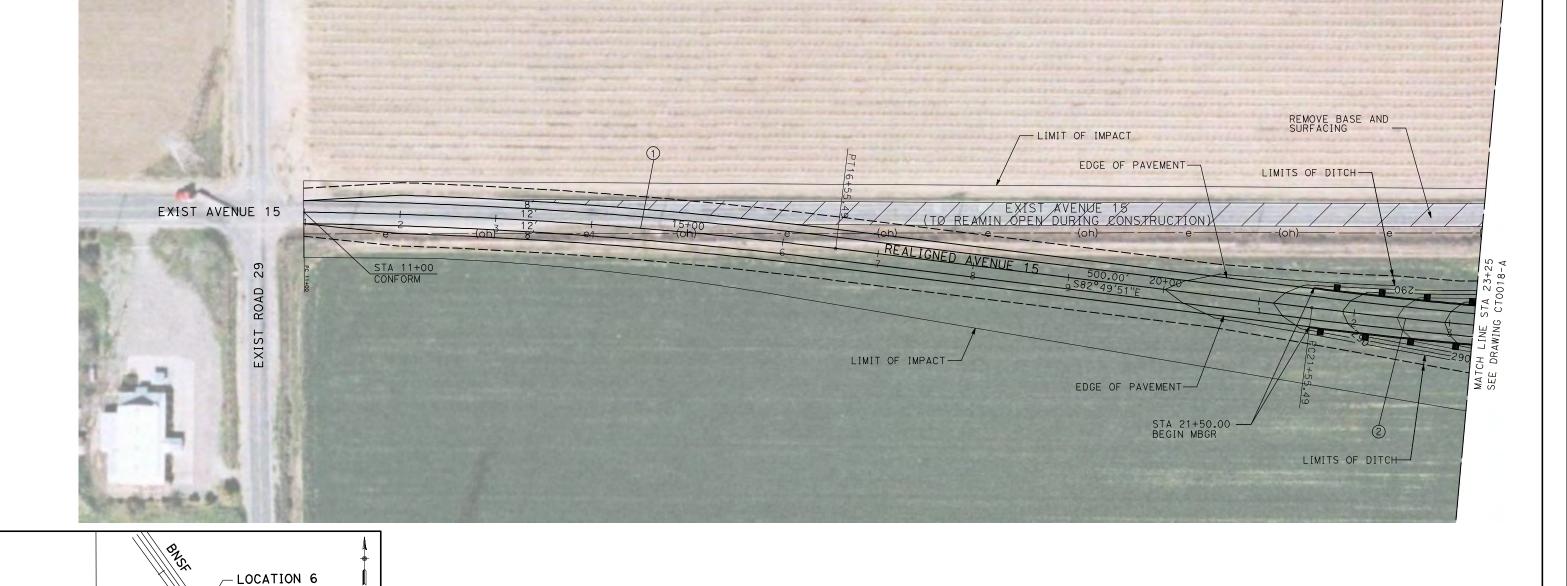

CURVE DATA ② 5000.00′ 6°52′32" 300.36′ 600.00′ 45 MPH

DESIGNED BY R. GIBSON DRAWN BY H. PHAN CHECKED BY
J. ZANDIAN IN CHARGE A. BOONE DATE 06/30/2011 REV DATE BY CHK APP DESCRIPTION

B

LOCATION 6

AVE 15

NTS

15% DESIGN SUBMITTAL NOT FOR CONSTRUCTION

RECORD SET

AECOM 2020 L Street, Suite 300 Sacramento, CA 95811 CH2MHILL





GRADE SEPARATION - AVENUE 15 LAYOUT SHEET 2 OF 3

٦	CONTRACT		5-007
	DRAWING N		18-A
	scale A	s s	HOWN
	CHEET NO		

OF ###

JECT	CONTRACT NO. HST06-007
	DRAWING NO. CTOO18-A
	SCALE AS SHOWN

CURVE DATA

(3) 5000.00' 6°52'32" 300.36' 600.00' 45 MPH


300.36′ 600.00′ 45 MPH

6°52′32"

② 5000.00′

CALIFORNIA HIGH-SPEED TRAIN PRO- Merced to Fresno
BNSF MAIN LINE - (AVE 21 HYBRID)

3	NOTE: 1. FOR ROADWAY PROFILE, SEE DRAWINGS CT1015-A THROUGH CT1017-A.	50 0 50 	100

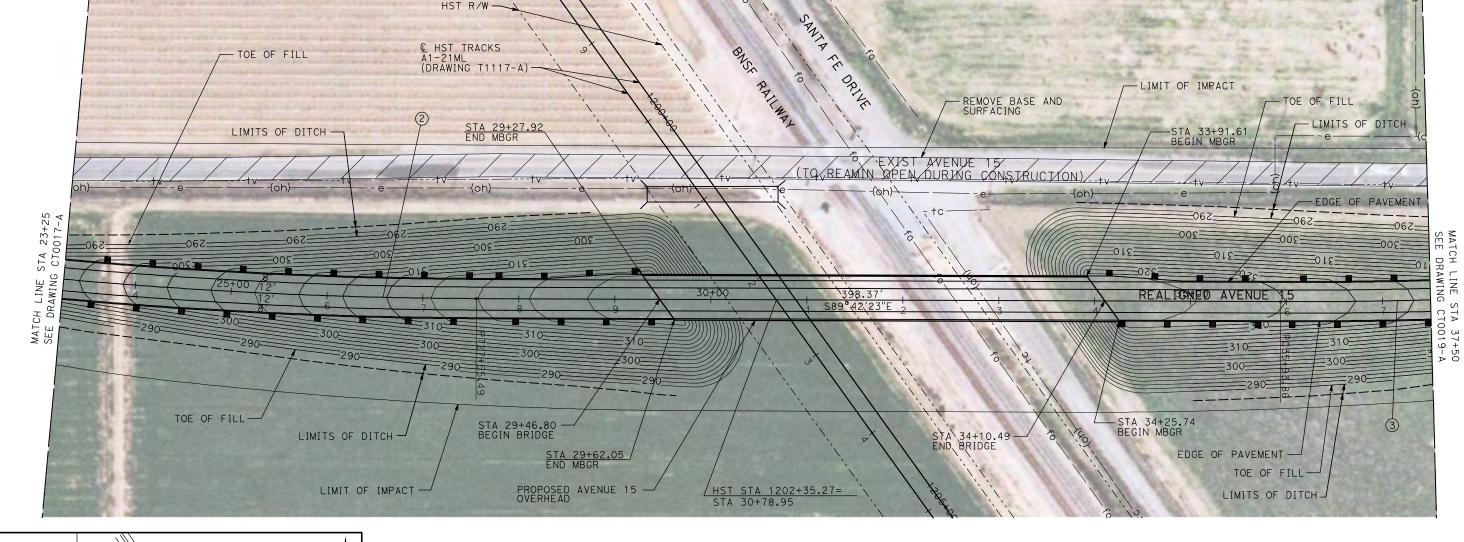

DESIGNED BY R. GIBSON DRAWN BY H. PHAN CHECKED BY
J. ZANDIAN IN CHARGE A. BOONE BY CHK APP DESCRIPTION 06/30/2011

RECORD SET 15% DESIGN SUBMITTAL NOT FOR CONSTRUCTION

AECOM 2020 L Street, Suite 300 Sacramento, CA 95811 CH2MHILL




CALIFORNIA HIGH-SPEED TRAIN PROJECT MERCED TO FRESNO

BNSF MAIN LINE - (AVE 21 HYBRID) GRADE SEPARATION - AVENUE 15 LAYOUT SHEET 3 OF 3


Г	HST06-007
	DRAWING NO. CTOO19-A
	AS SHOWN
	SHEET NO.


OF

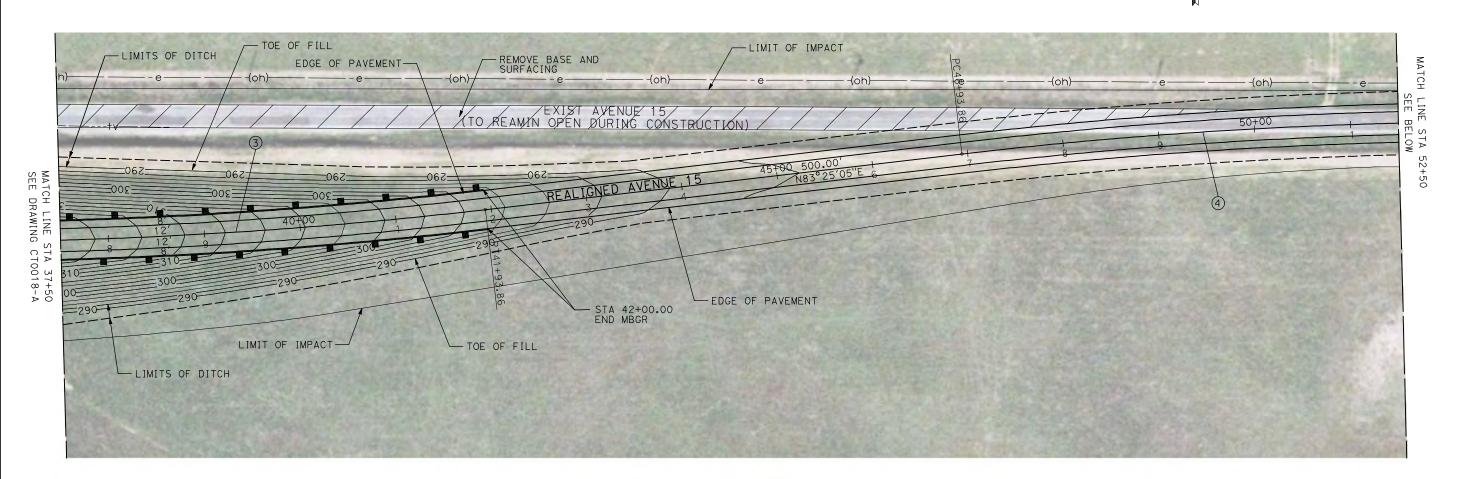

NOTE:

1. FOR ROADWAY PROFILE, SEE DRAWINGS CT1015-A THROUGH CT1017-A.

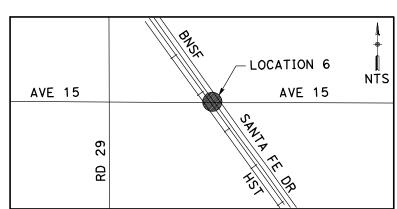

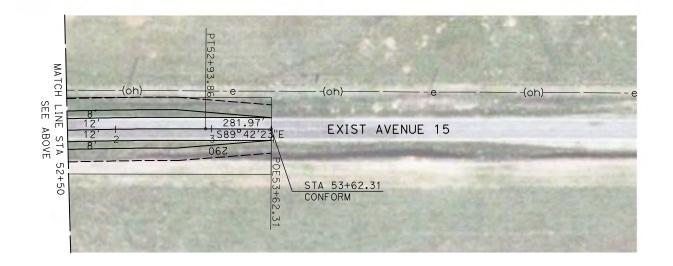

50	Q	50	100
l''=50′			

CURVE DATA

3 5000.00' 6°52'32" 300.36' 600.00' 45 MPH (4) 5000.00' 6°52'32" 300.36' 600.00' 45 MPH

DRAWN BY H. PHAN 06/30/2011 BY CHK APP DESCRIPTION

RECORD SET 15% DESIGN SUBMITTAL NOT FOR CONSTRUCTION






BNSF MAIN LINE - (AVE 21 HYBRID) GRADE SEPARATION - AVENUE 15 1/2 LAYOUT SHEET 1 OF 3


•	CONTRACT NO. HST06-007
	DRAWING NO. CTOO20-A
	AS SHOWN
	SHEET NO. ### OF ###

CURVE DATA

② 3000.00′ 9°32′57" 250.58′ 500.00′ 45 MPH


9°32′57" | 250.58′ | 500.00′ | 45 MPH

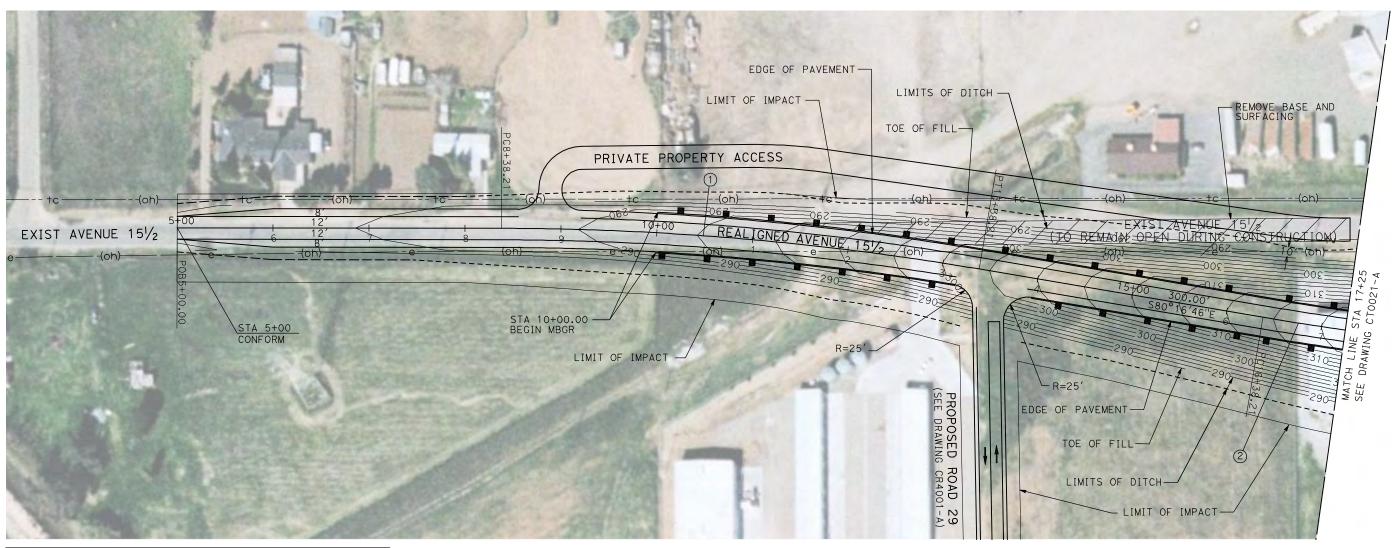

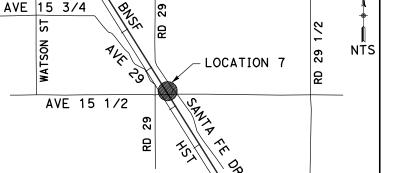


NOTE:

1. FOR ROADWAY PROFILE, SEE DRAWINGS CT1018-A THROUGH CT1020-A.

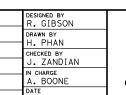








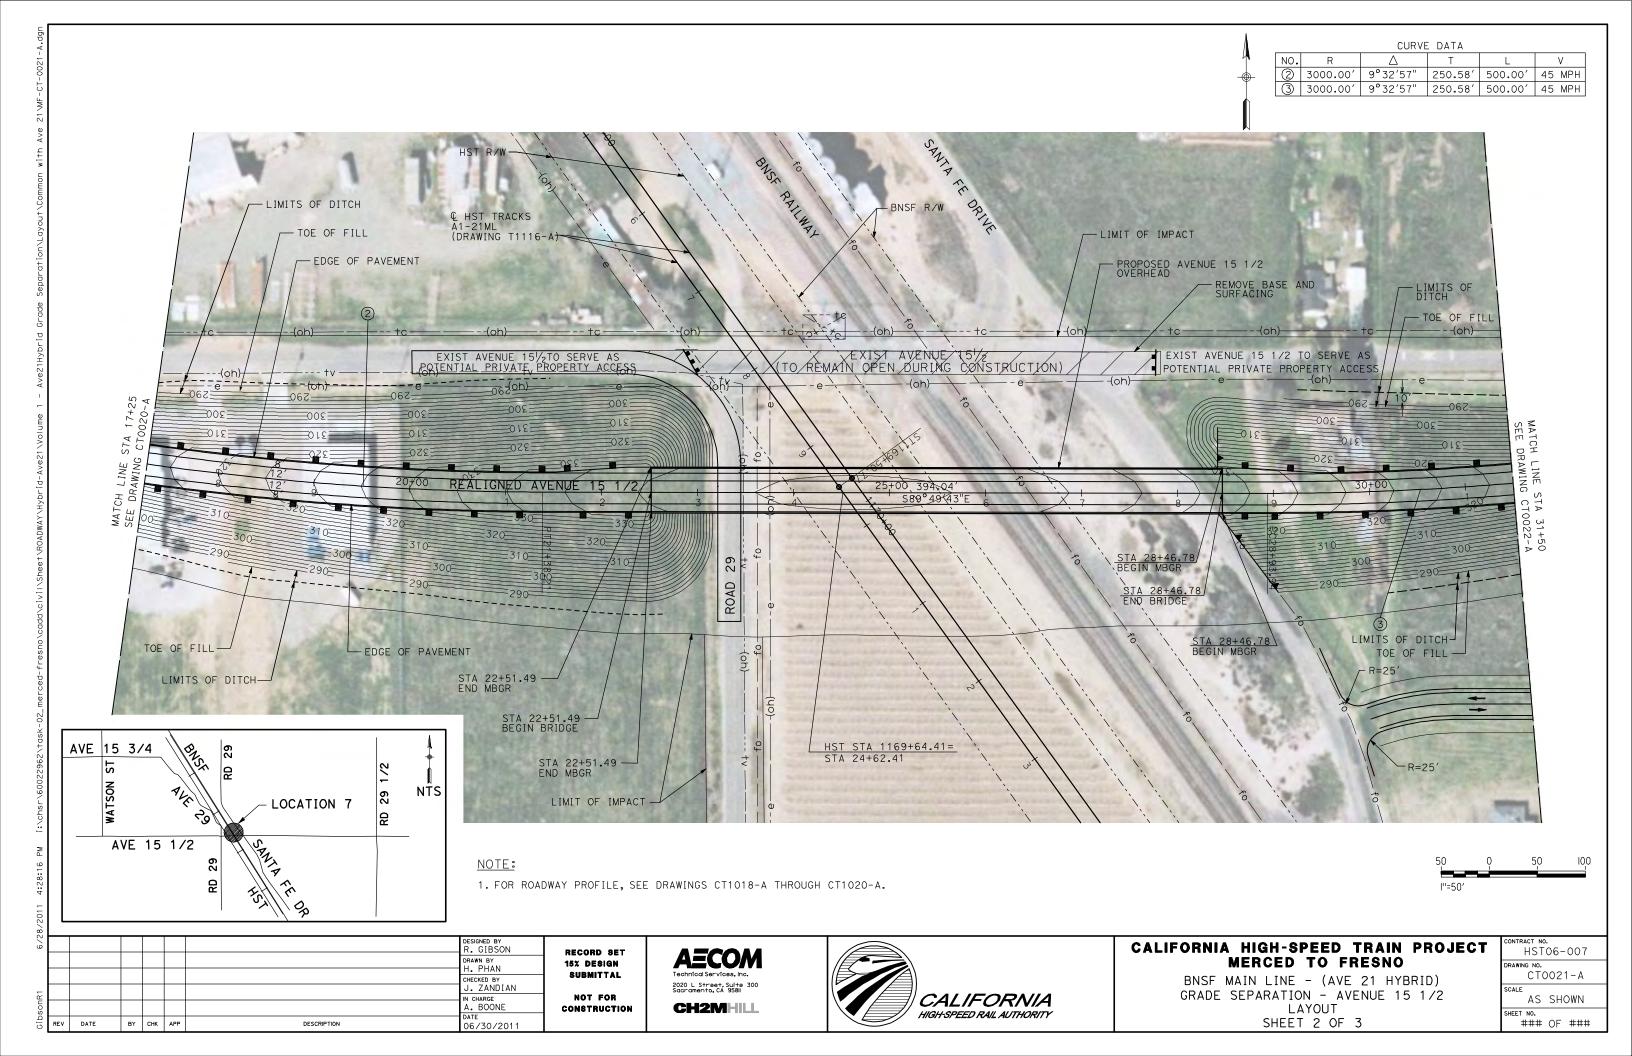


CURVE DATA 3 3000.00′ 9°32′57" 250.58′ 500.00′ 45 MPH 4 3000.00′ 9°32′57" 250.58′ 500.00′ 45 MPH - LIMIT OF IMPACT - TOE OF FILL - EDGE OF PAVEMENT - LIMITS OF DITCH LIMIT OF IMPACT PRIVATE PROPERTY ACCESS TOE OF FILL EXIST AVENUE 15 1/2 TO SERVE AS POTENTIAL PRIVATE PROPERTY ACCESS EXIST AVENUE 15 1/2 S89°49′43″E - EDGE OF PAVEMENT R=25' LIMIT OF IMPACT LIMITS OF DITCH-LIMIT OF IMPACT TOE OF FILL R=25'-AVE 15 3/4 NTS LOCATION 7 AVE 15 1/2 NOTE: 1. FOR ROADWAY PROFILE, SEE DRAWINGS CT1018-A THROUGH CT1020-A. DESIGNED BY R. GIBSON CALIFORNIA HIGH-SPEED TRAIN PROJECT HST06-007 RECORD SET DRAWN BY H. PHAN MERCED TO FRESNO 15% DESIGN SUBMITTAL CT0022-A CHECKED BY
J. ZANDIAN BNSF MAIN LINE - (AVE 21 HYBRID) 2020 L Street, Suite 300 Sacramento, CA 95811 GRADE SEPARATION - AVENUE 15 1/2 NOT FOR IN CHARGE A. BOONE CALIFORNIA AS SHOWN CH2MHILL LAYOUT CONSTRUCTION HIGH-SPEED RAIL AUTHORITY SHEET 3 OF 3 ### OF ### BY CHK APP DESCRIPTION 06/30/2011

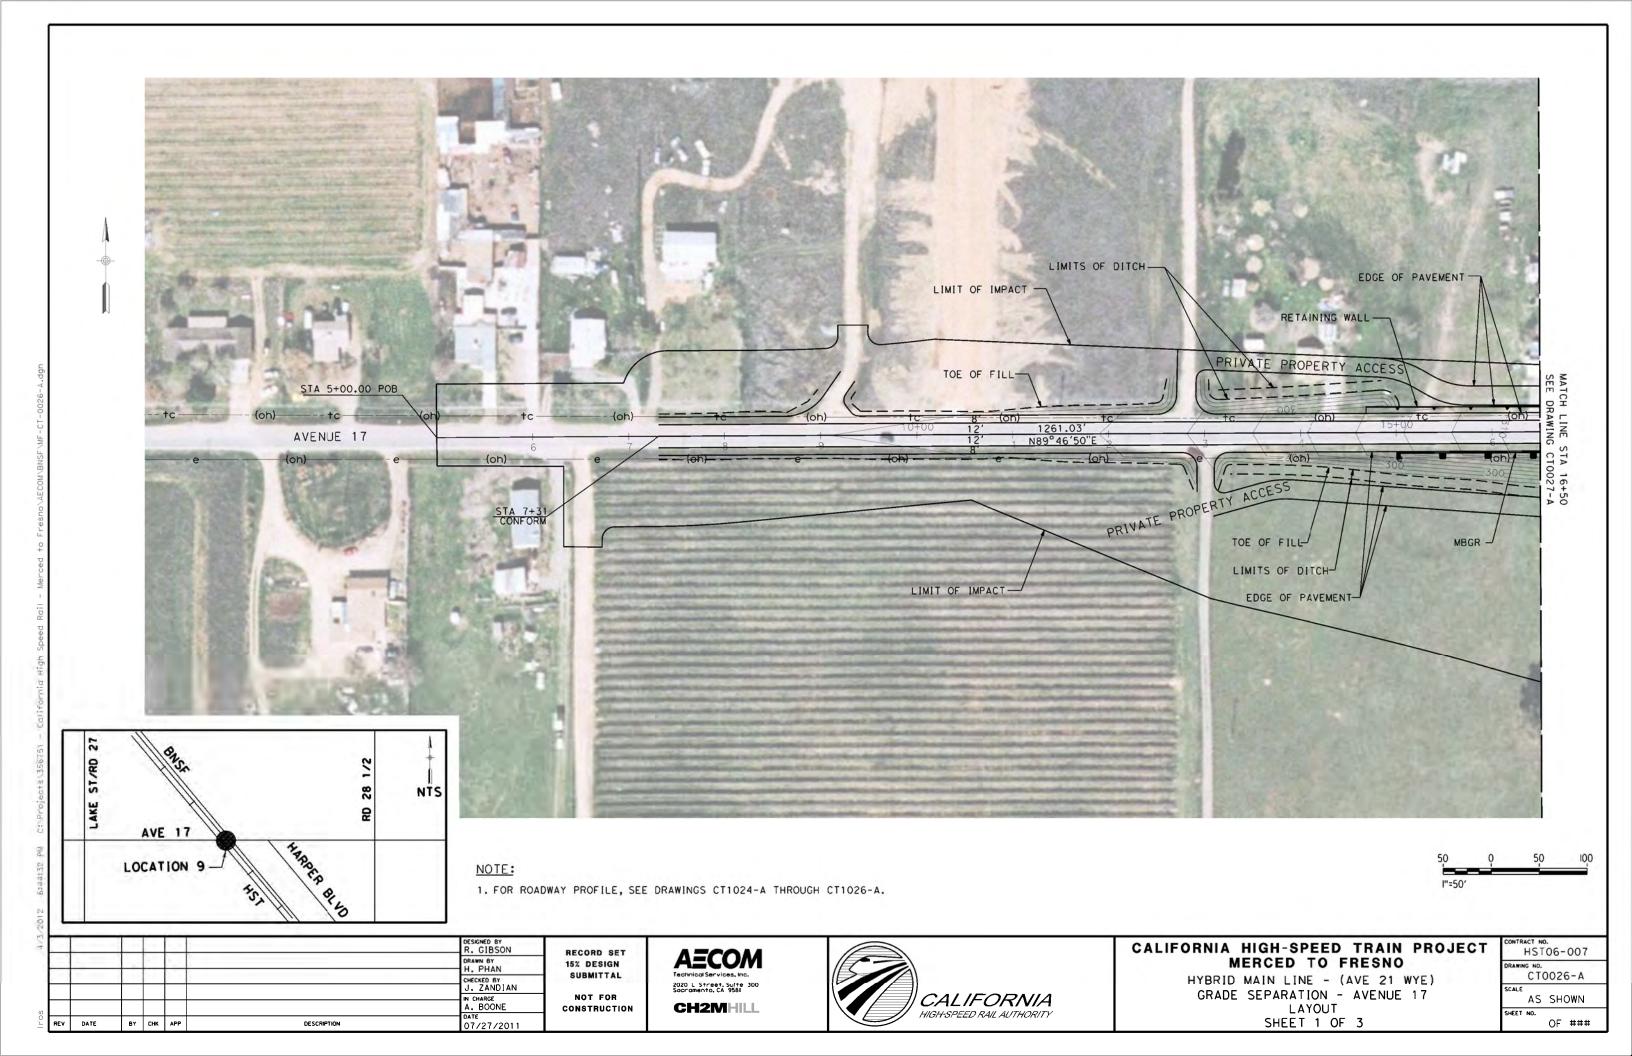


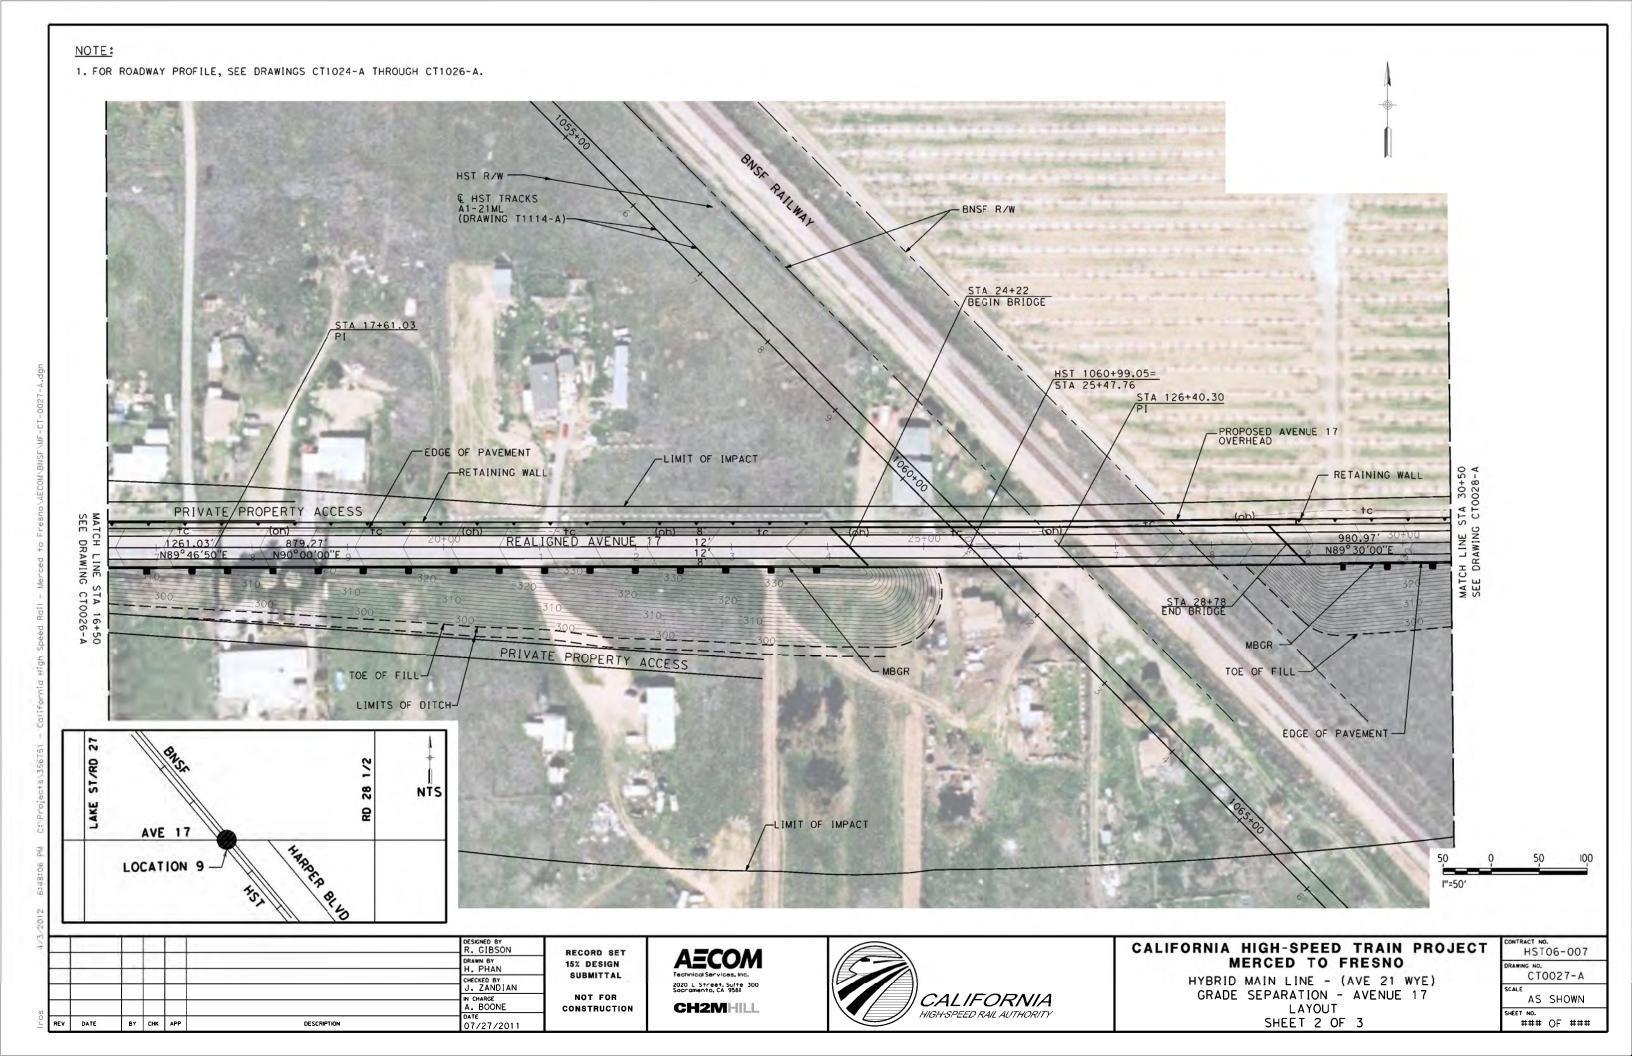

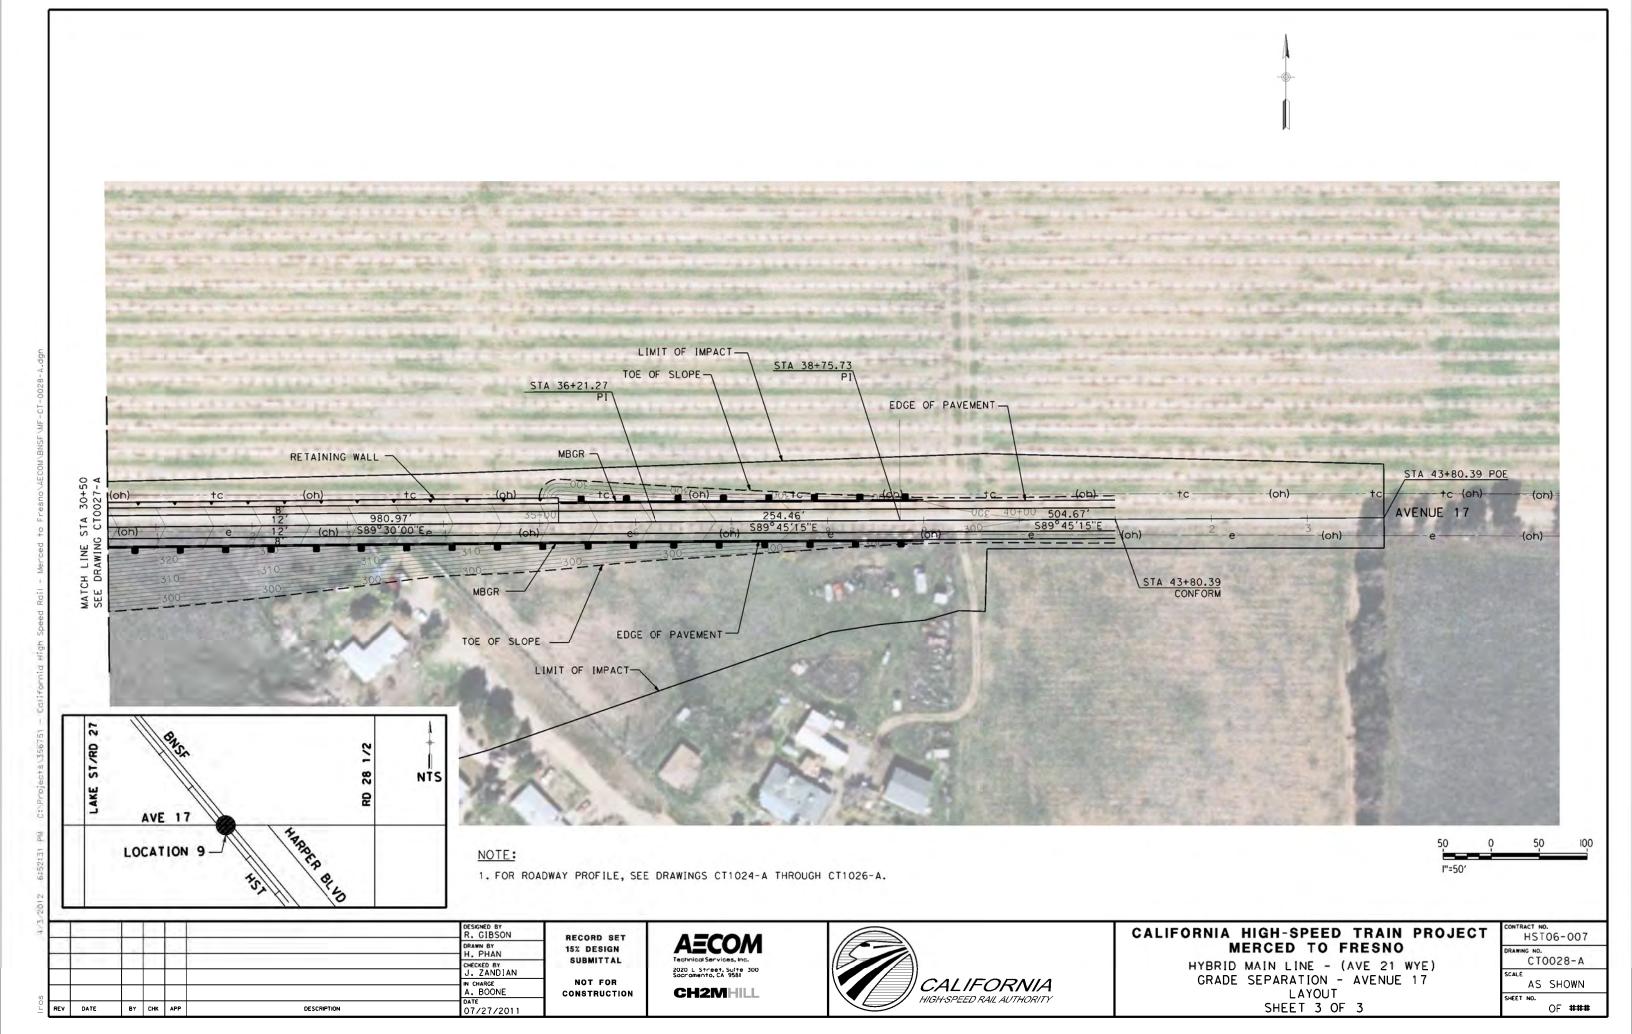



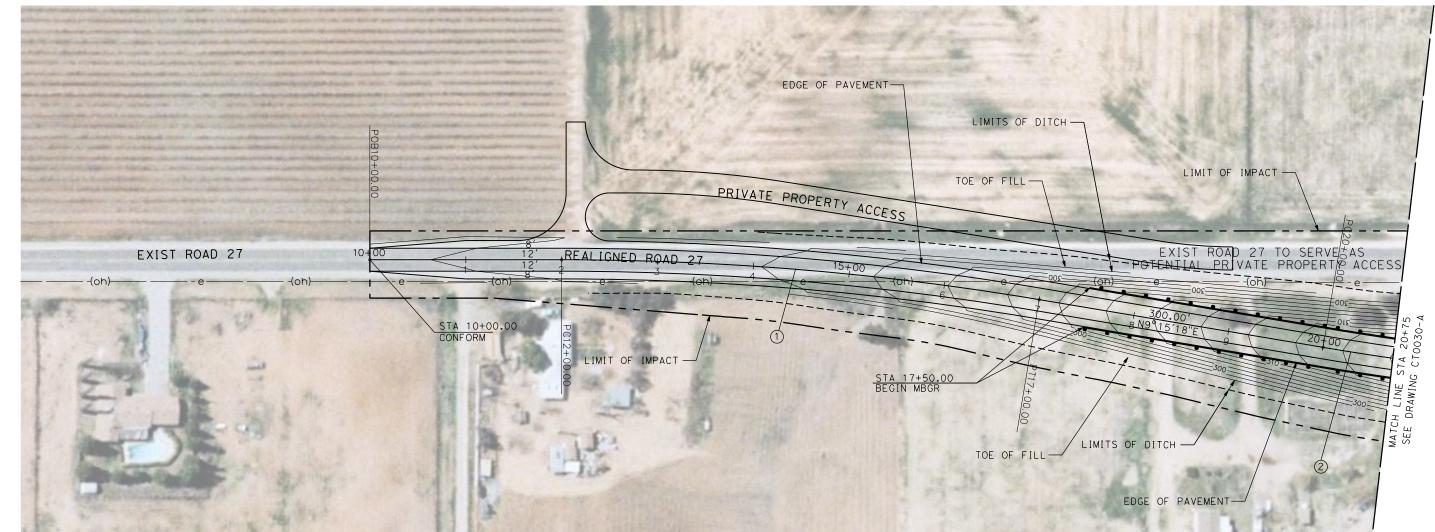

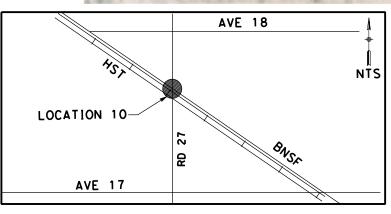

DESCRIPTION

10 1 E :

DESIGNED BY R. GIBSON

CHECKED BY A. SILVER

IN CHARGE A. BOONE

DRAWN BY H. PHAN

1. FOR ROADWAY PROFILE, SEE DRAWINGS CT1029-A THROUGH CT1031-A.

RECORD SET 15% DESIGN

SUBMITTAL

NOT FOR

CONSTRUCTION

AECOM Technical Services, Inc. 2020 L Street, Suite 300 Sacramento, CA 958II CH2MHILL



CALIFORNIA HIGH-SPEED TRAIN PROJECT MERCED TO FRESNO

BNSF MAIN LINE - (AVE 21 HYBRID)
GRADE SEPARATION - ROAD 27
LAYOUT
SHEET 1 OF 3

T	CONTRACT NO. HST06-007				
	DRAWIN)029-A		
	SCALE	AS	SHOWN		


AS SHOWN


SHEET NO.


OF


-coF 4/5/2012 4:13:42 PM \\usscr1fp001


BY CHK APP

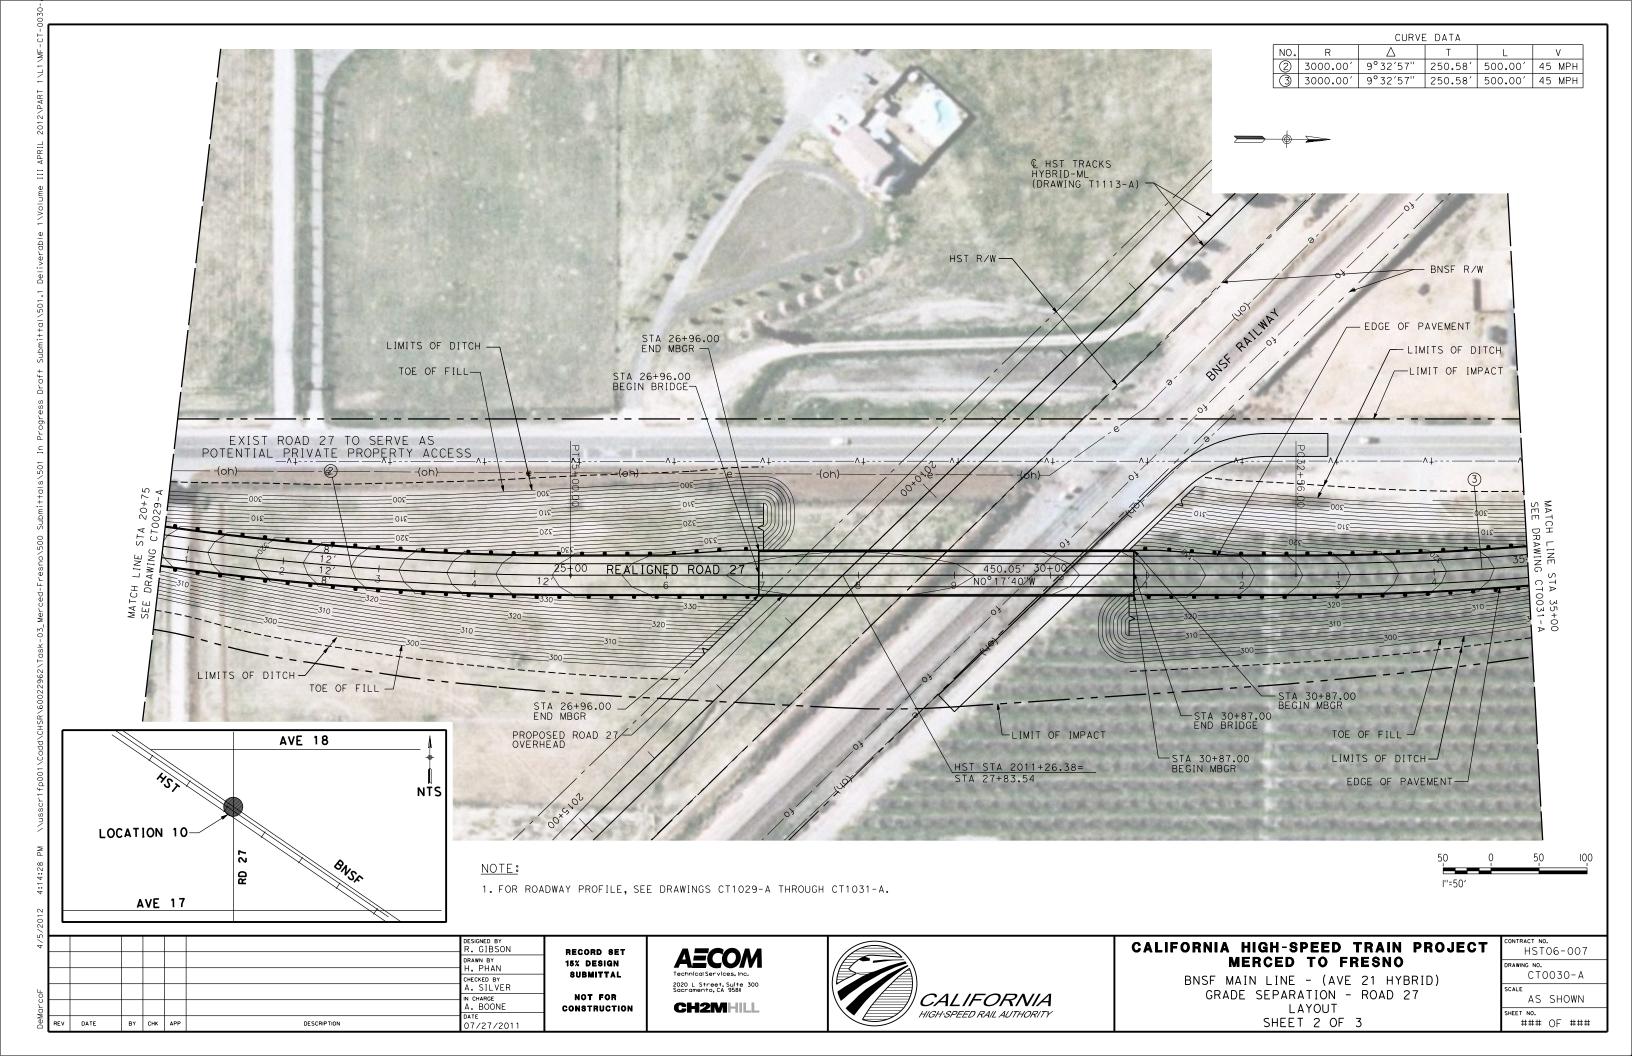


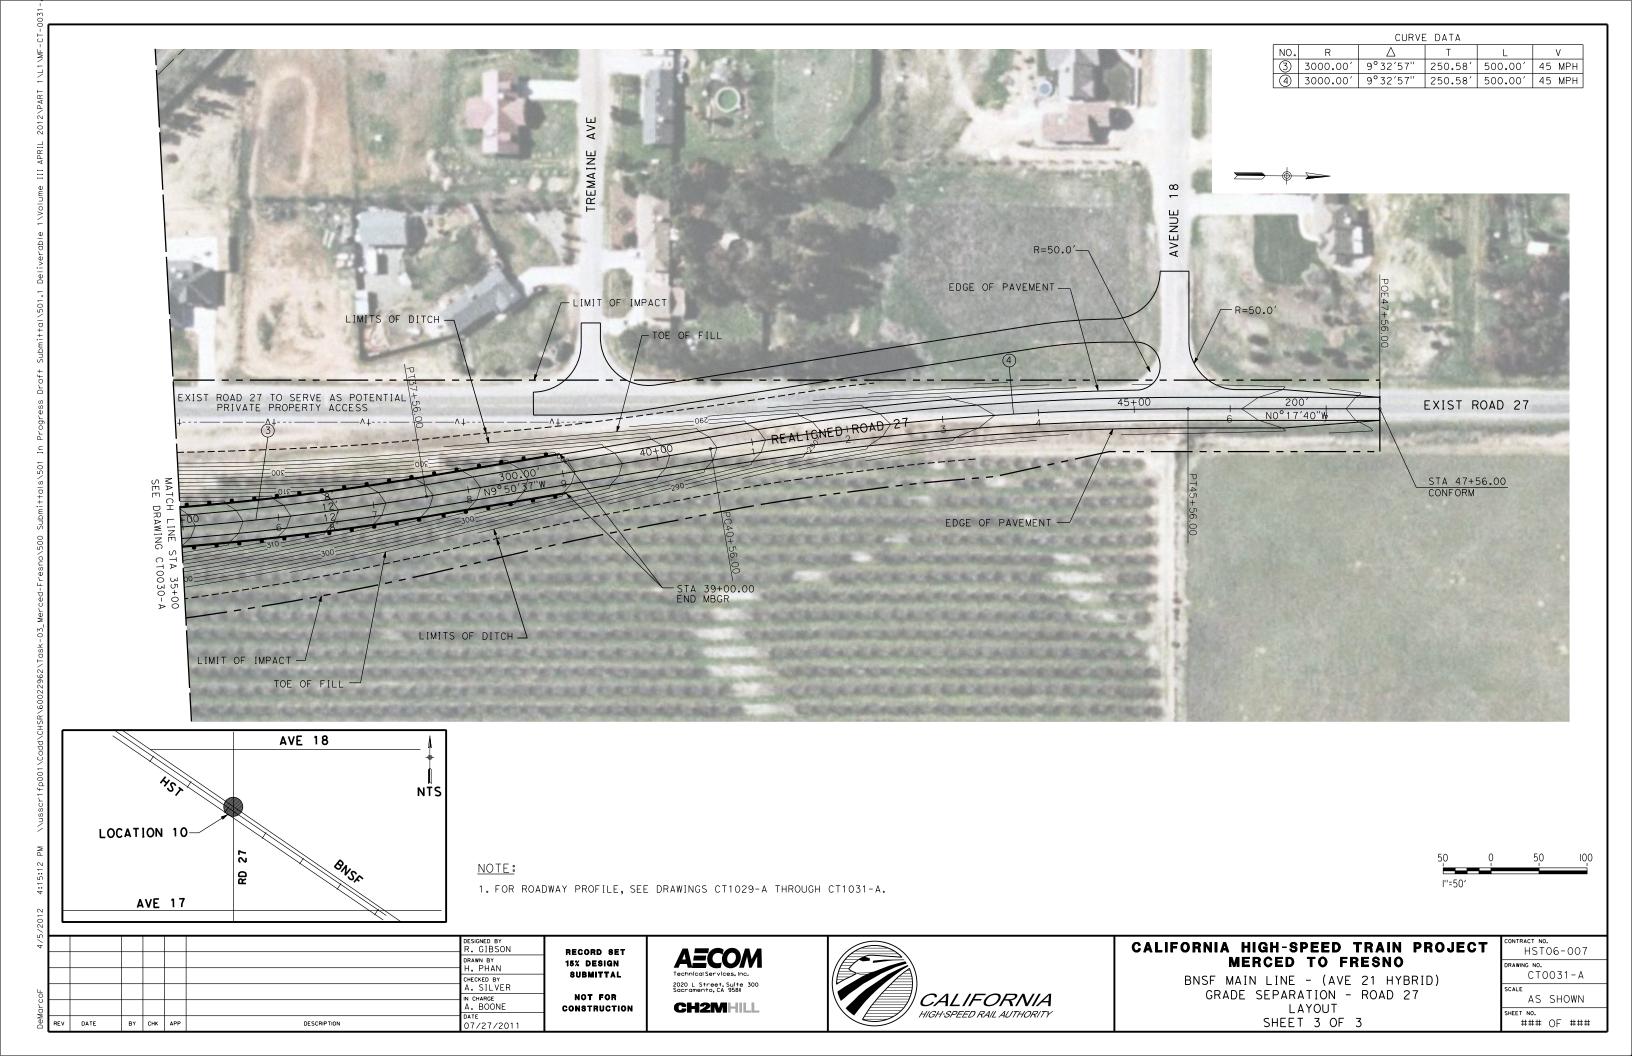


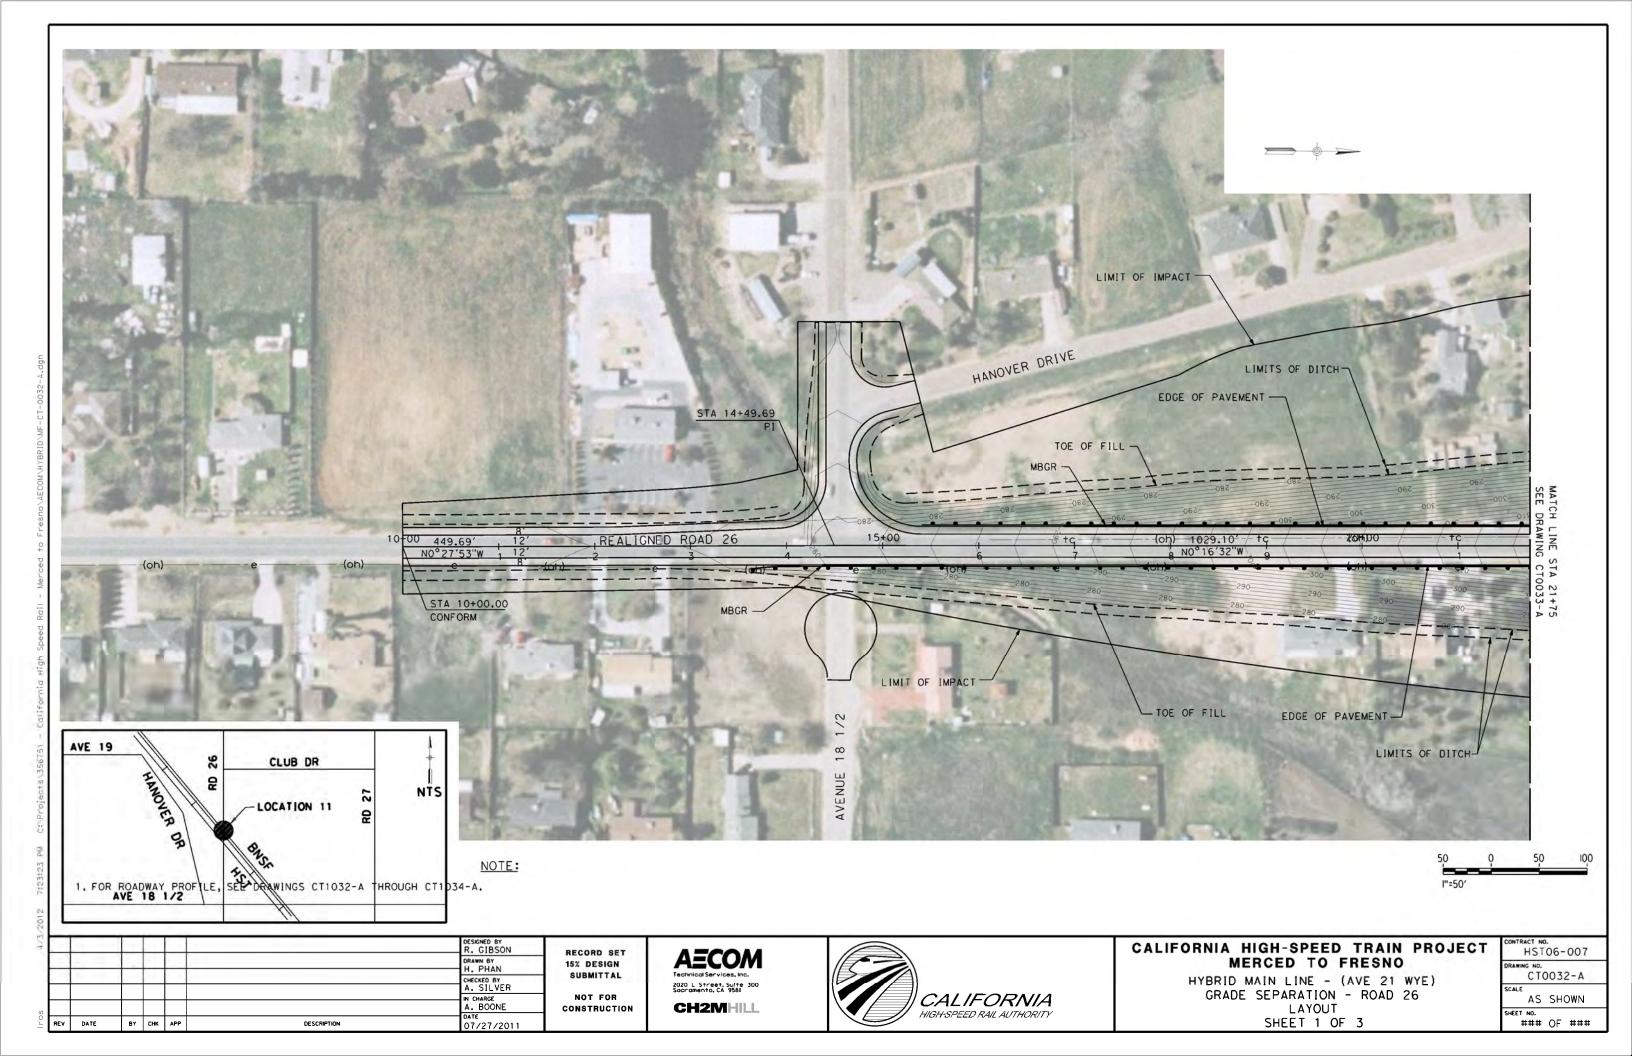

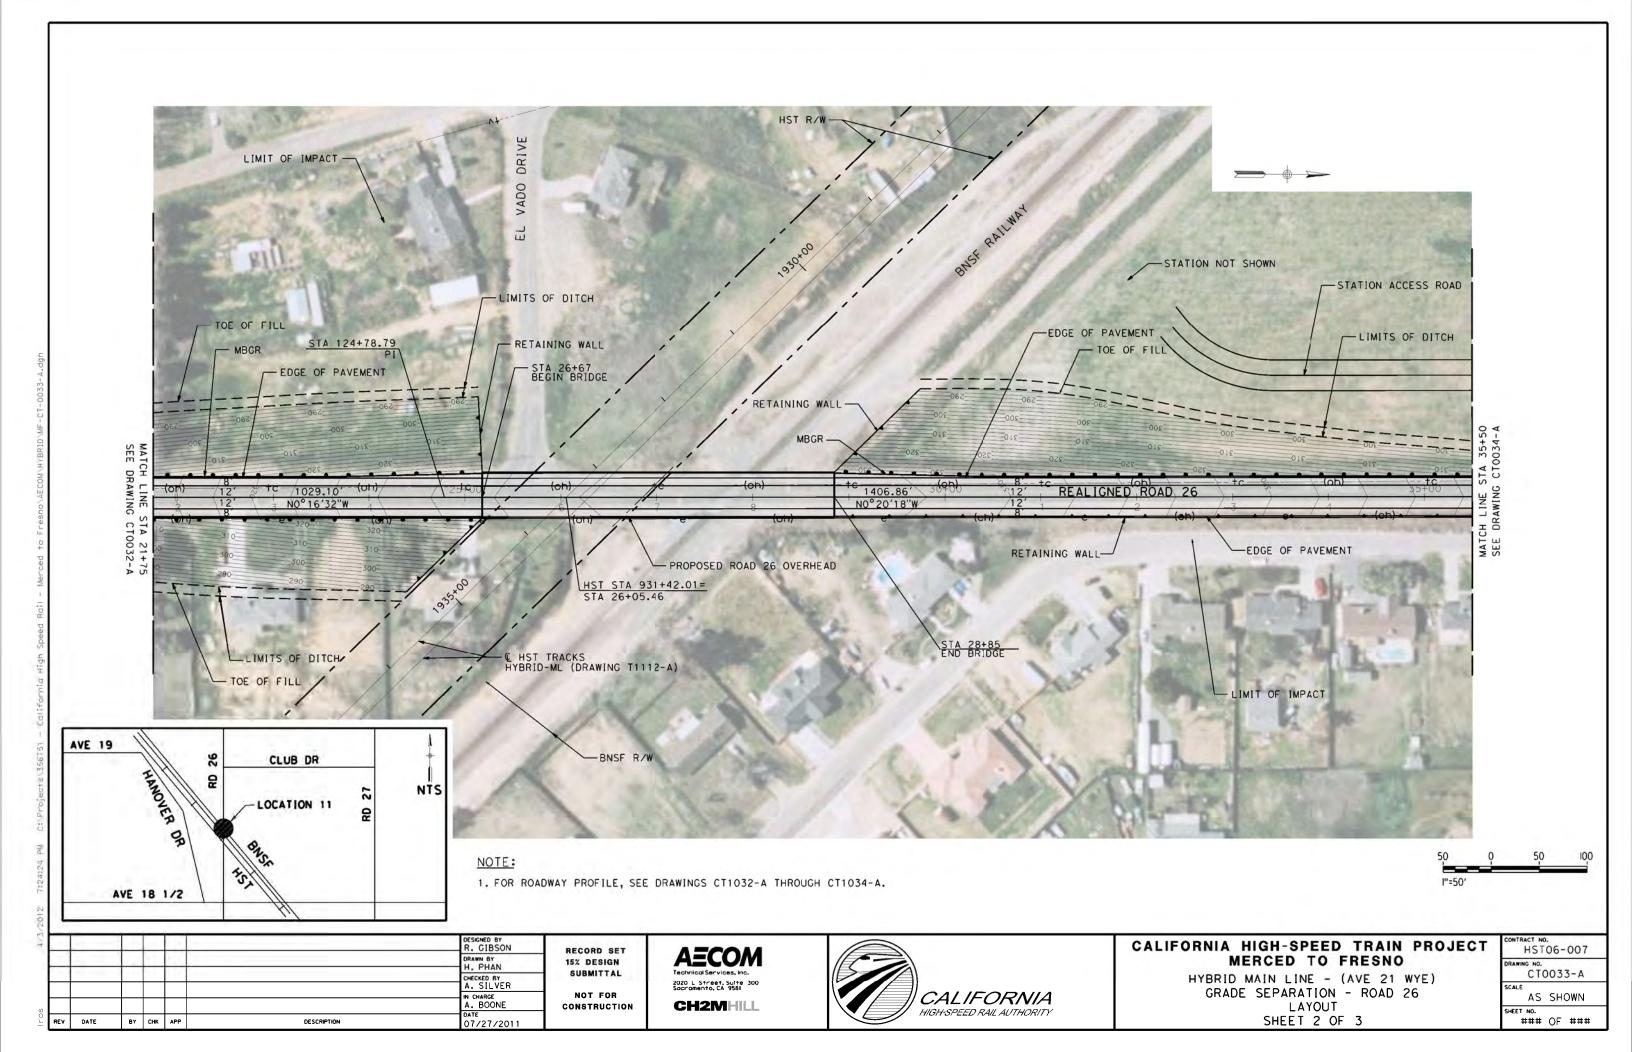


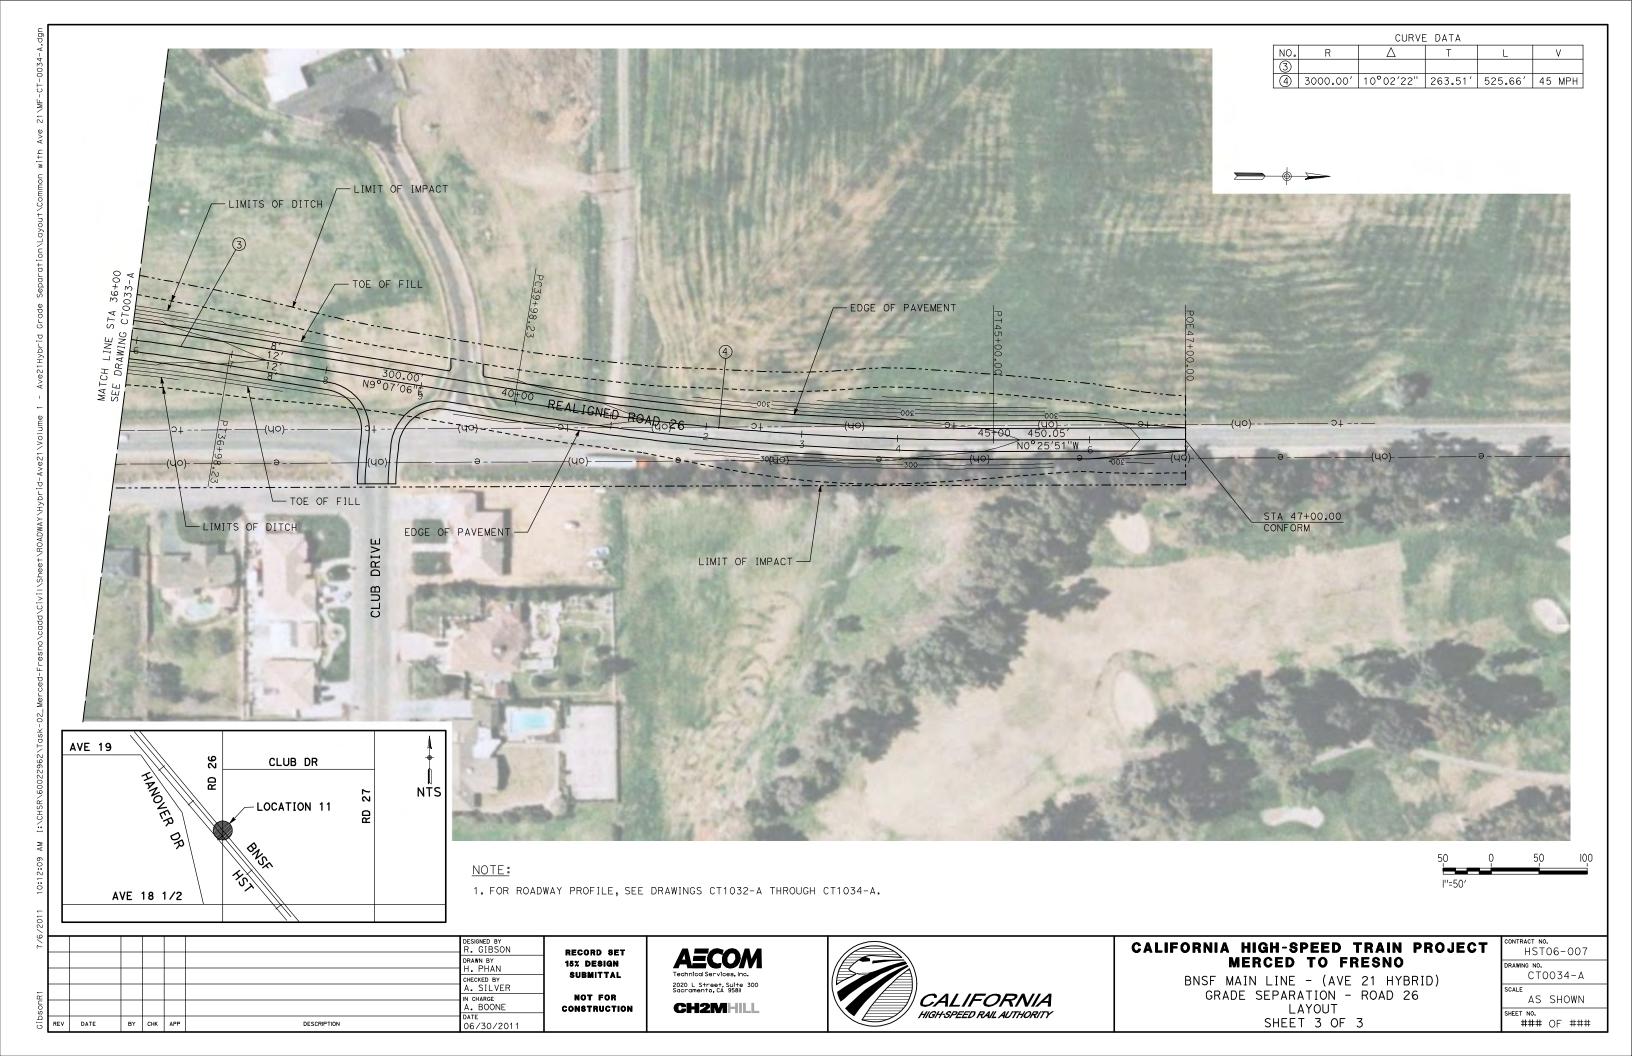

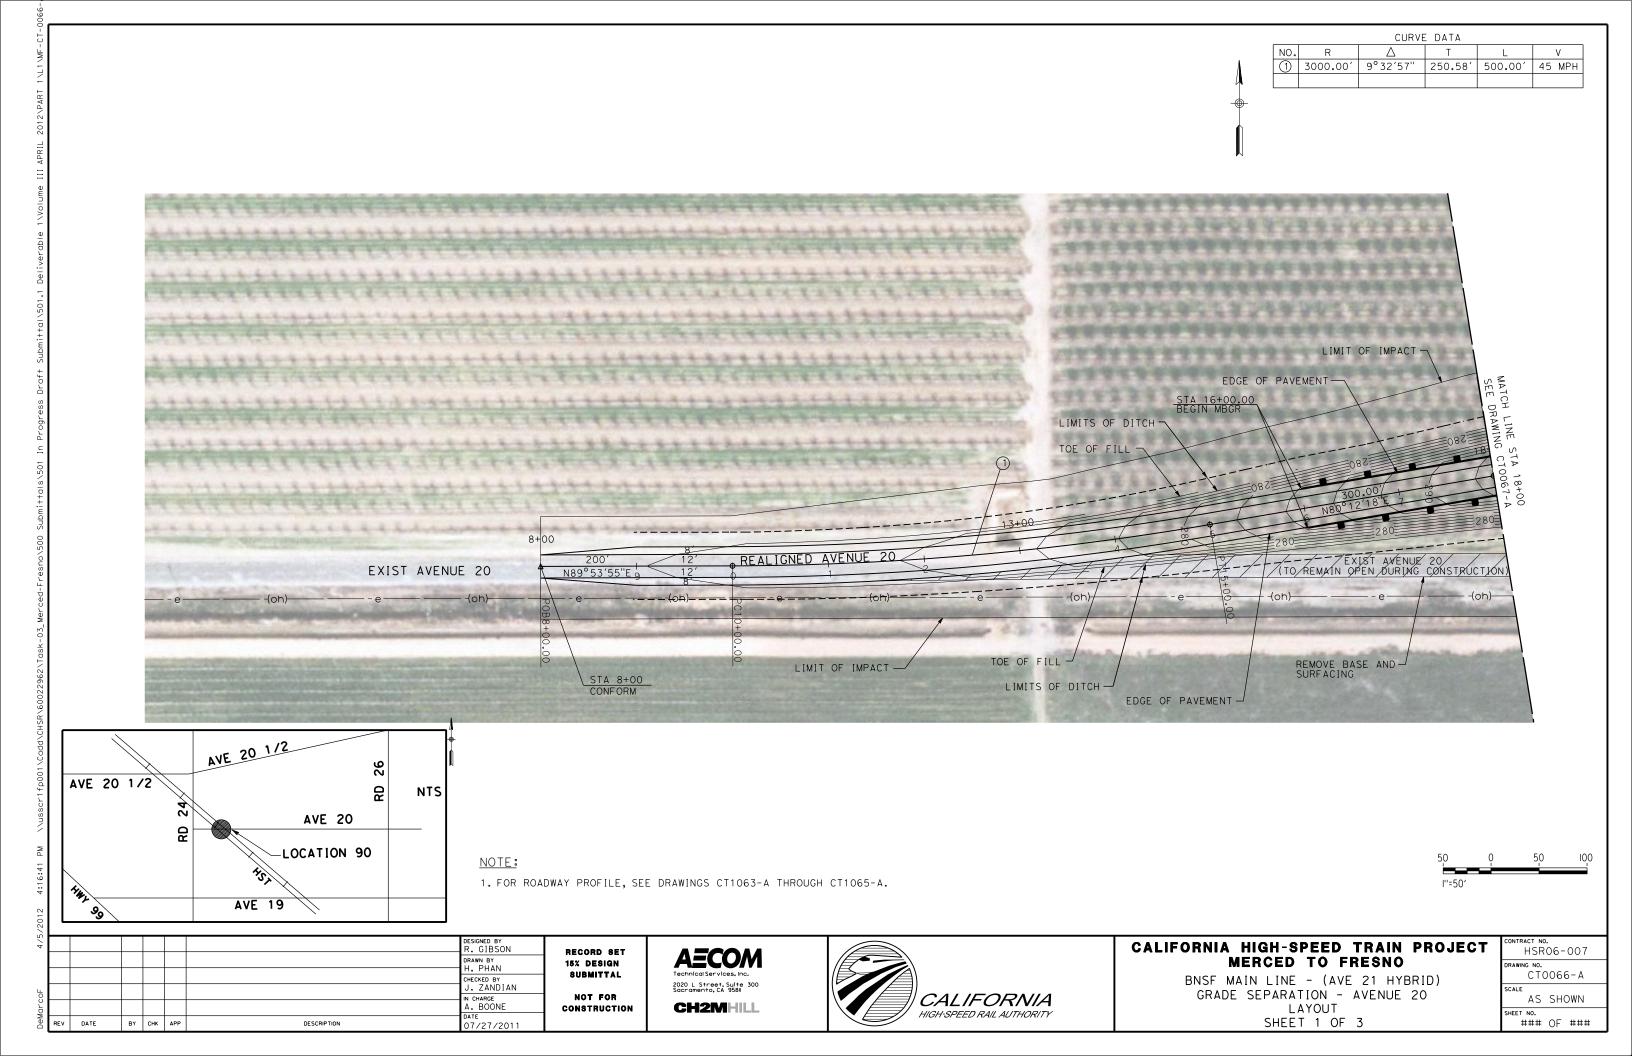

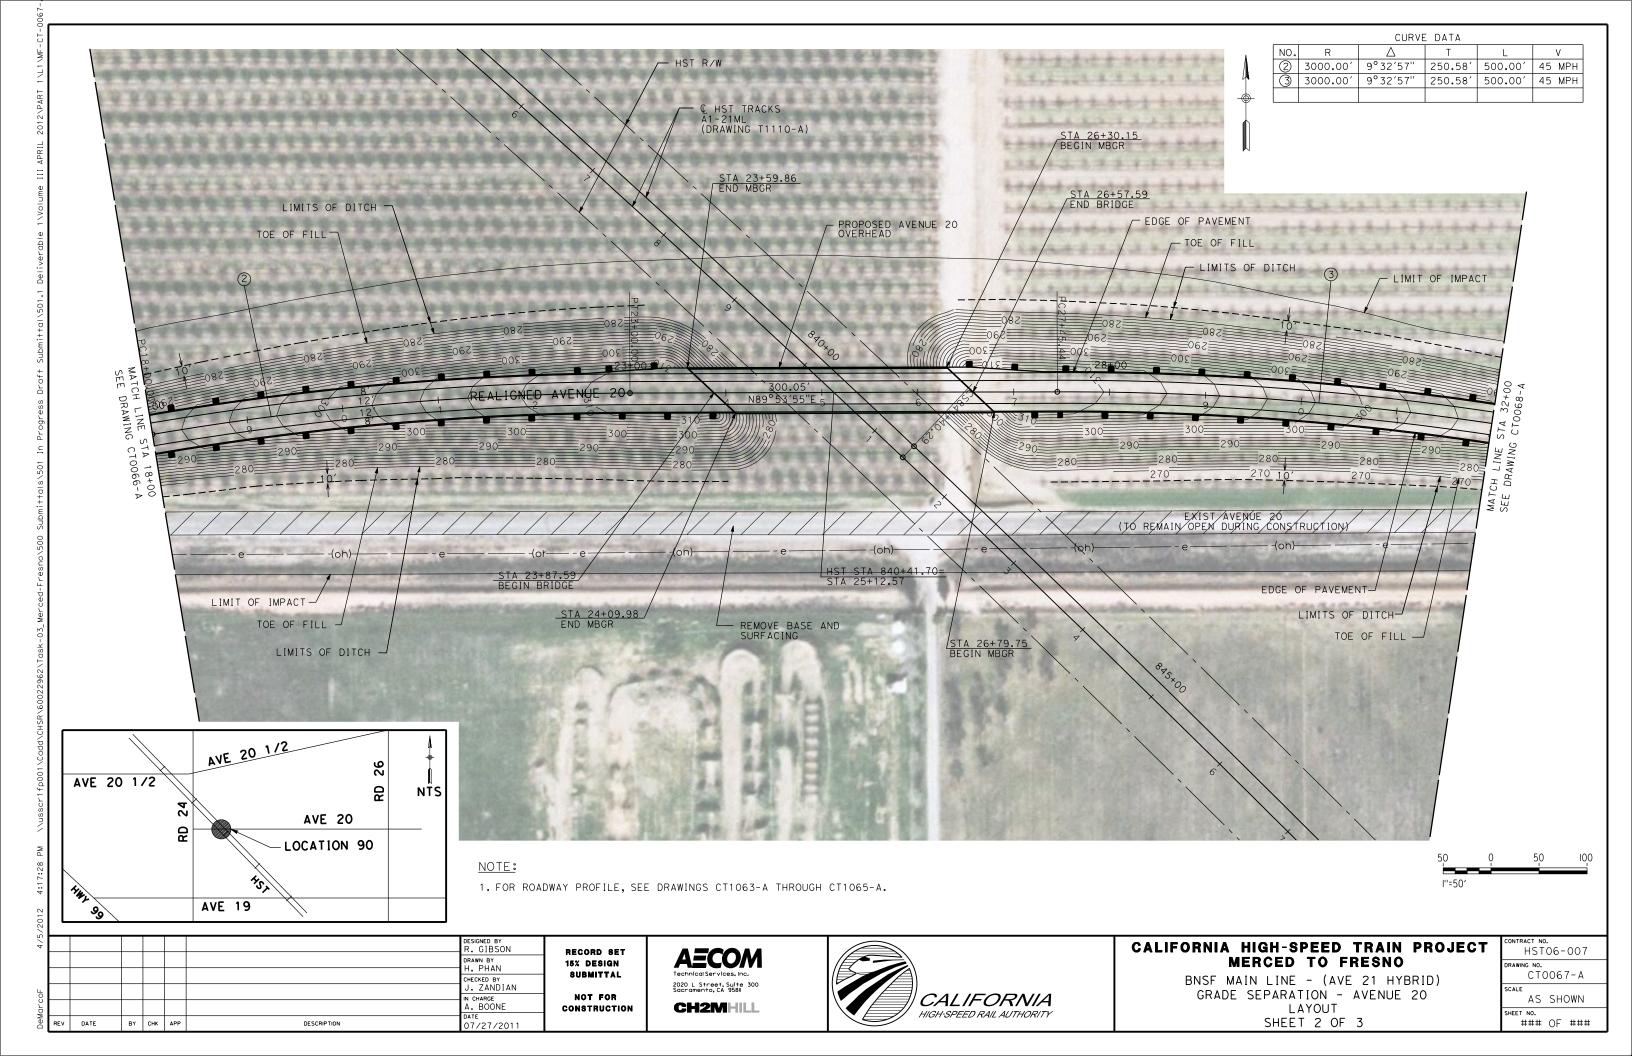


CURVE DATA NO. R 4 2000.00' 9°35′10" | 167.70′ | 334.62′ | 45 MPH 43+00 43+55 EXIST AVENUE -26 - (TO REMAIN OPEN DURING CONSTRUCTION) EXIST AVENUE 20 STA 32+47.36 END MBGR EDGE OF PAVEMENT REMOVE BASE AND SURFACING TOE OF FILL STA 43+55.42 CONFORM LIMITS OF DITCH AVE 20 1/2 AVE 20 1/2 NTS AVE 20

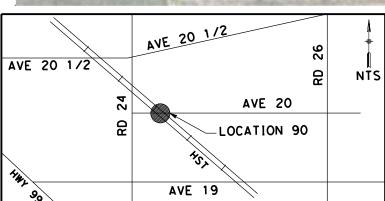

NOTE:

1. FOR ROADWAY PROFILE, SEE DRAWINGS CT1063-A THROUGH CT1065-A.

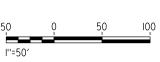

					DESIGNED BY R. GIBSON
					DRAWN BY H. PHAN
					CHECKED BY
					J. ZANDIAN
					IN CHARGE A. BOONE
v	DATE	ВҮ	СНК	APP	DATE 07/27/2011

RECORD SET 15% DESIGN SUBMITTAL NOT FOR CONSTRUCTION **AECOM** 2020 L Street, Suite 300 Sacramento, CA 95811 **CH2MHILL**



CALIFORNIA HIGH-SPEED TRAIN PROJECT MERCED TO FRESNO

BNSF MAIN LINE - (AVE 21 HYBRID) GRADE SEPARATION - AVENUE 20 LAYOUT SHEET 3 OF 3

CONTRACT NO. HSRO6-007						
DRAWIN		068-A				
SCALE	AS	SHOWN				
CHEET	4.0		_			

OF

CT0069-A

AS SHOWN

OF

BNSF MAIN LINE - (AVE 21 HYBRID)

GRADE SEPARATION - AVENUE 20 1/2

LAYOUT

SHEET 1 OF 3

15% DESIGN SUBMITTAL

NOT FOR

CONSTRUCTION

2020 L Street, Suite 300 Socramento, CA 95811

CH2MHILL

CALIFORNIA HIGH-SPEED RAIL AUTHORITY


CHECKED BY
J. ZANDIAN


06/30/2011


N CHARGE A. BOONE

BY CHK APP

DESCRIPTION

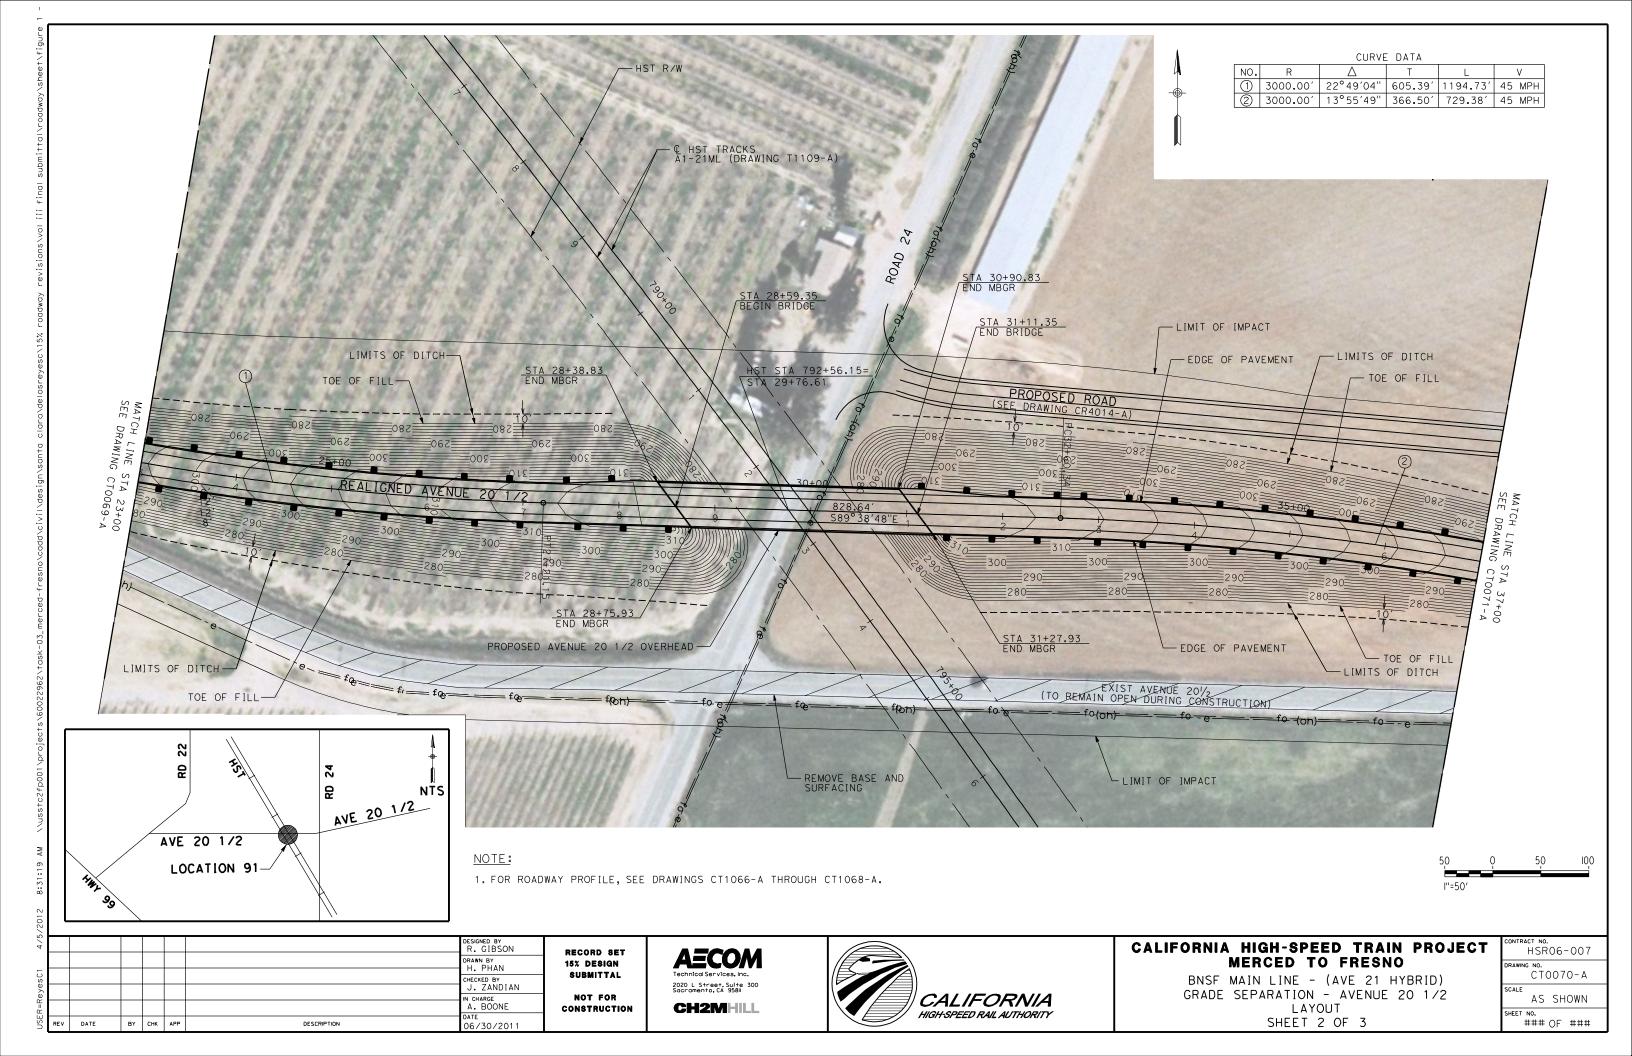

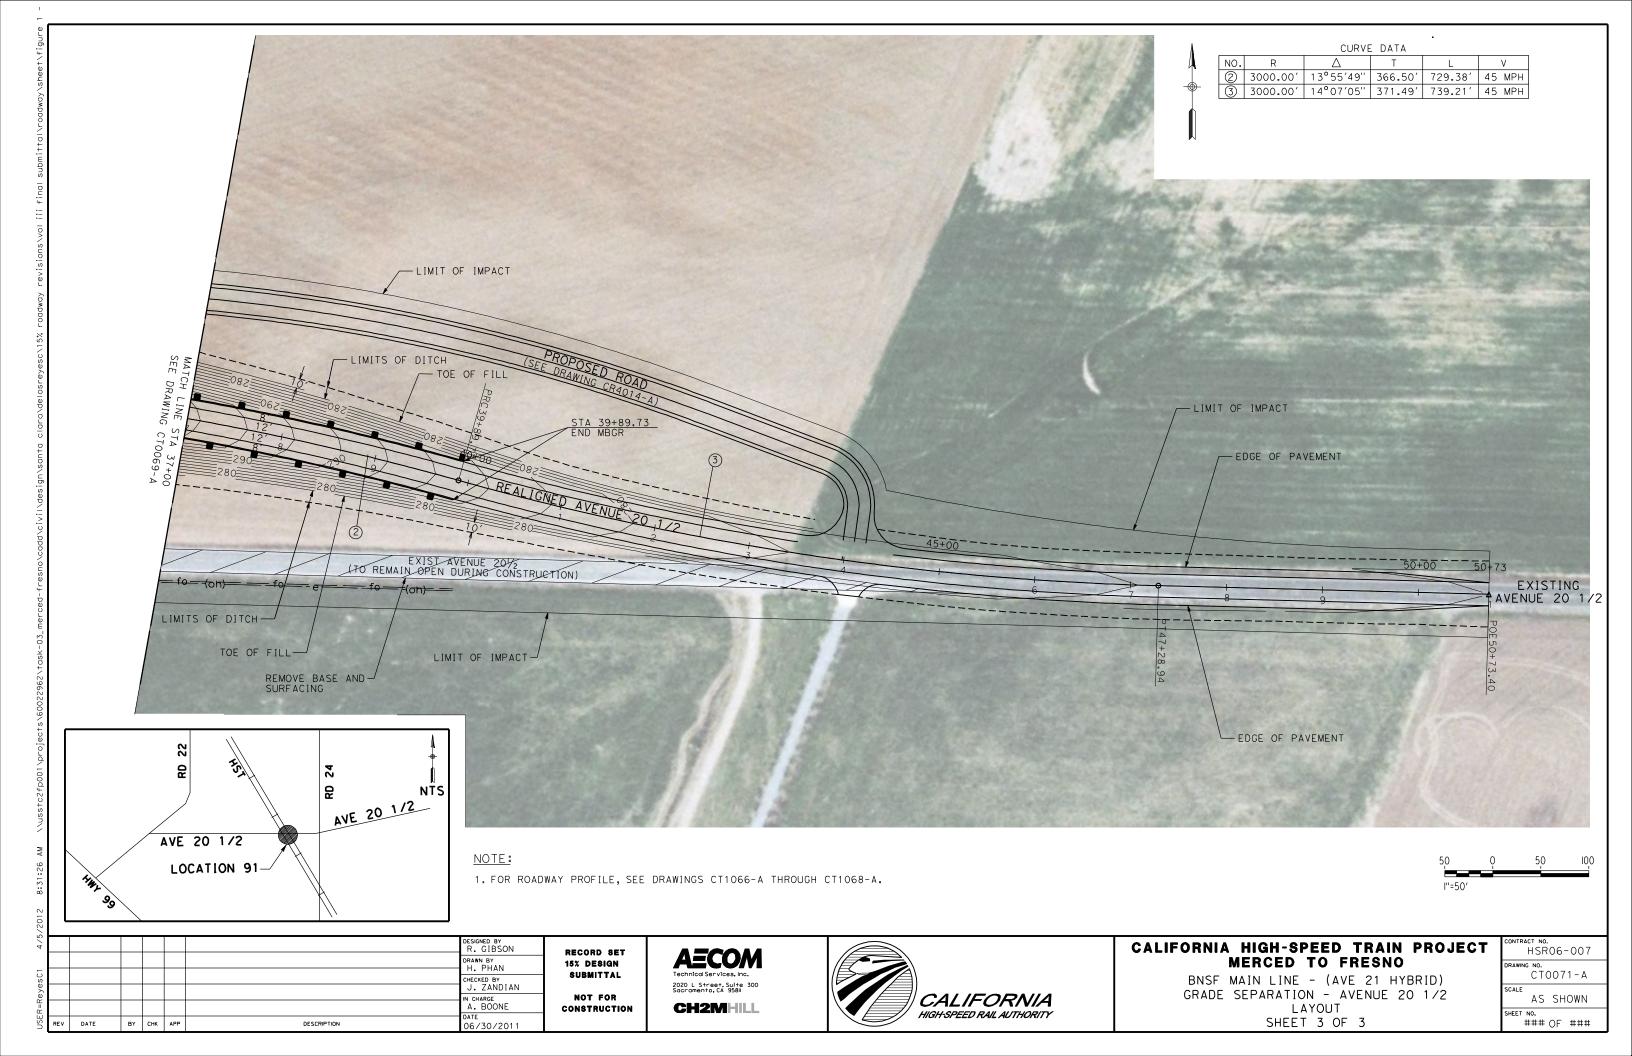

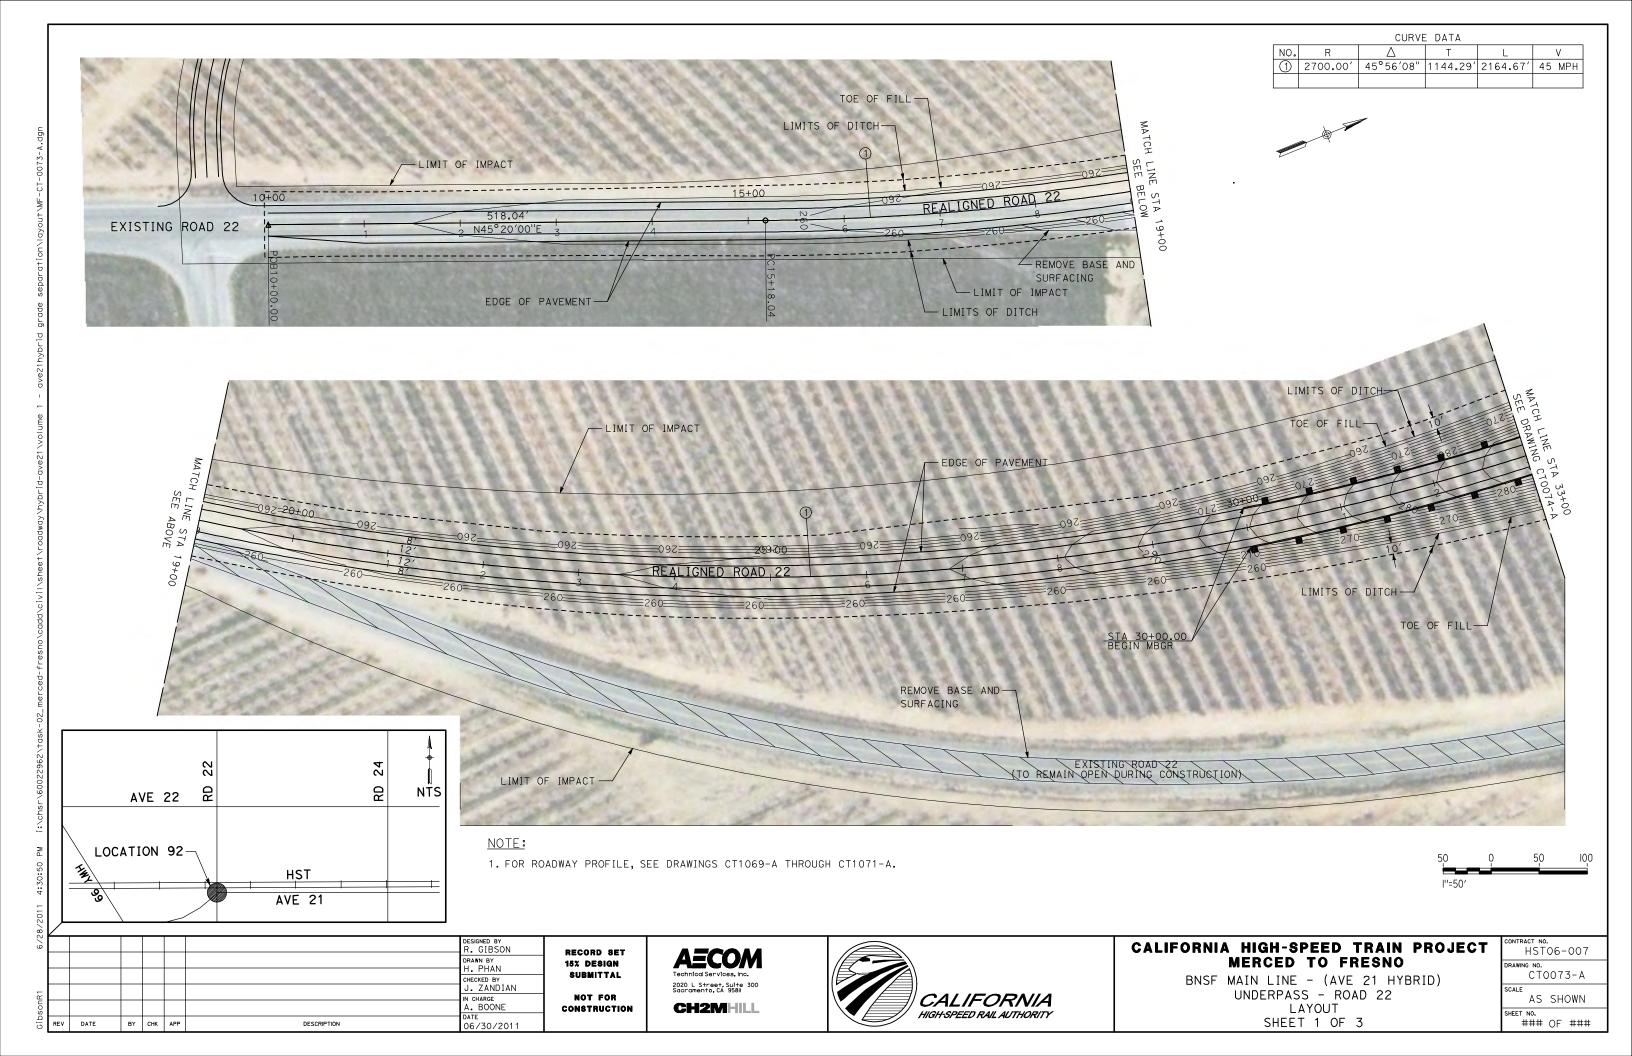

DESIGNED BY R. GIBSON DRAWN BY H. PHAN CHECKED BY
J. ZANDIAN N CHARGE A. BOONE DATE 06/30/2011 REV DATE BY CHK APP DESCRIPTION

15% DESIGN SUBMITTAL NOT FOR CONSTRUCTION

RECORD SET

CH2MHILL






EXIST ROAD 22


BNSF MAIN LINE - (AVE 21 HYBRID) UNDERPASS - ROAD 22 LAYOUT SHEET 3 OF 3

T	contract no. HSR06-007		
	DRAWING NO. CTOO75-A		
	AS SHOWN		
	SHEET NO. ### OF ###		

50

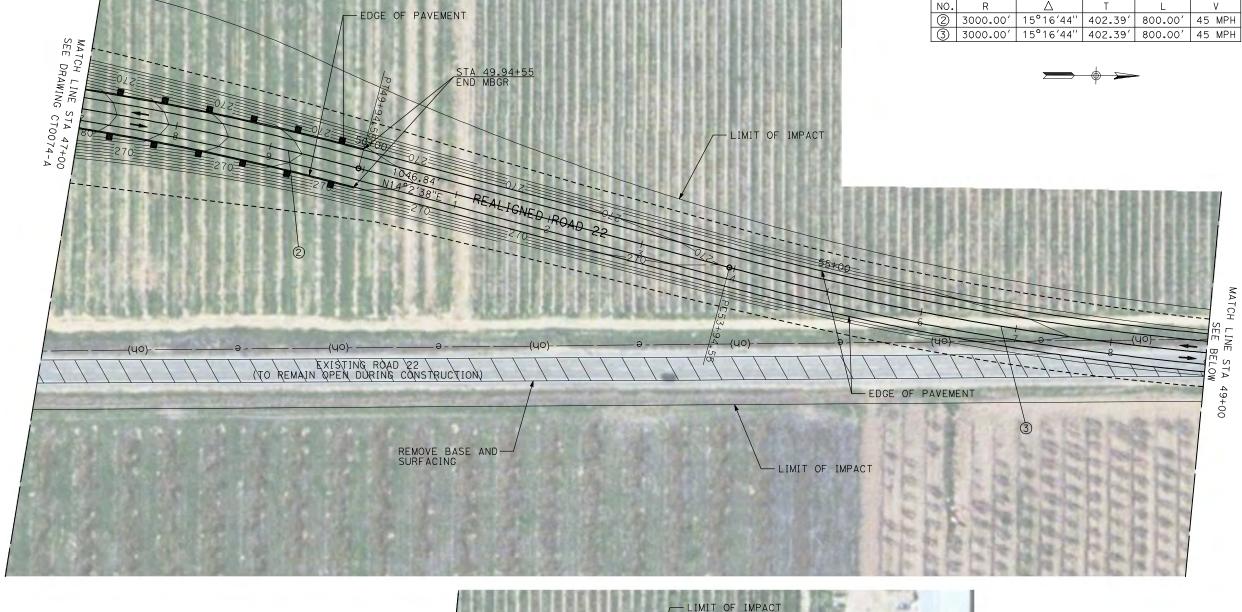

NOTE: 1. FOR ROADWAY PROFILE, SEE DRAWINGS CT1069-A THROUGH CT1071-A.

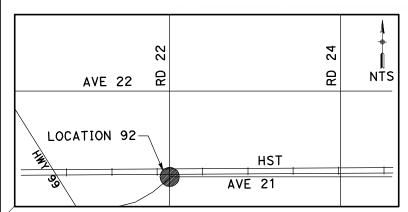





-EDGE OF LIMIT OF IMPACT

CH2MHILL

CONSTRUCTION

DATE 06/30/2011

BY CHK APP


DESCRIPTION


CURVE DATA

LAYOUT

SHEET 1 OF 3


HEET NO. ### OF ###

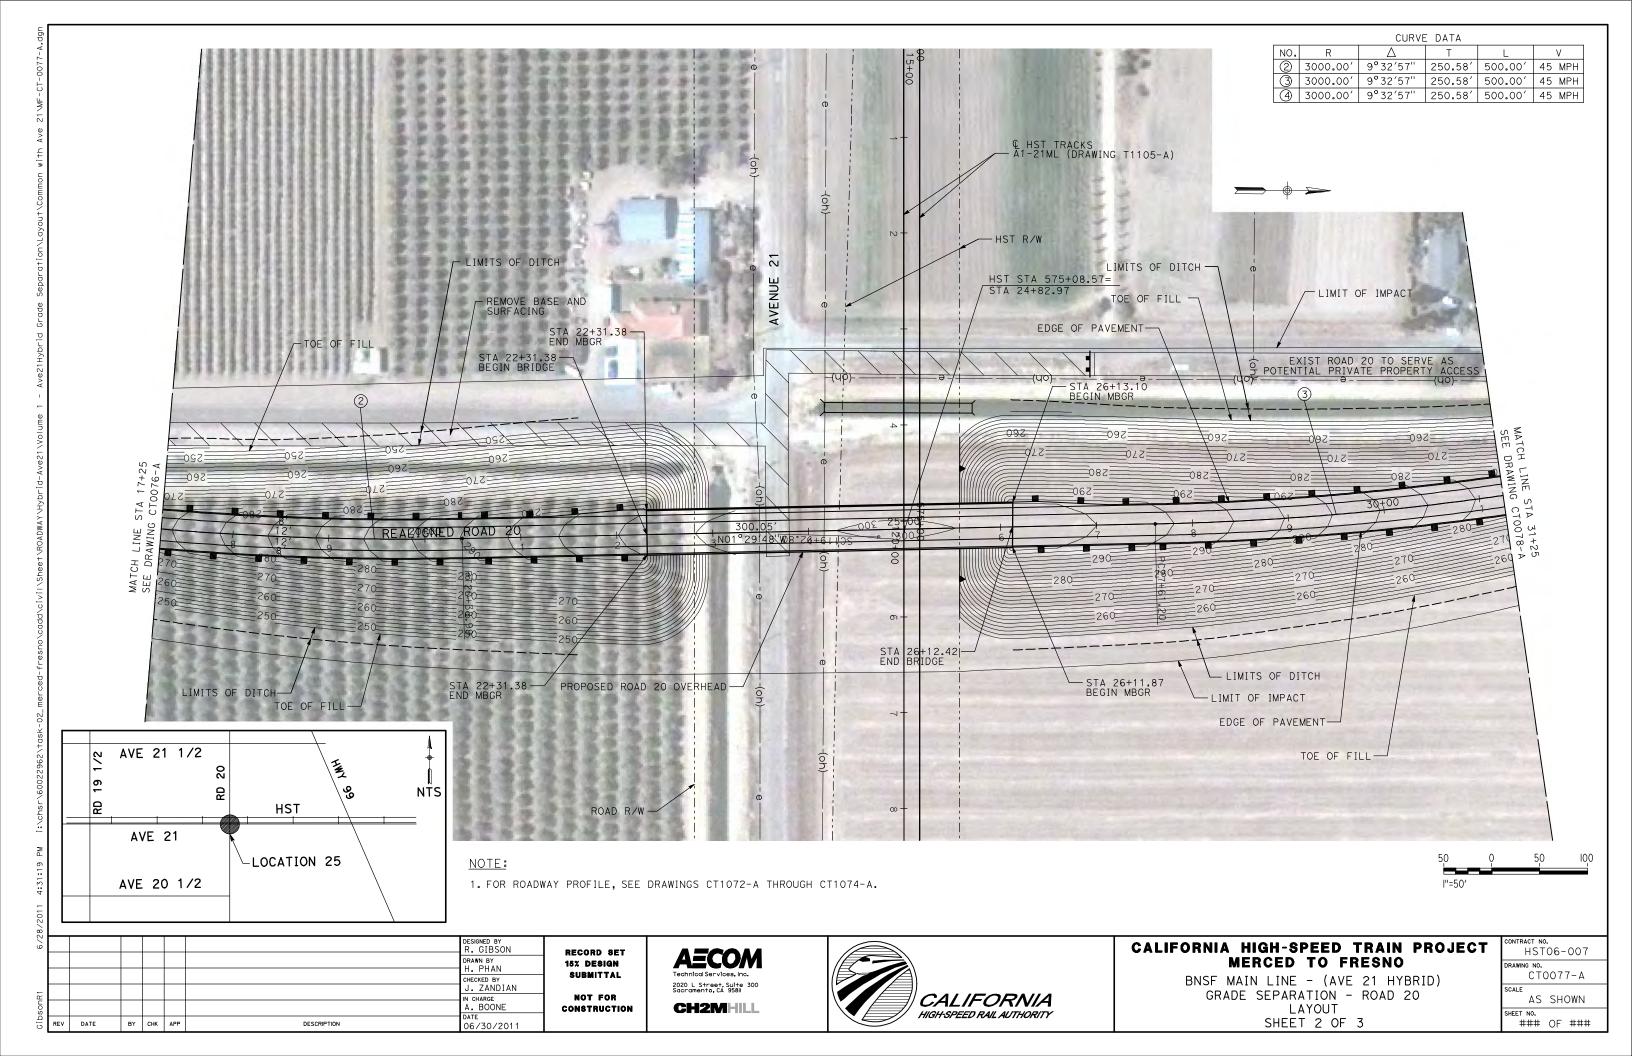

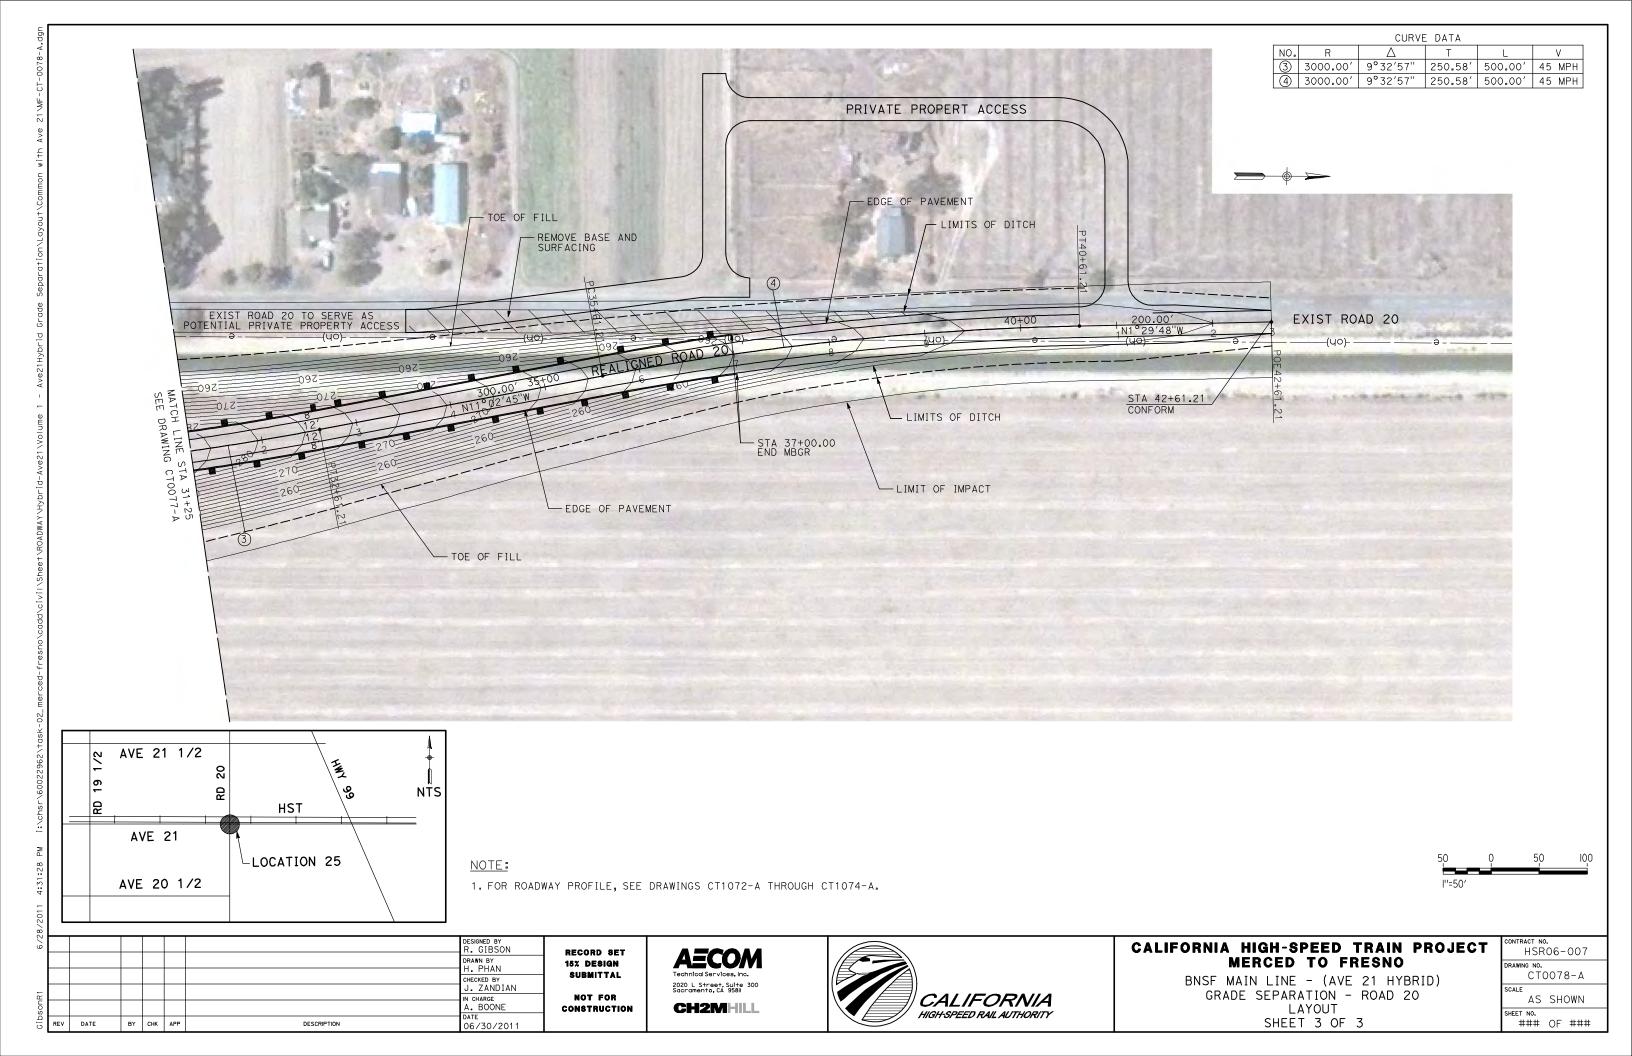

CURVE DATA 9°32′57" | 250.58′ | 500.00′ | 45 MPH | ② 3000.00′ 9°32′57" 250.58′ 500.00′ 45 MPH



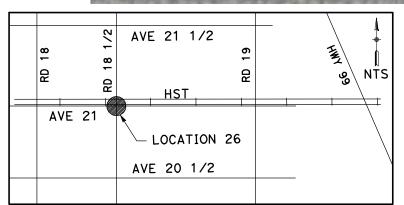

NOTE:

1. FOR ROADWAY PROFILE, SEE DRAWINGS CT1075-A THROUGH CT1077-A.



RAWING NO. CT0079-A

AS SHOWN HEET NO. ### OF ###

HST06-007

L						
						DESIGNED BY R. GIBSON
						DRAWN BY H. PHAN
						CHECKED BY
						J. ZANDIAN IN CHARGE
						A. BOONE
REV	DATE	BY	СНК	APP	DESCRIPTION	DATE 06/30/2011

RECORD SET 15% DESIGN SUBMITTAL NOT FOR CONSTRUCTION

AECOM 2020 L Street, Suite 300 Sacramento, CA 95811 CH2MHILL



CALIFORNIA HIGH-SPEED TRAIN PROJECT MERCED TO FRESNO BNSF MAIN LINE - (AVE 21 HYBRID)

GRADE SEPARATION - ROAD 18 1/2

LAYOUT

SHEET 1 OF 3

3000.00 250.58 500.00' 45 MPH 9°32′57" 3 | 3000.00′ 250.58' 500.00' 45 MPH __LIMITS OF DITCH HST STA 495+59.41= STA 24+50.41 TO REMAIN OPEN DURING CONSTRUCTION) AVE 21 1/2 NTS AVE 21 LOCATION 26 NOTE: AVE 20 1/2 1. FOR ROADWAY PROFILE, SEE DRAWINGS CT1075-A THROUGH CT1077-A. DESIGNED BY R. GIBSON CALIFORNIA HIGH-SPEED TRAIN PROJECT HSR06-007 RECORD SET DRAWN BY H. PHAN MERCED TO FRESNO 15% DESIGN RAWING NO. SUBMITTAL CT0080-A CHECKED BY
J. ZANDIAN BNSF MAIN LINE - (AVE 21 HYBRID) 2020 L Street, Suite 300 Sacramento, CA 95811 GRADE SEPARATION - ROAD 18 1/2 NOT FOR N CHARGE A. BOONE CALIFORNIA AS SHOWN **CH2M**HILL LAYOUT

HIGH-SPEED RAIL AUTHORITY

CONSTRUCTION

DATE 06/30/2011

BY CHK APP

DESCRIPTION

CURVE DATA

SHEET 2 OF 3

OF

						DESIGNED BY R. GIBSON
						DRAWN BY H. PHAN
						CHECKED BY
						J. ZANDIAN IN CHARGE
						A. BOONE
Eν	DATE	BY	СНК	APP	DESCRIPTION	DATE 06/30/2011

NOT FOR CONSTRUCTION





BNSF MAIN LINE - (AVE 21 HYBRID) GRADE SEPARATION - ROAD 18 1/2 LAYOUT SHEET 3 OF 3

	ACT NO HST		007
DRAWIN		008	1 – A
SCALE	AS	SHO	NWC
SHEET #	NO. ##	OF	###

CURVE DATA ① 5000.00' 6°52'32" 300.36' 600.00' 45 MPH © HST TRACKS HYBRID-ML (DRAWING T1125-A) -STA 10+00.00 BEGIN MBGR UPRR R/W LIMIT OF IMPACT-HST R/W STA 17+95.91 BEGIN MBGR EXIST ROAD 33 LIMITS OF DITCH-STA 15+39.79 -END MBGR LIMITS OF DITCH-TOE OF FILL-STA 15+59.00 -BEGIN BRIDGE LIMIT OF IMPACT--STA 10+00.00 BEGIN MBGR TOE OF FILL— TOE OF FILL STA 18+15.00 END BRIDGE EDGE OF PAVEMENT LIMITS OF DITCH-STA 15+74.39 -END MBGR LIMIT OF IMPACT-STA 18+30.39 BEGIN MBGR LIMIT OF IMPACT-AVE 8 PROPOSED AVENUE 7 OVERHEAD-EXIST AVENUE 7 8 31 UPRR-1. FOR ROADWAY PROFILE, SEE DRAWINGS CT1146-A THROUGH CT1148-A. AVE 7 LOCATION 65 DESIGNED BY R. GIBSON CALIFORNIA HIGH-SPEED TRAIN PROJECT HST06-007 RECORD SET DRAWN BY H. PHAN MERCED TO FRESNO 15% DESIGN AWING NO. SUBMITTAL CT0146-A BNSF MAIN LINE - (AVE 21 HYBRID)
GRADE SEPARATION - AVENUE 7 CHECKED BY A. SILVER 2020 L Street, Suite 300 Sacramento, CA 95811 NOT FOR IN CHARGE A. BOONE CALIFORNIA AS SHOWN LAYOUT CH2MHILL CONSTRUCTION HIGH-SPEED RAIL AUTHORITY SHEET 1 OF 3 OF ### BY CHK APP DESCRIPTION 06/30/2011

31

UPRR-

LOCATION 65 DESIGNED BY R. GIBSON DRAWN BY H. PHAN CHECKED BY A. SILVER IN CHARGE A. BOONE BY CHK APP DESCRIPTION 06/30/2011

LIMITS OF DITCH-

AVE 8

LIMIT OF IMPACT-

AVE 7

NTS

윤

LIMITS OF DITCH-

RECORD SET 15% DESIGN SUBMITTAL NOT FOR CONSTRUCTION

2020 L Street, Suite 300 Sacramento, CA 95811 CH2MHILL

EDGE OF PAVEMENT-



CALIFORNIA HIGH-SPEED TRAIN PROJECT MERCED TO FRESNO

BNSF MAIN LINE - (AVE 21 HYBRID) GRADE SEPARATION - AVENUE 7 LAYOUT SHEET 2 OF 3

CONTRACT NO.
HST06-007
DRAWING NO.
CT0147-A
SCALE
AS SHOWN

OF ###

I"=50'



CURVE DATA

NOTE:

STAA. 27+50.00-END MBGR


STA 27+50.00-END MBGR


EDGE OF PAVEMENT-


1. FOR ROADWAY PROFILE, SEE DRAWINGS CT1146-A THROUGH CT1148-A.


EXIST AVENUE 7




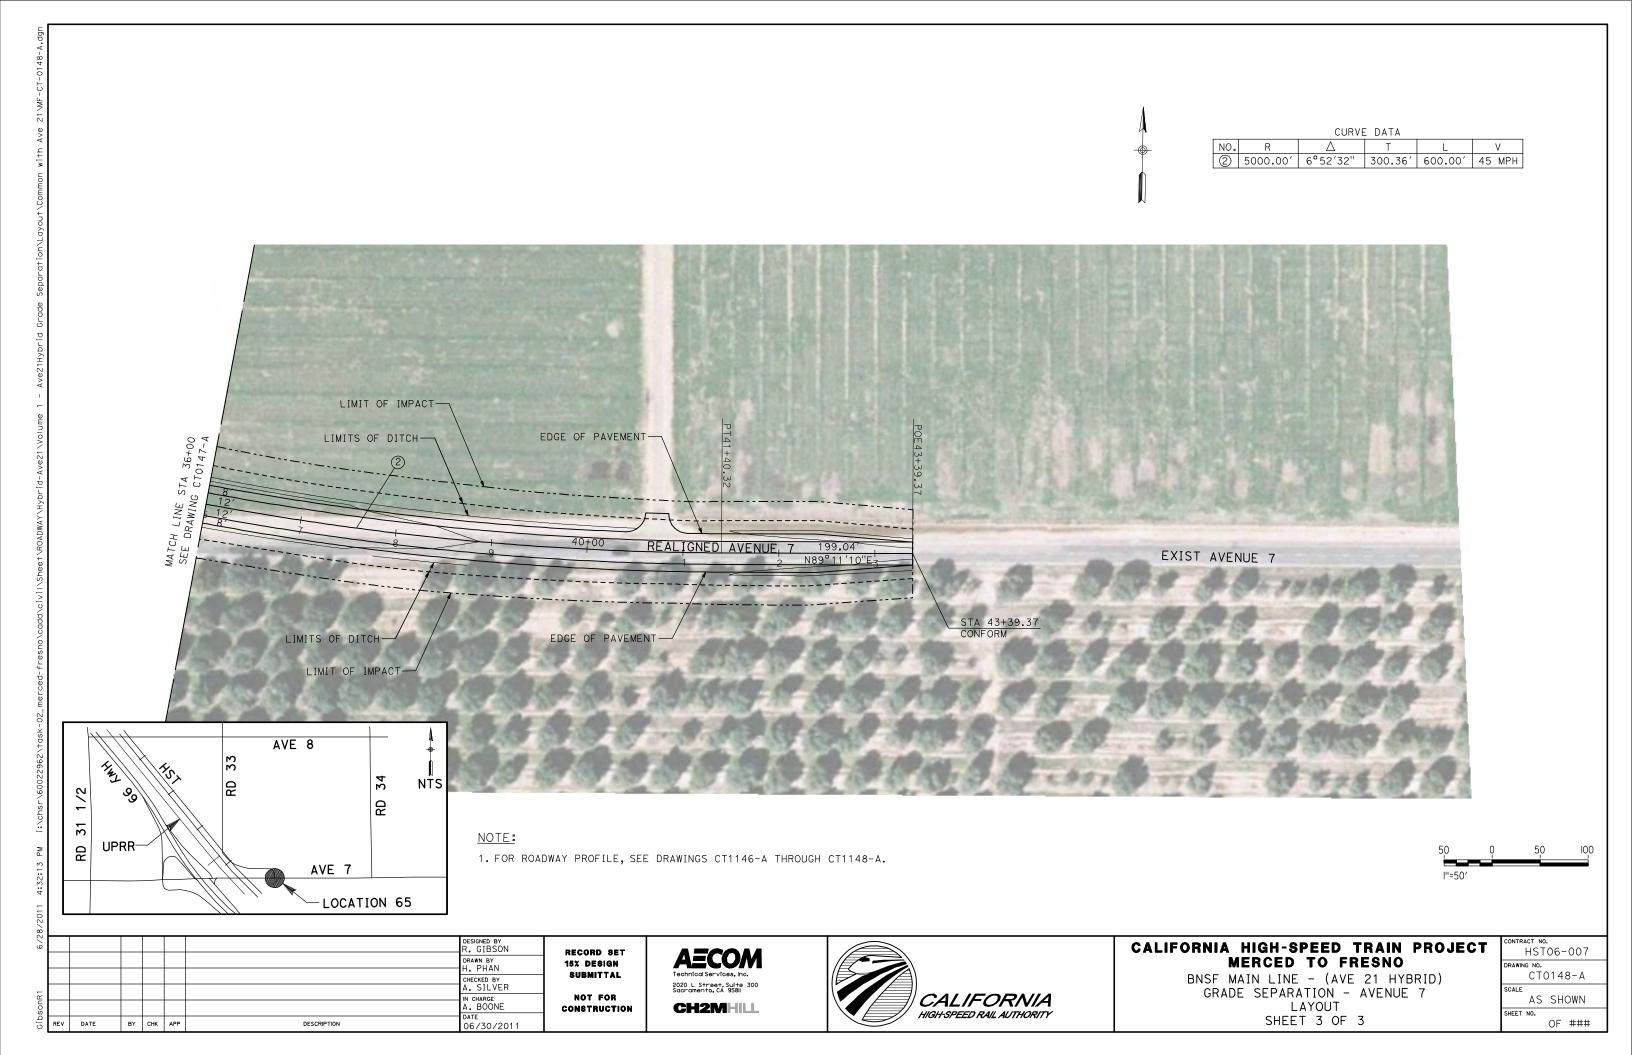


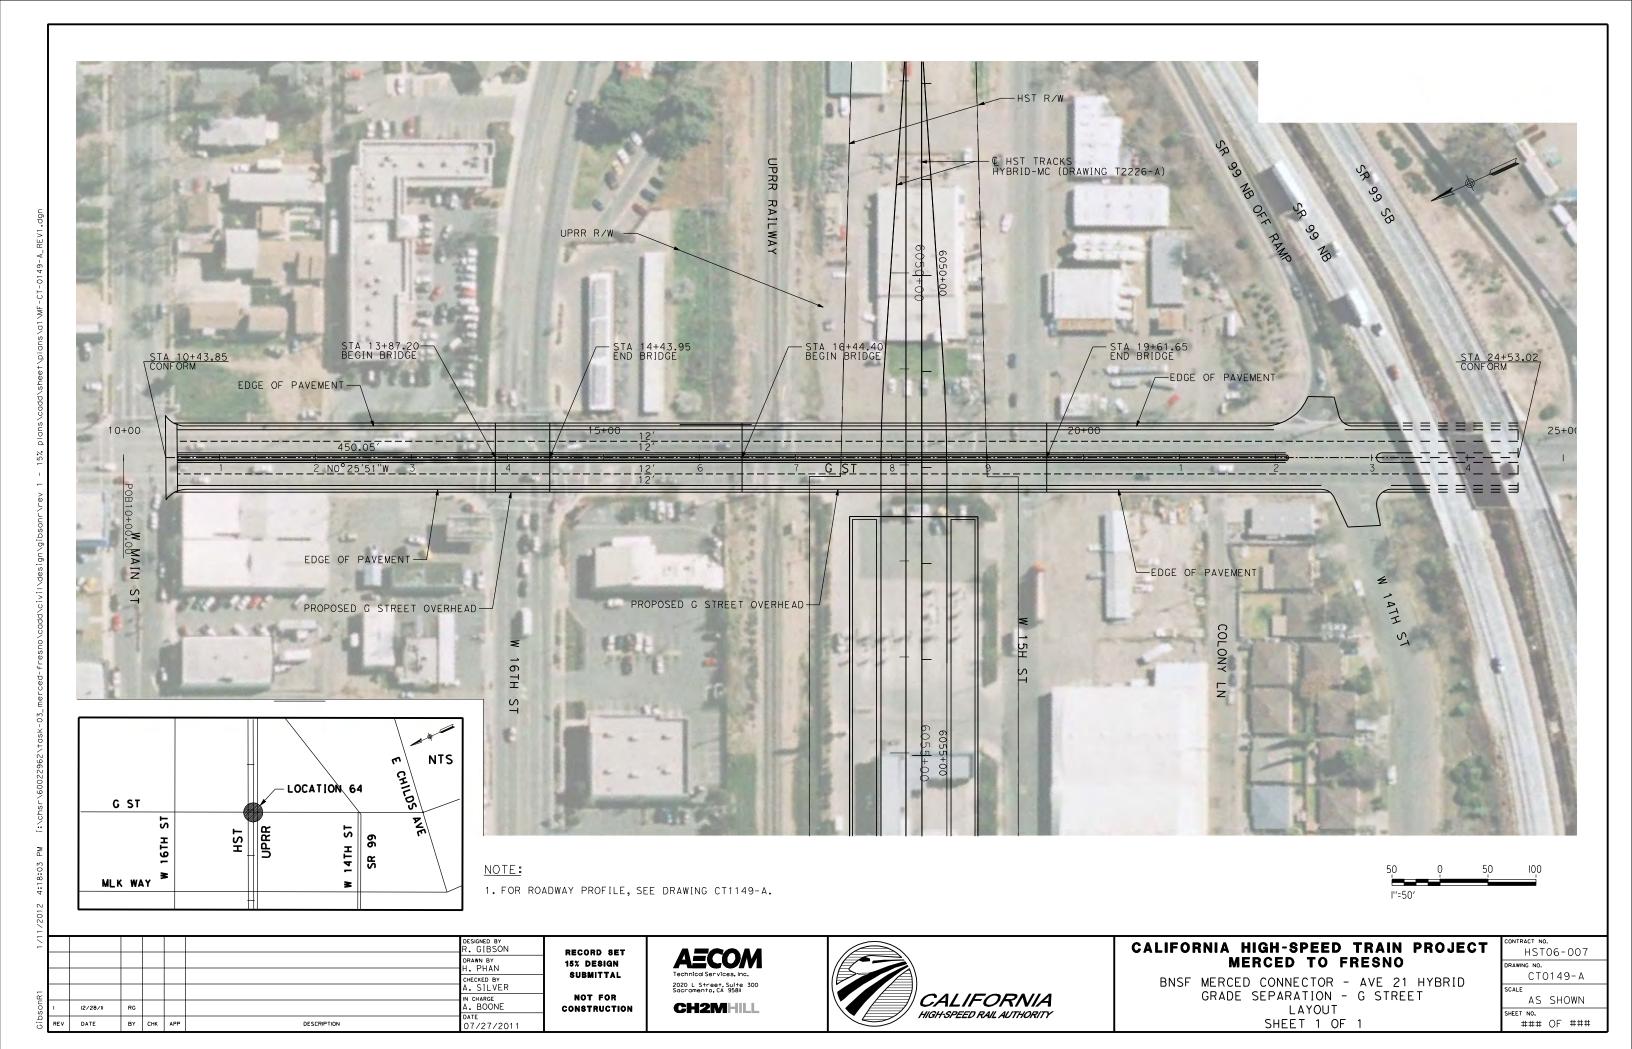


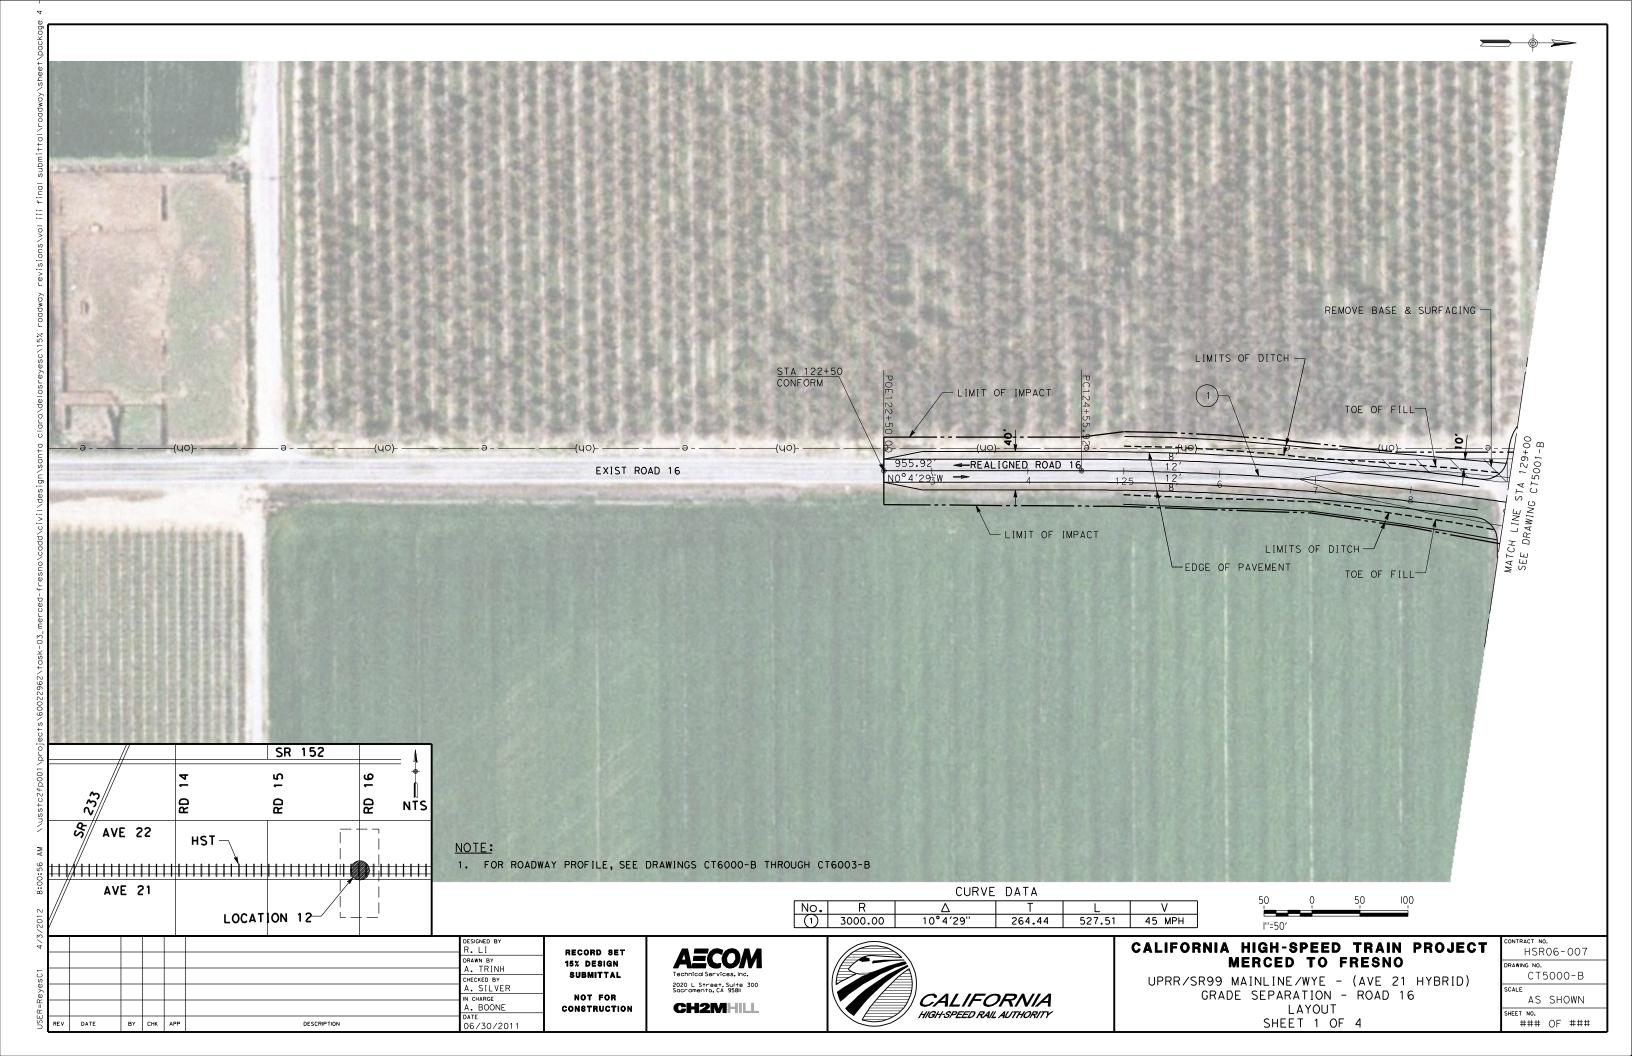


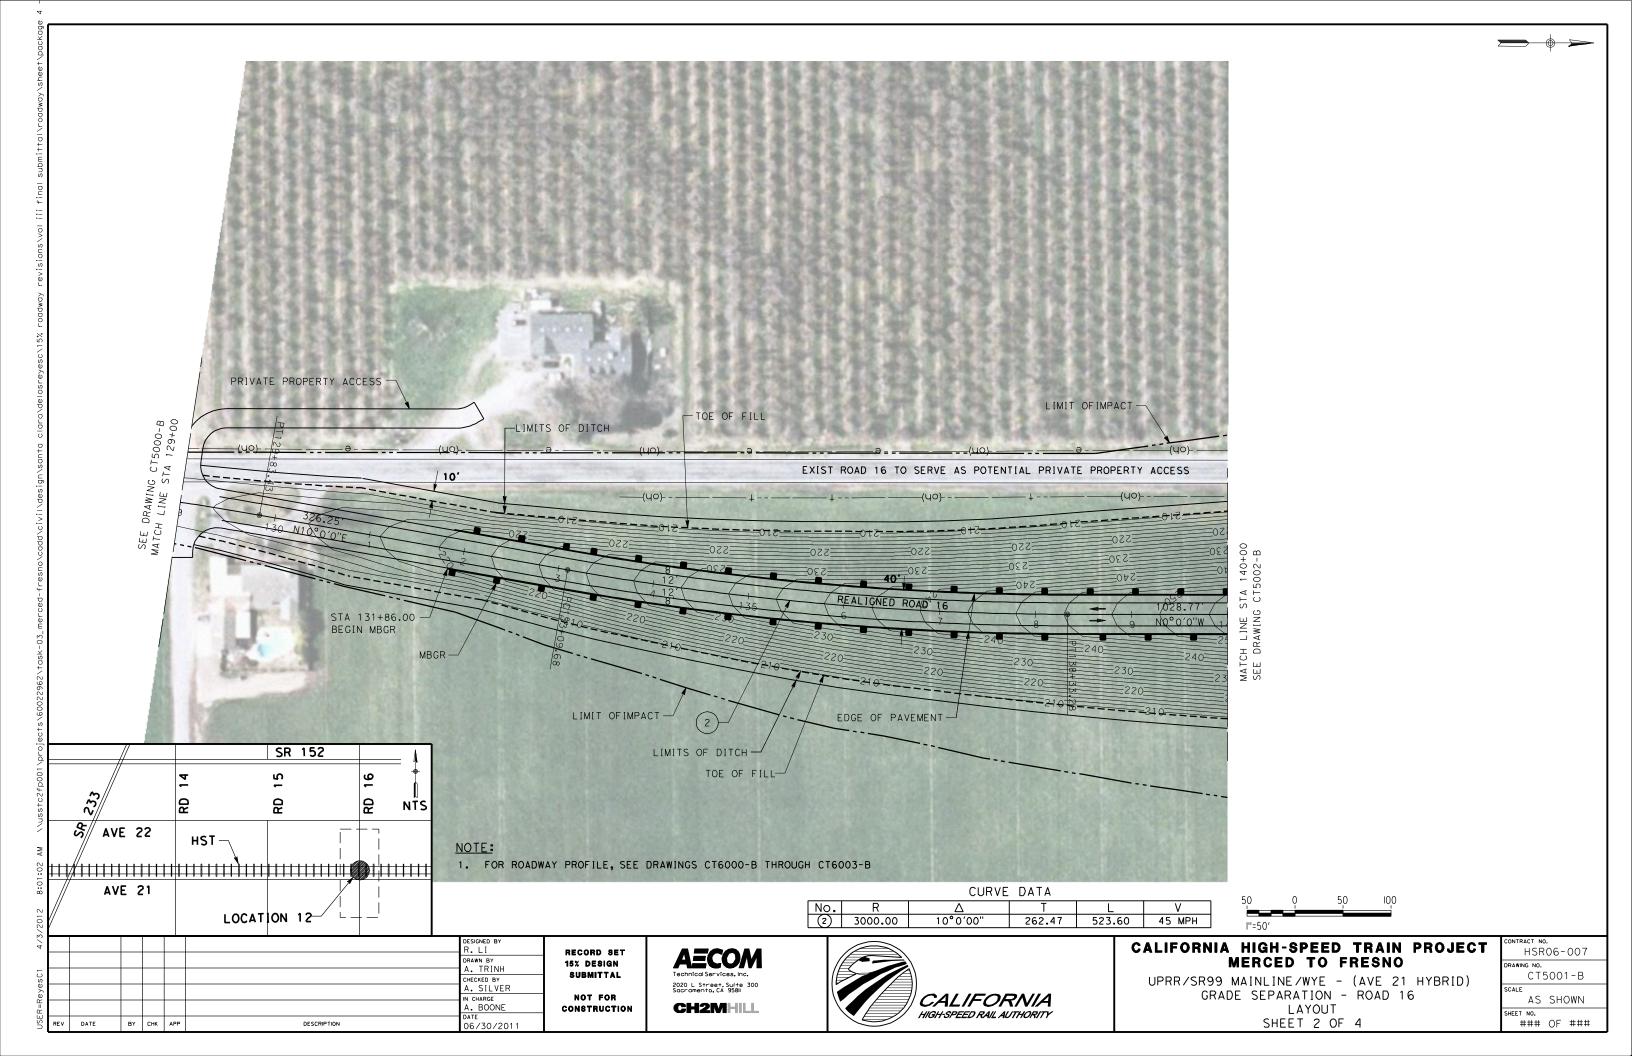


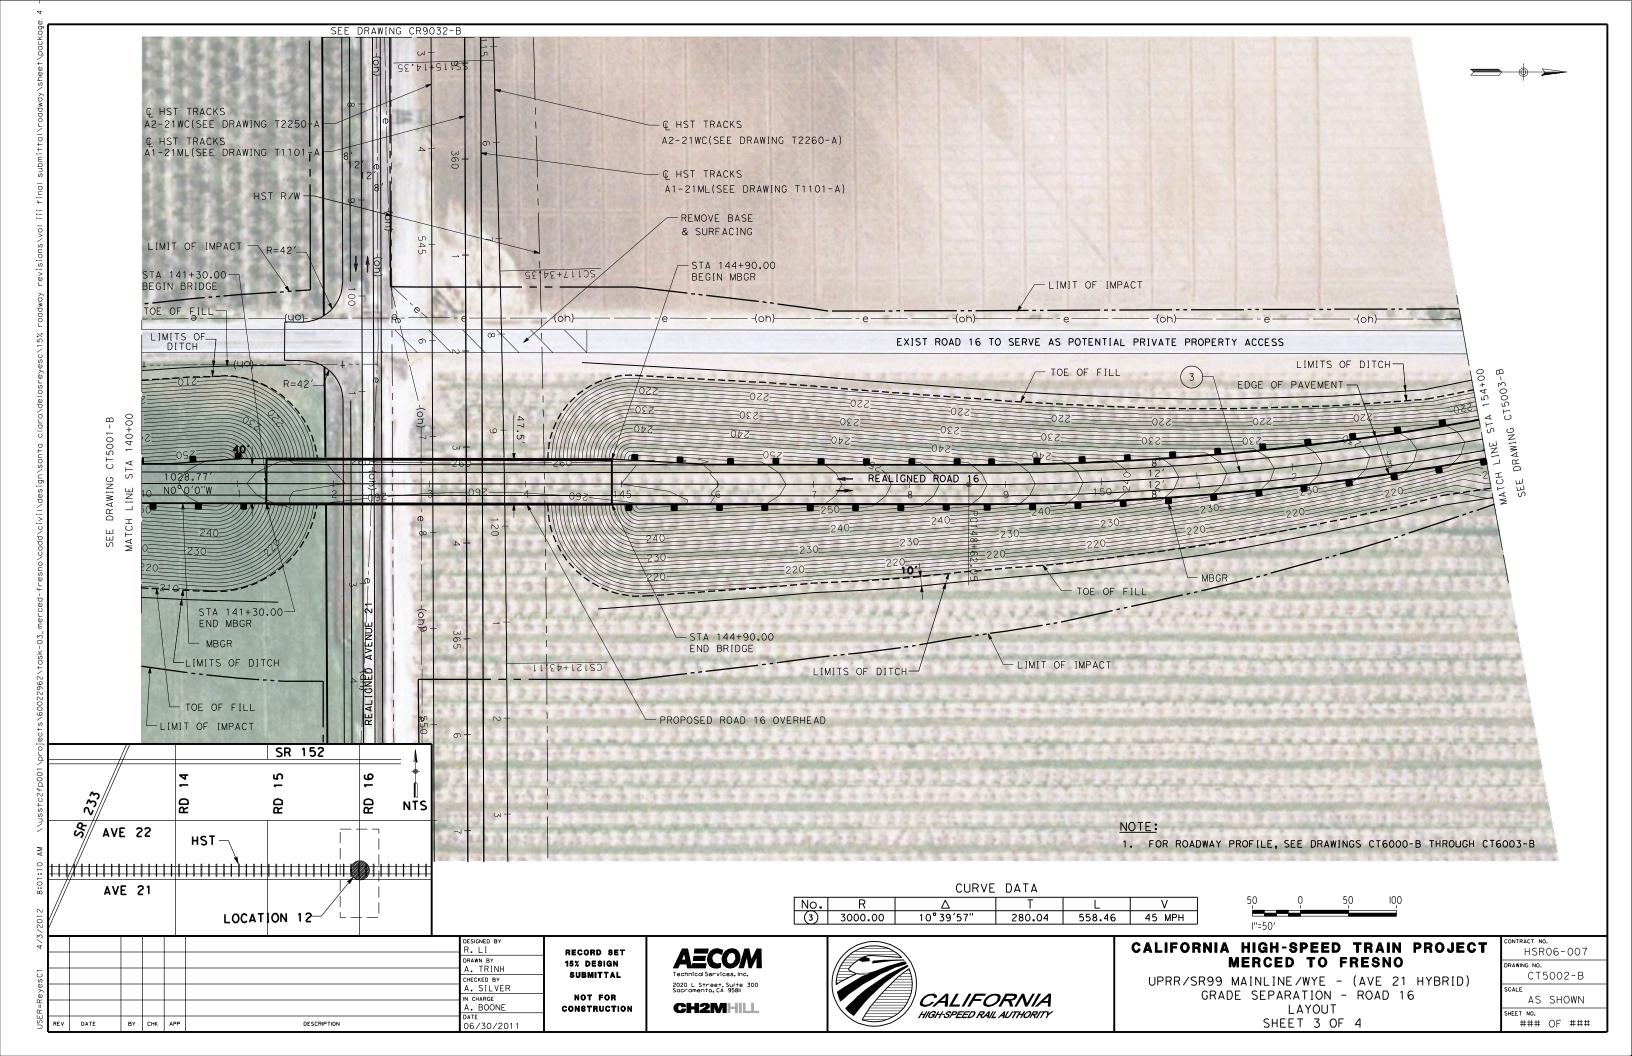

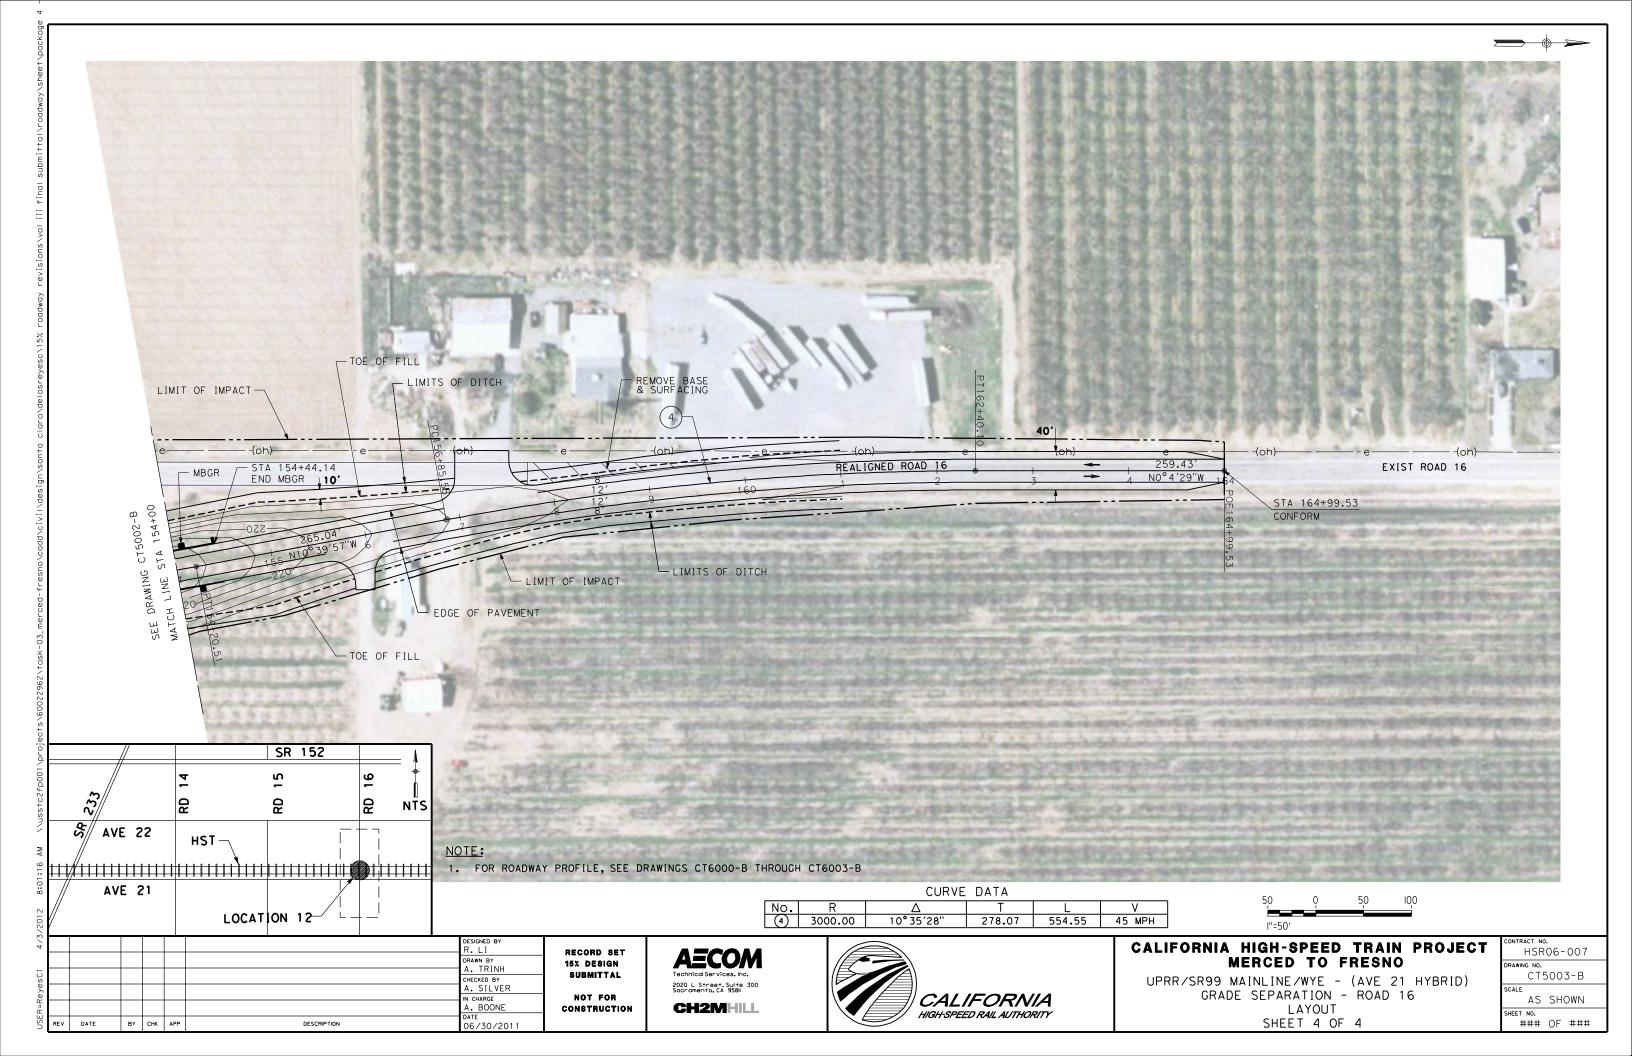


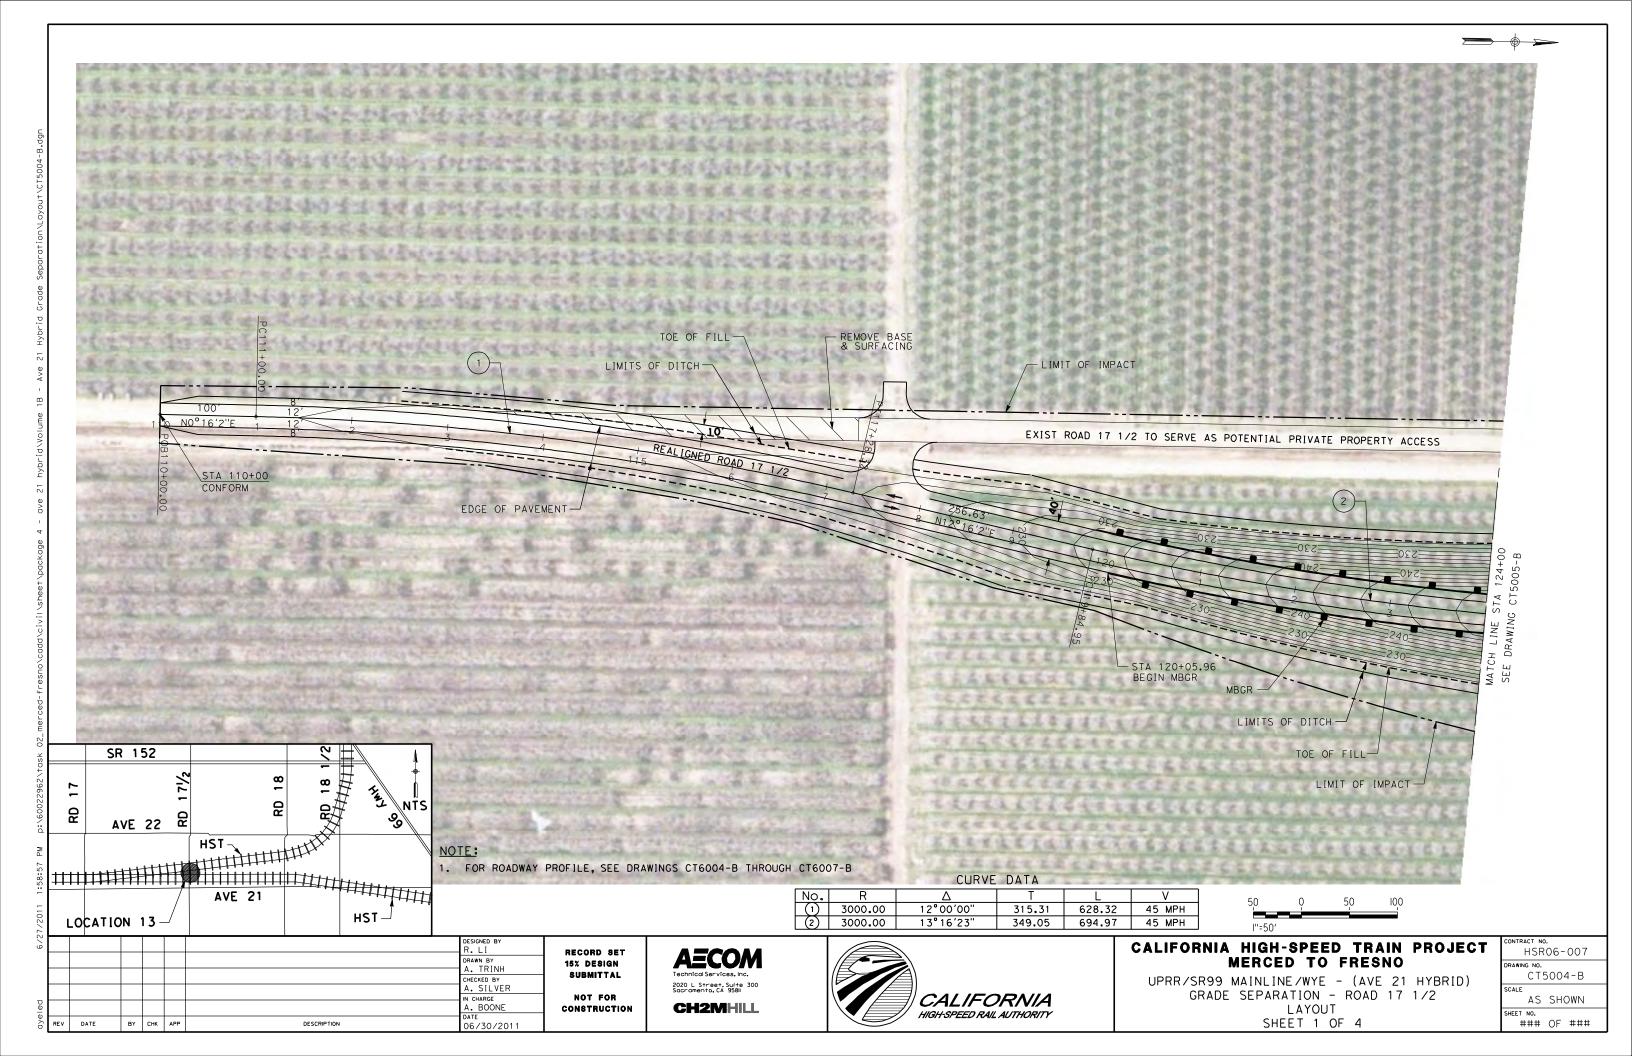


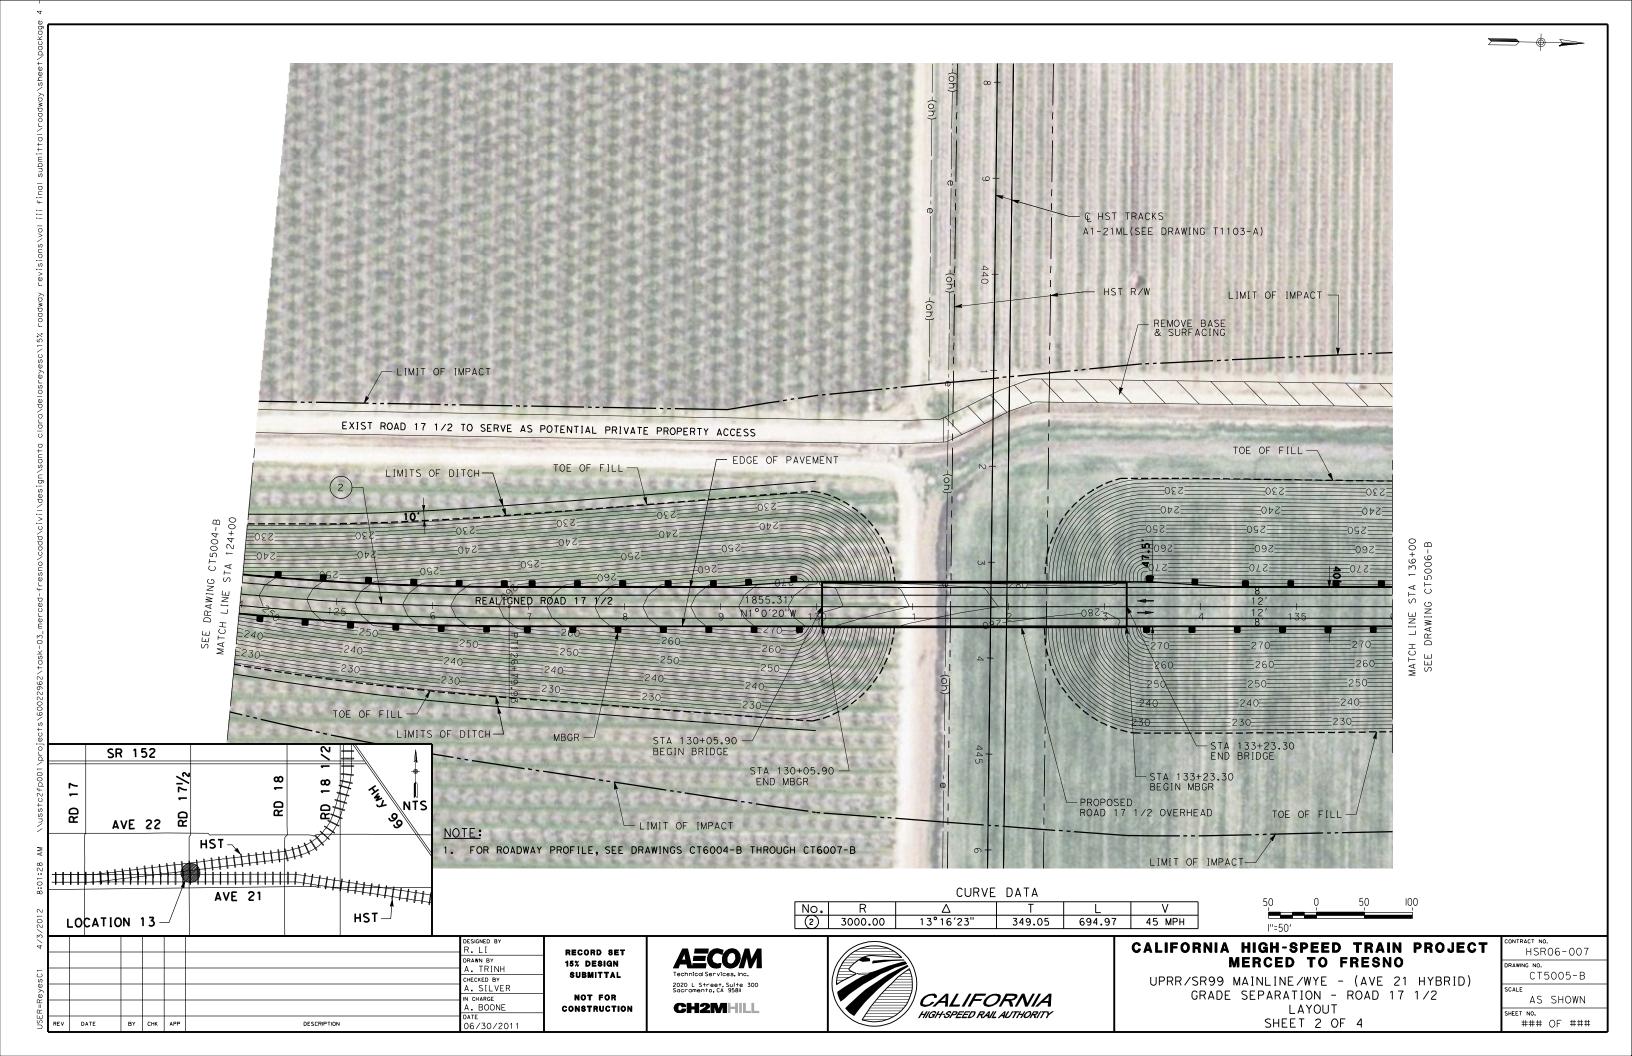


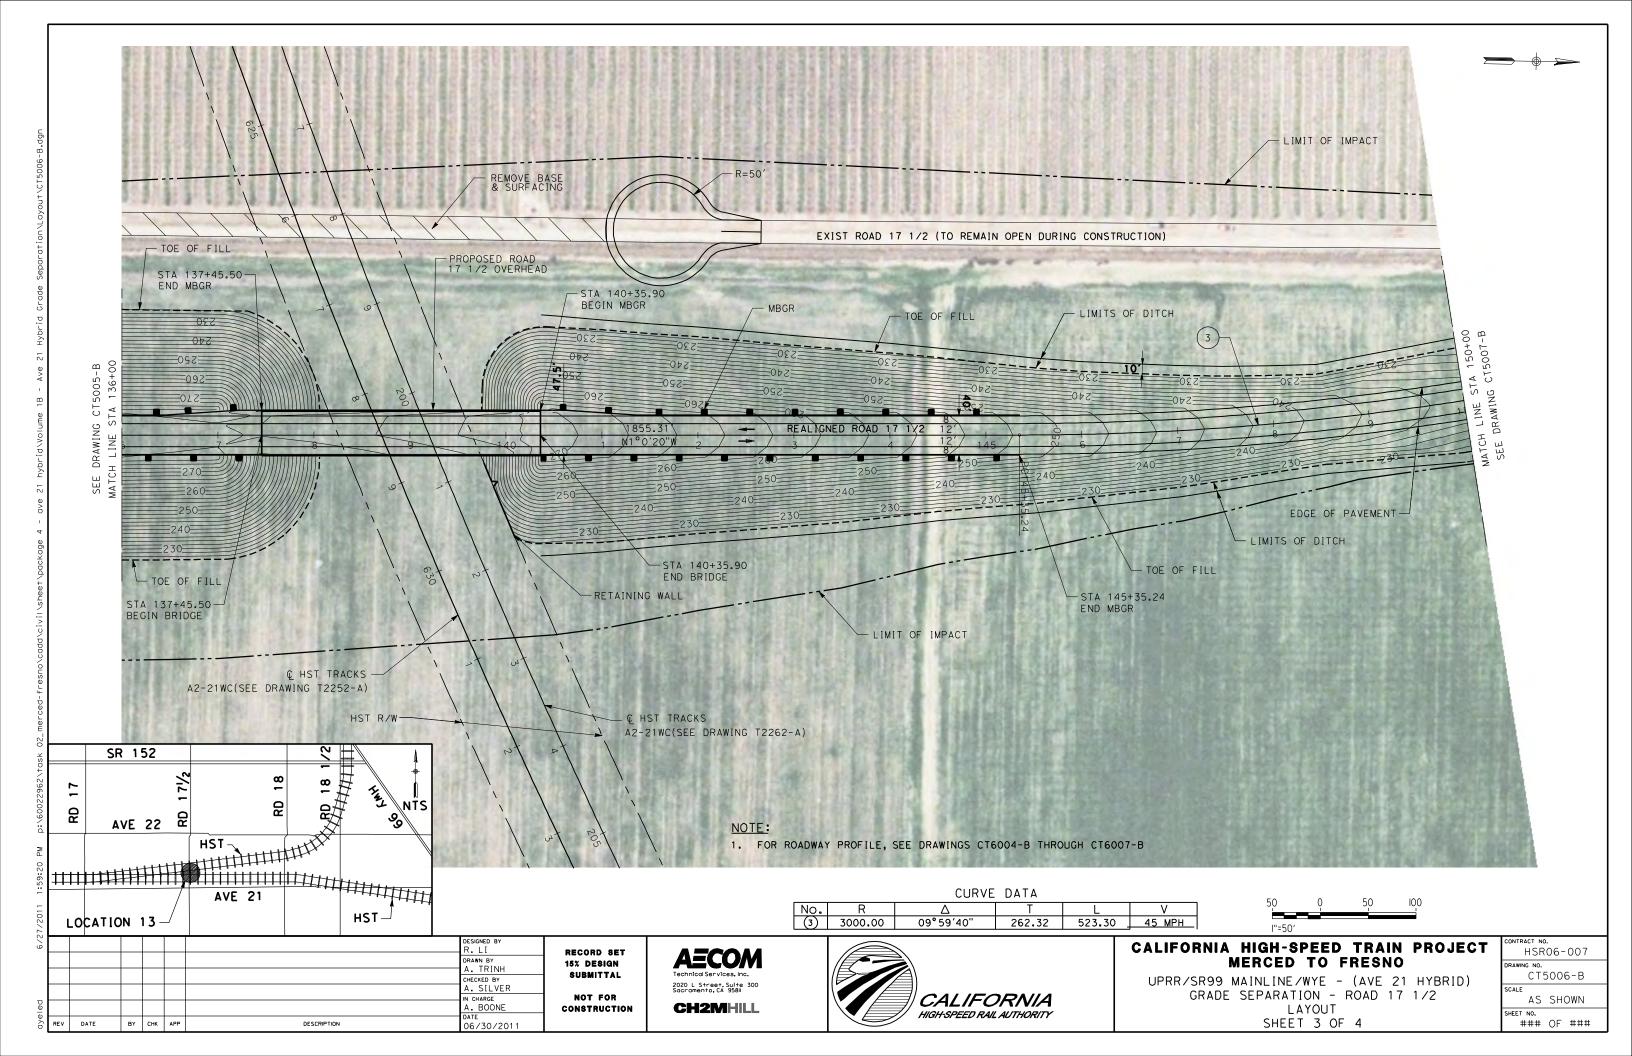





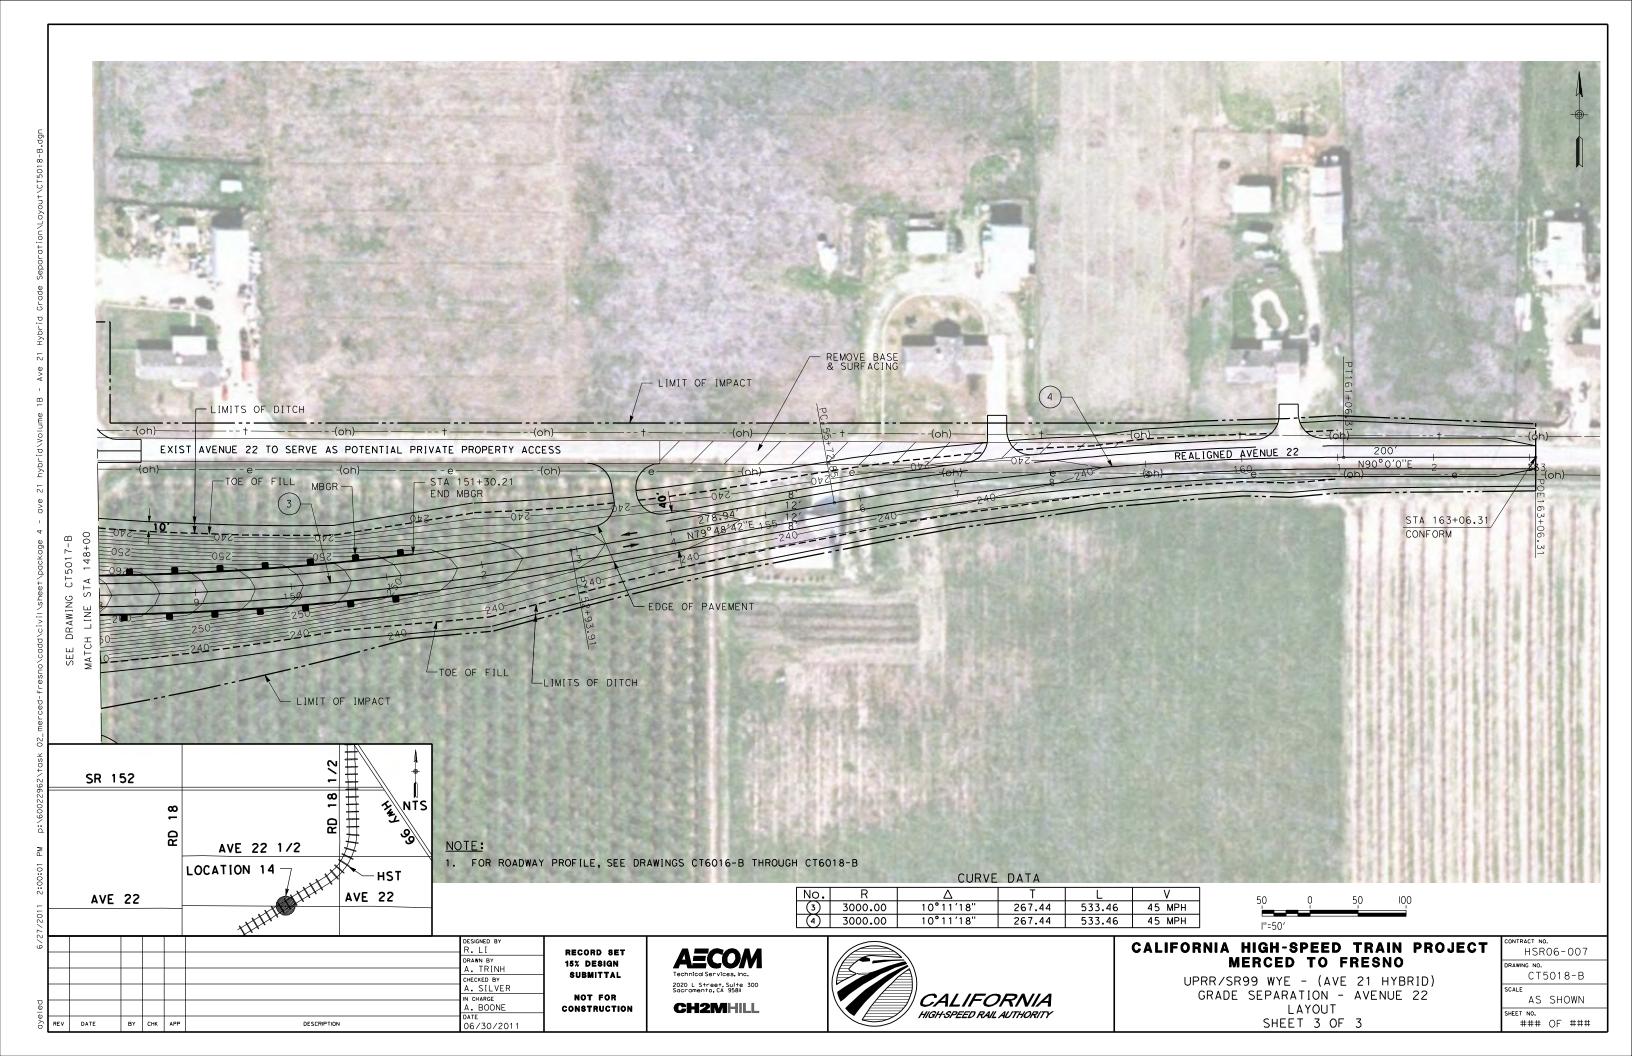


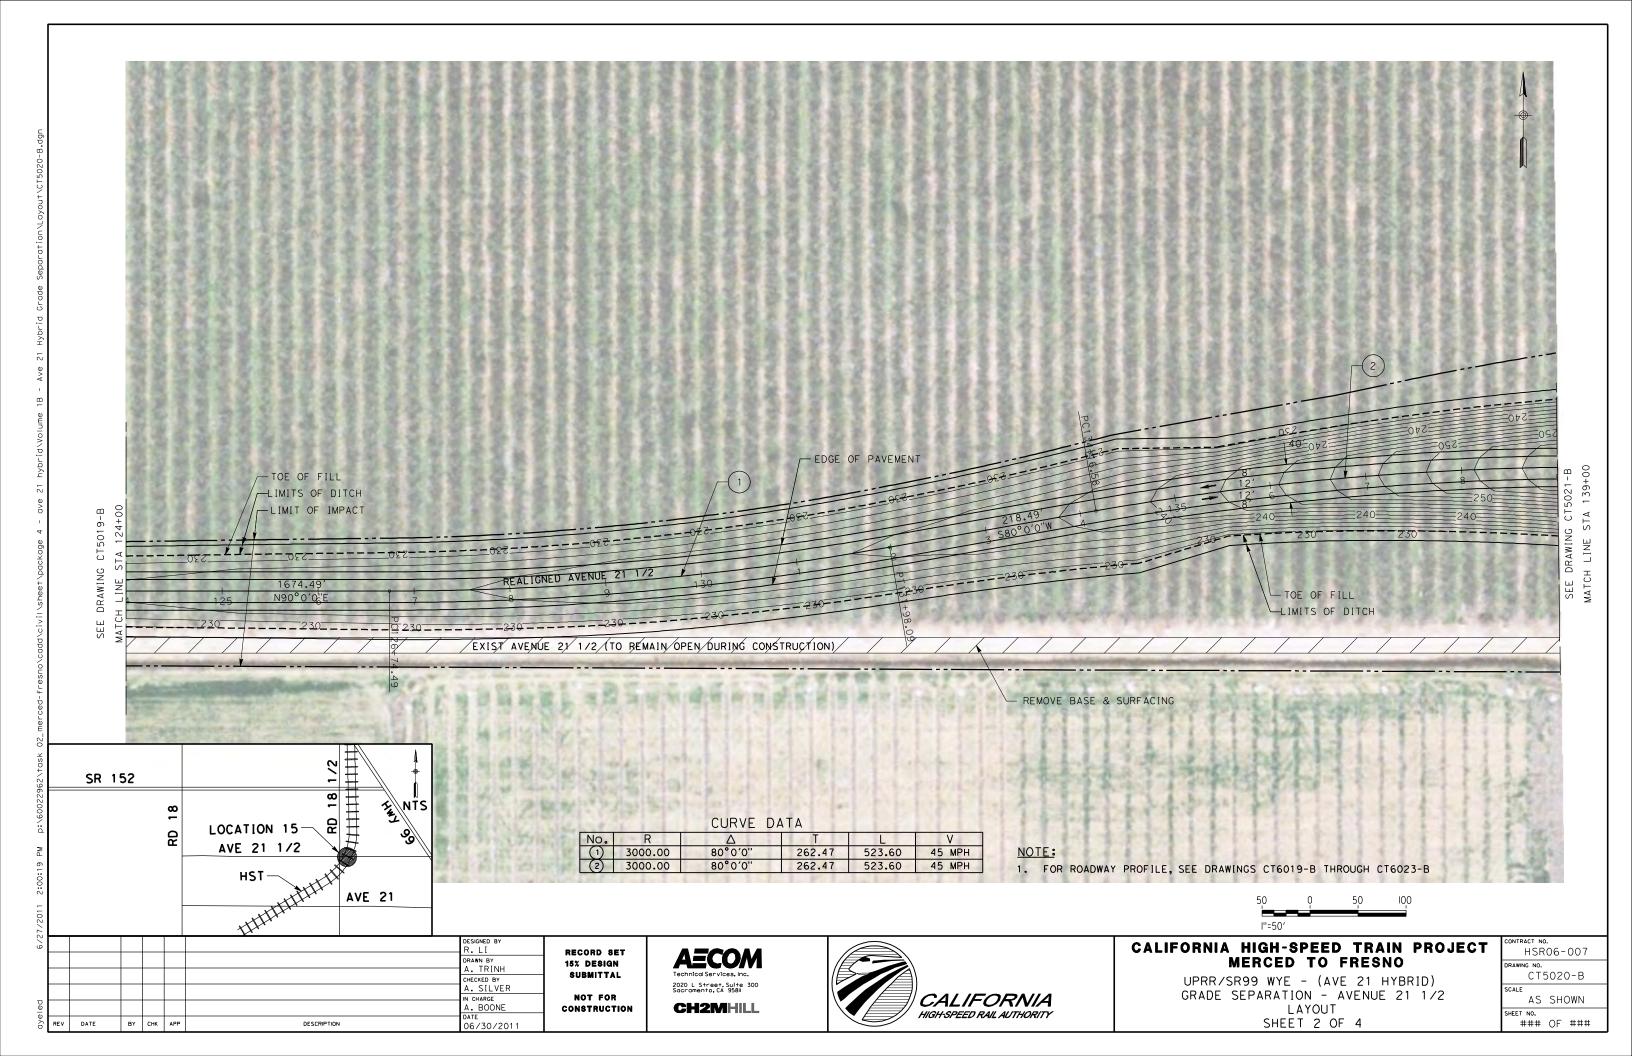


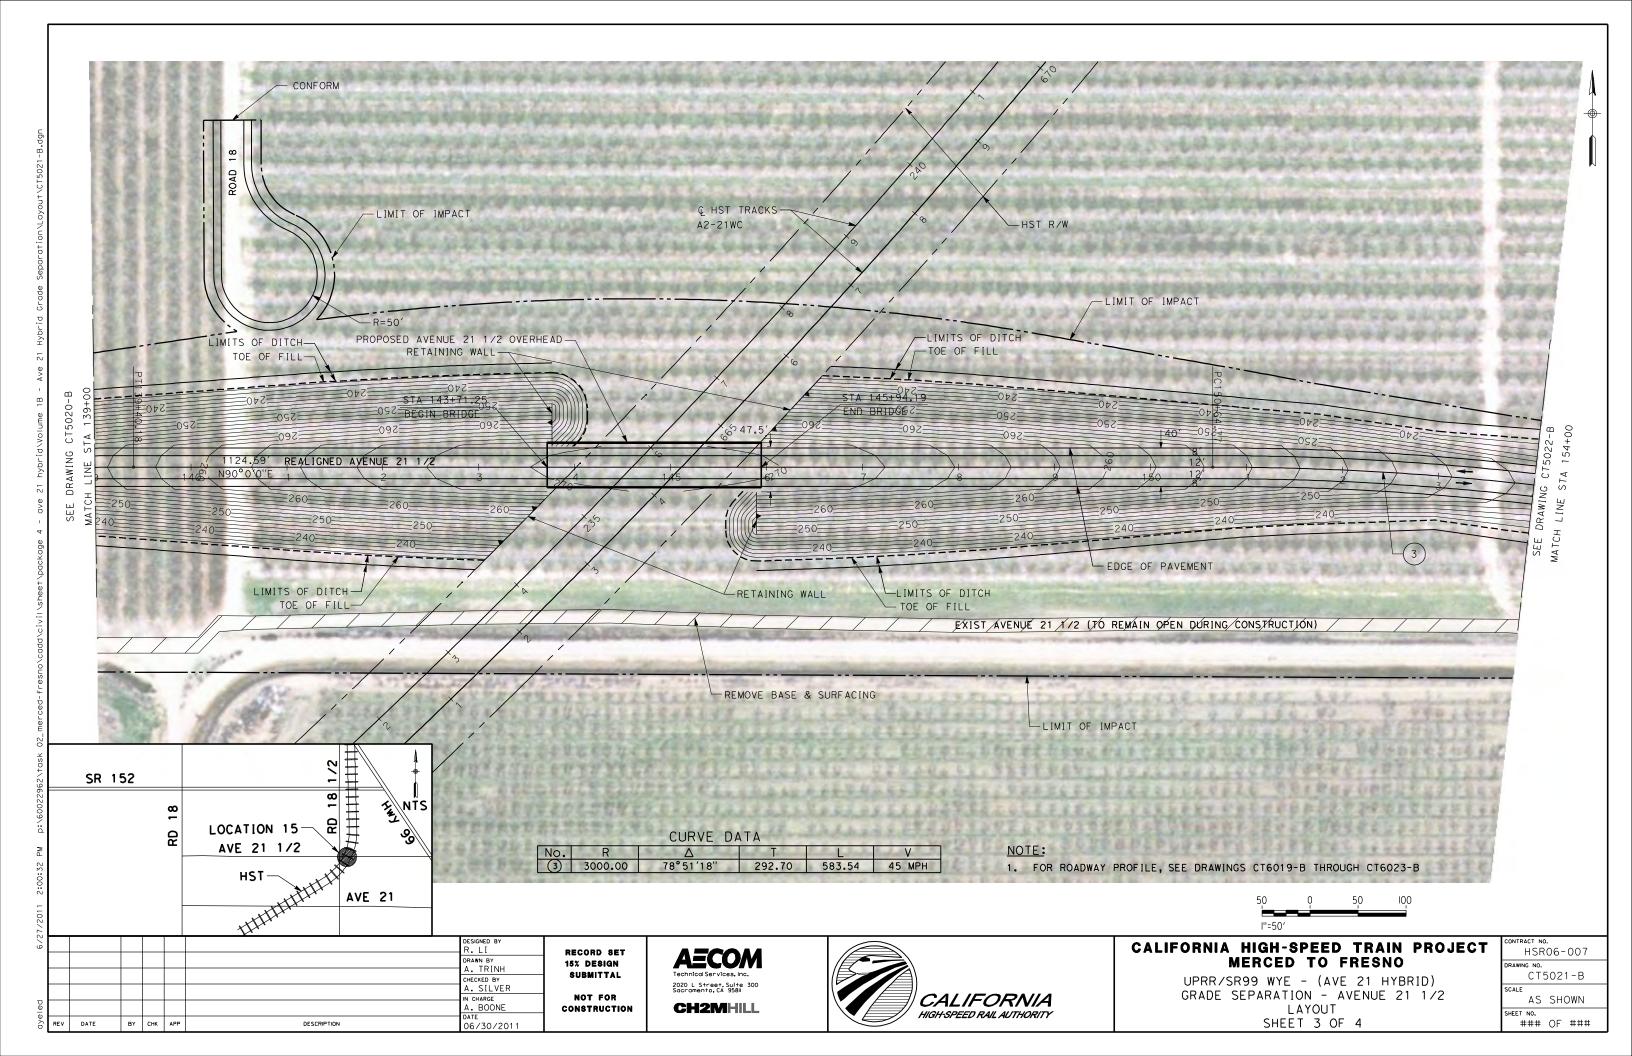

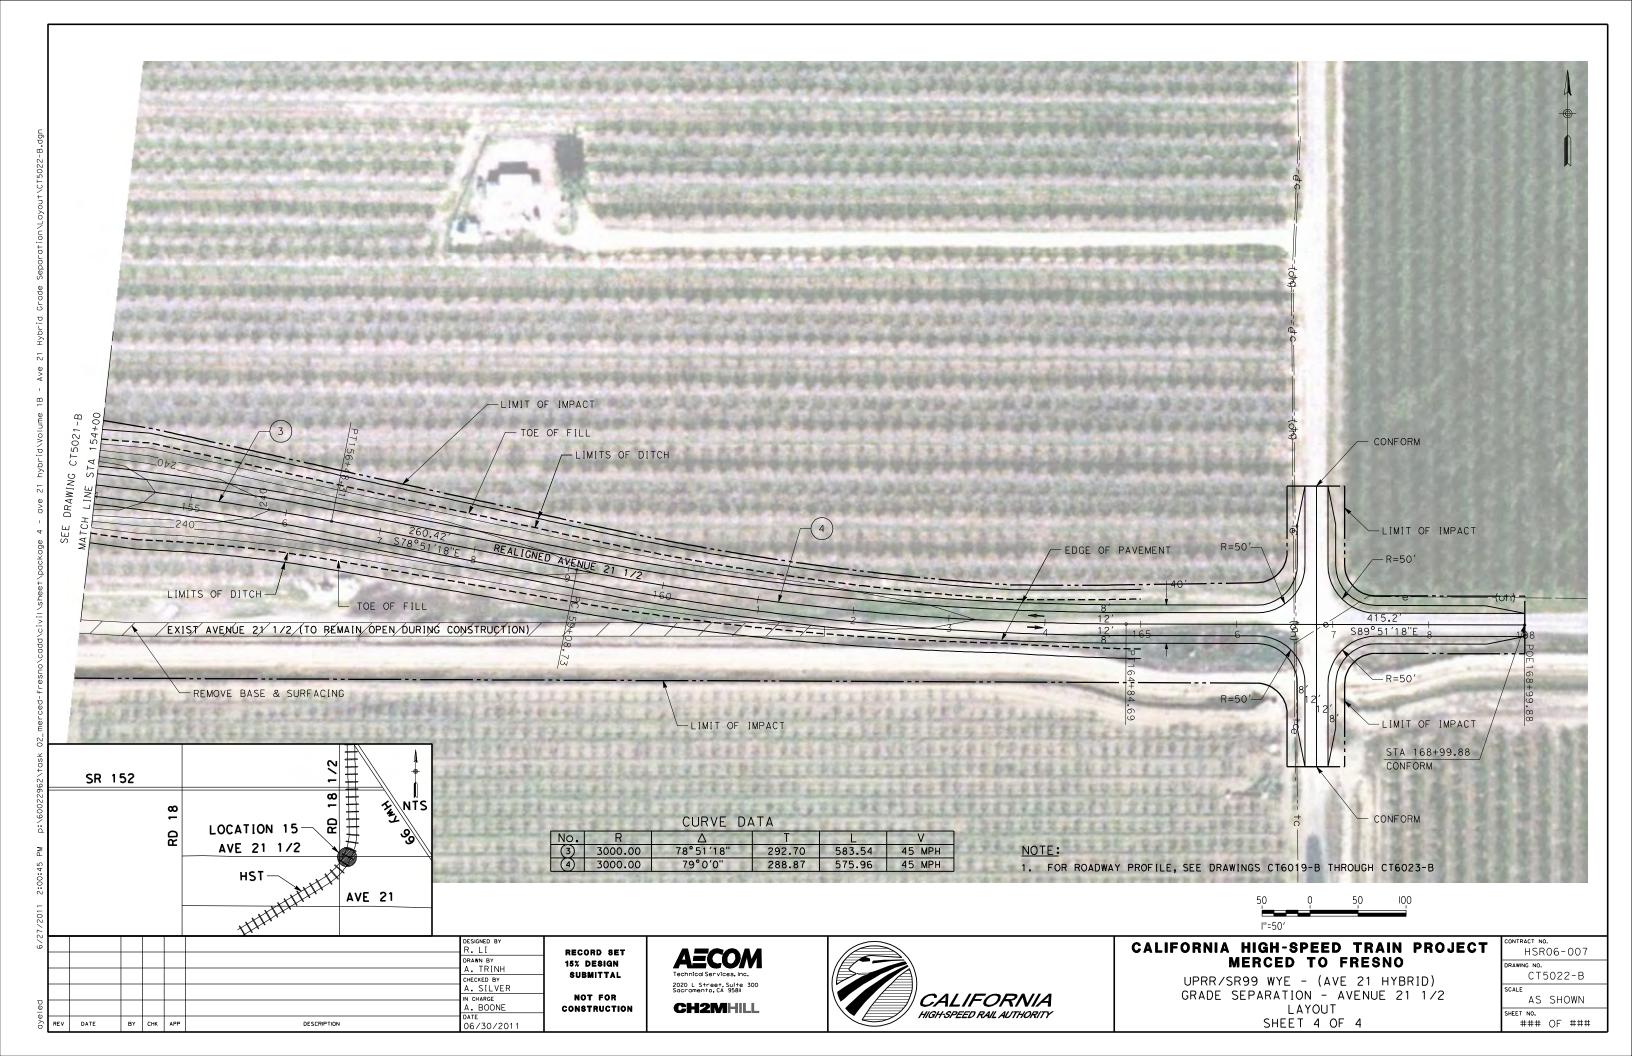

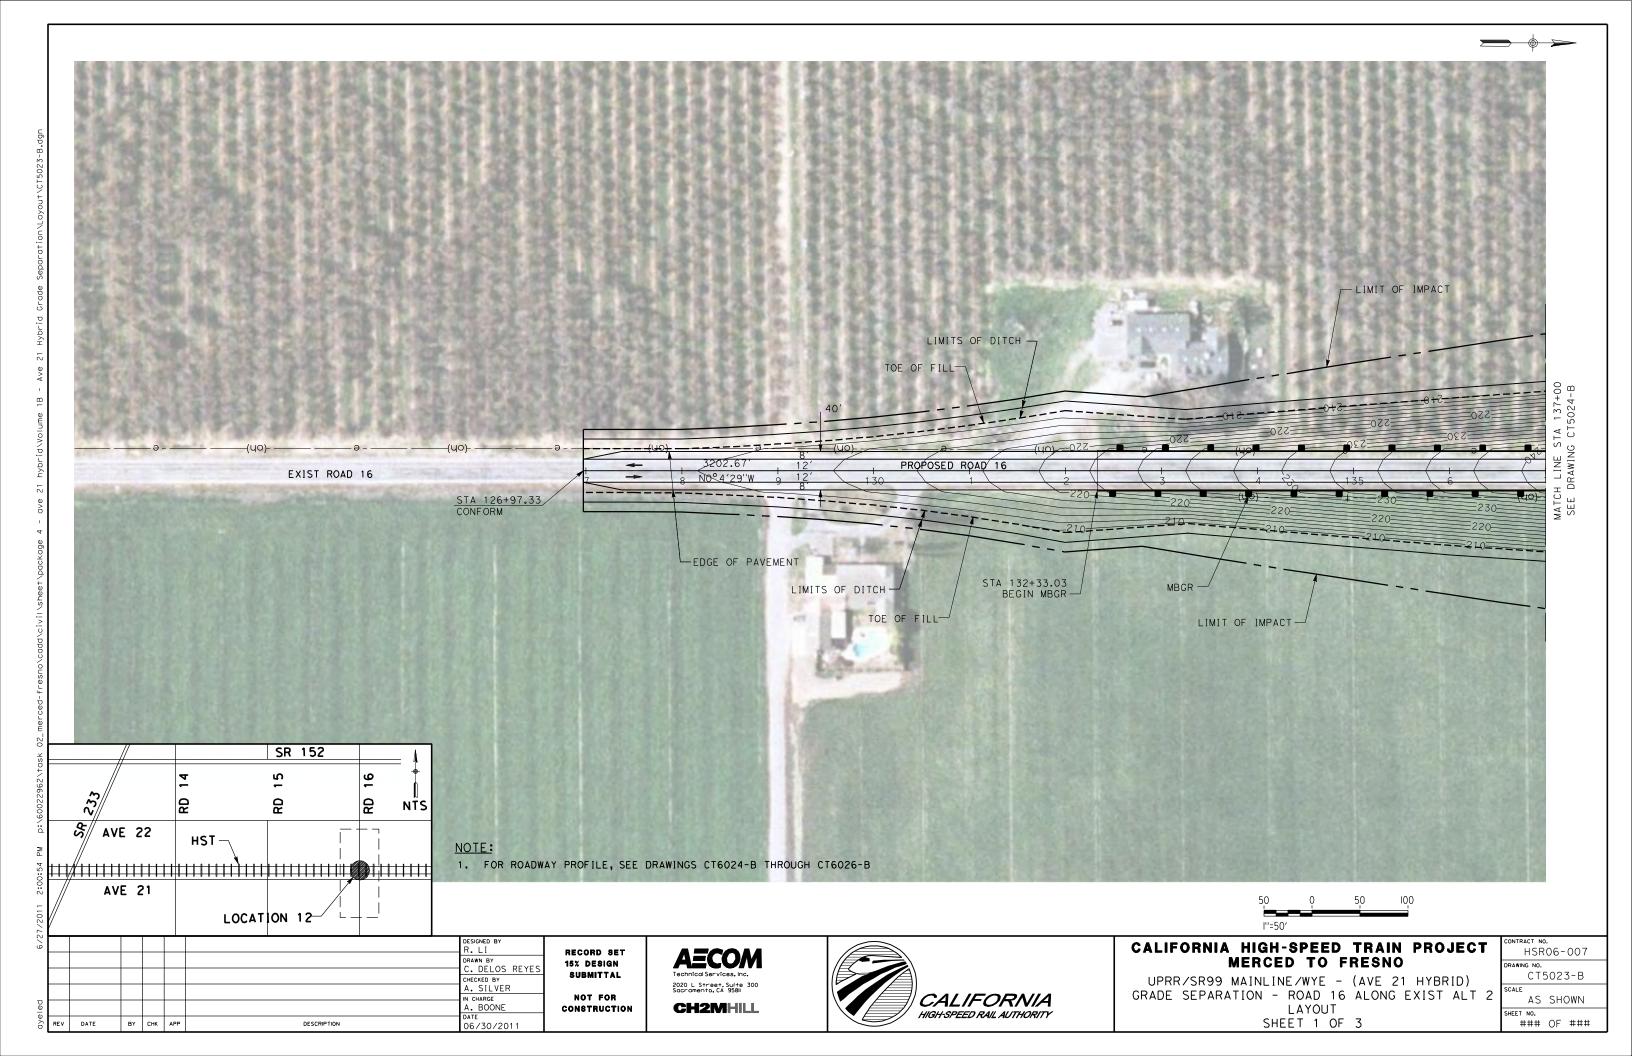

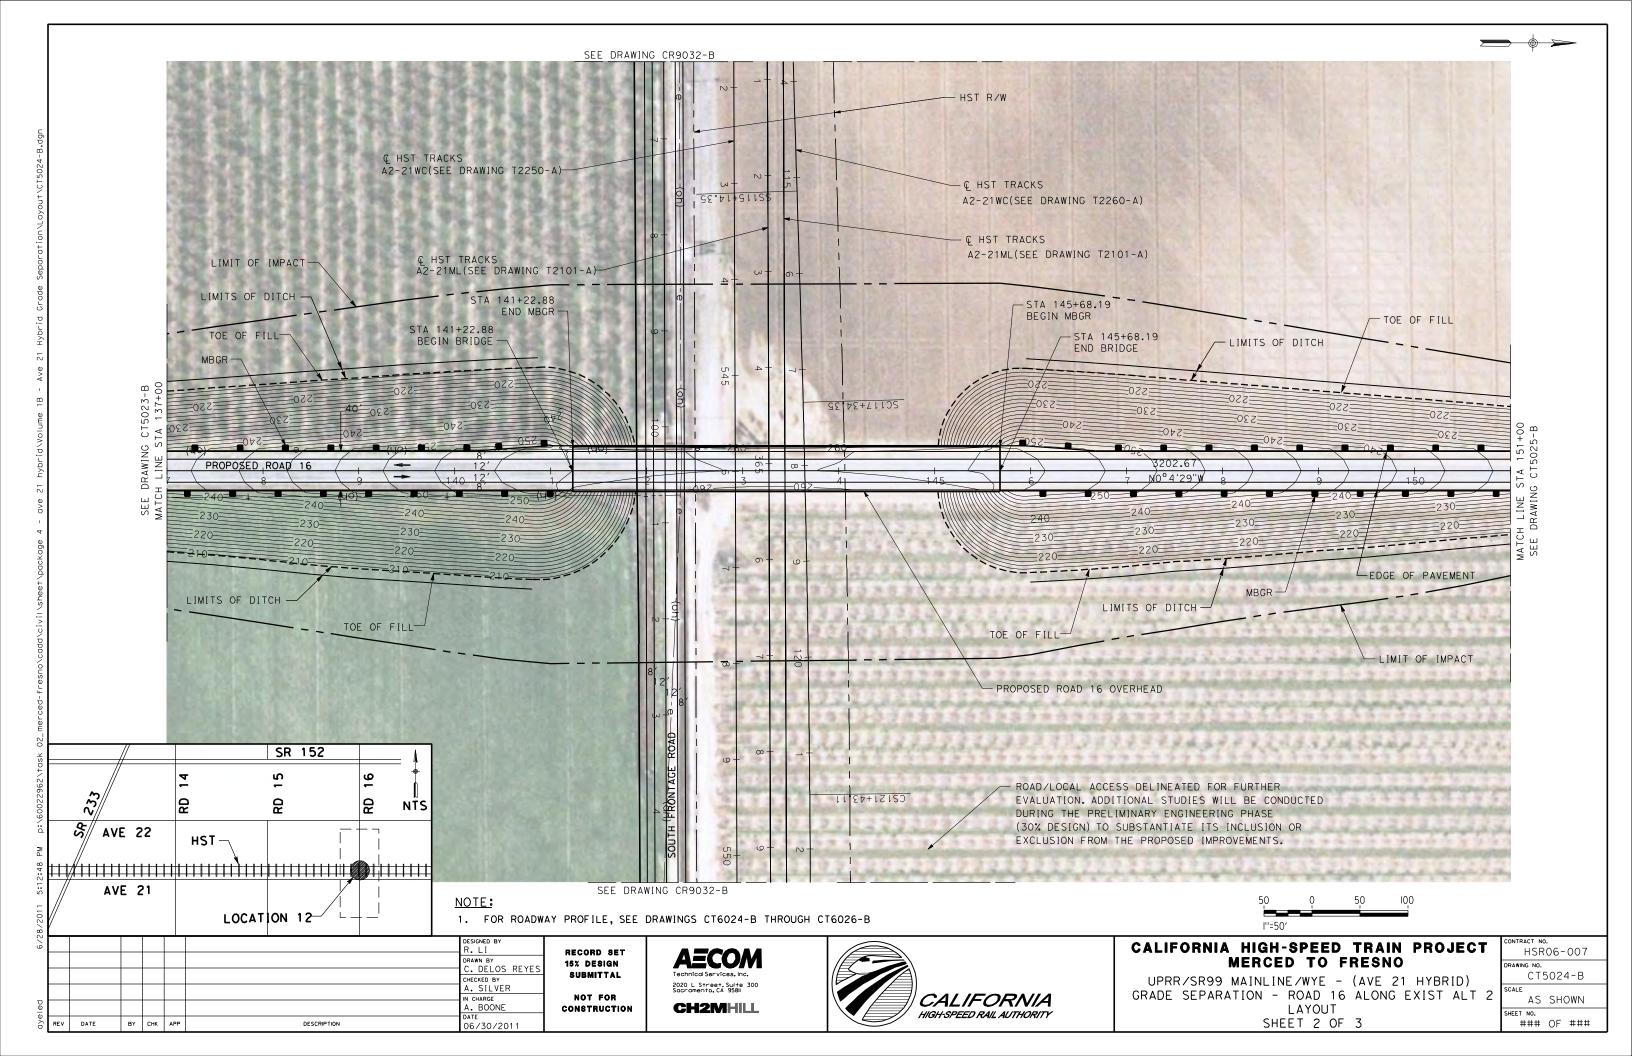

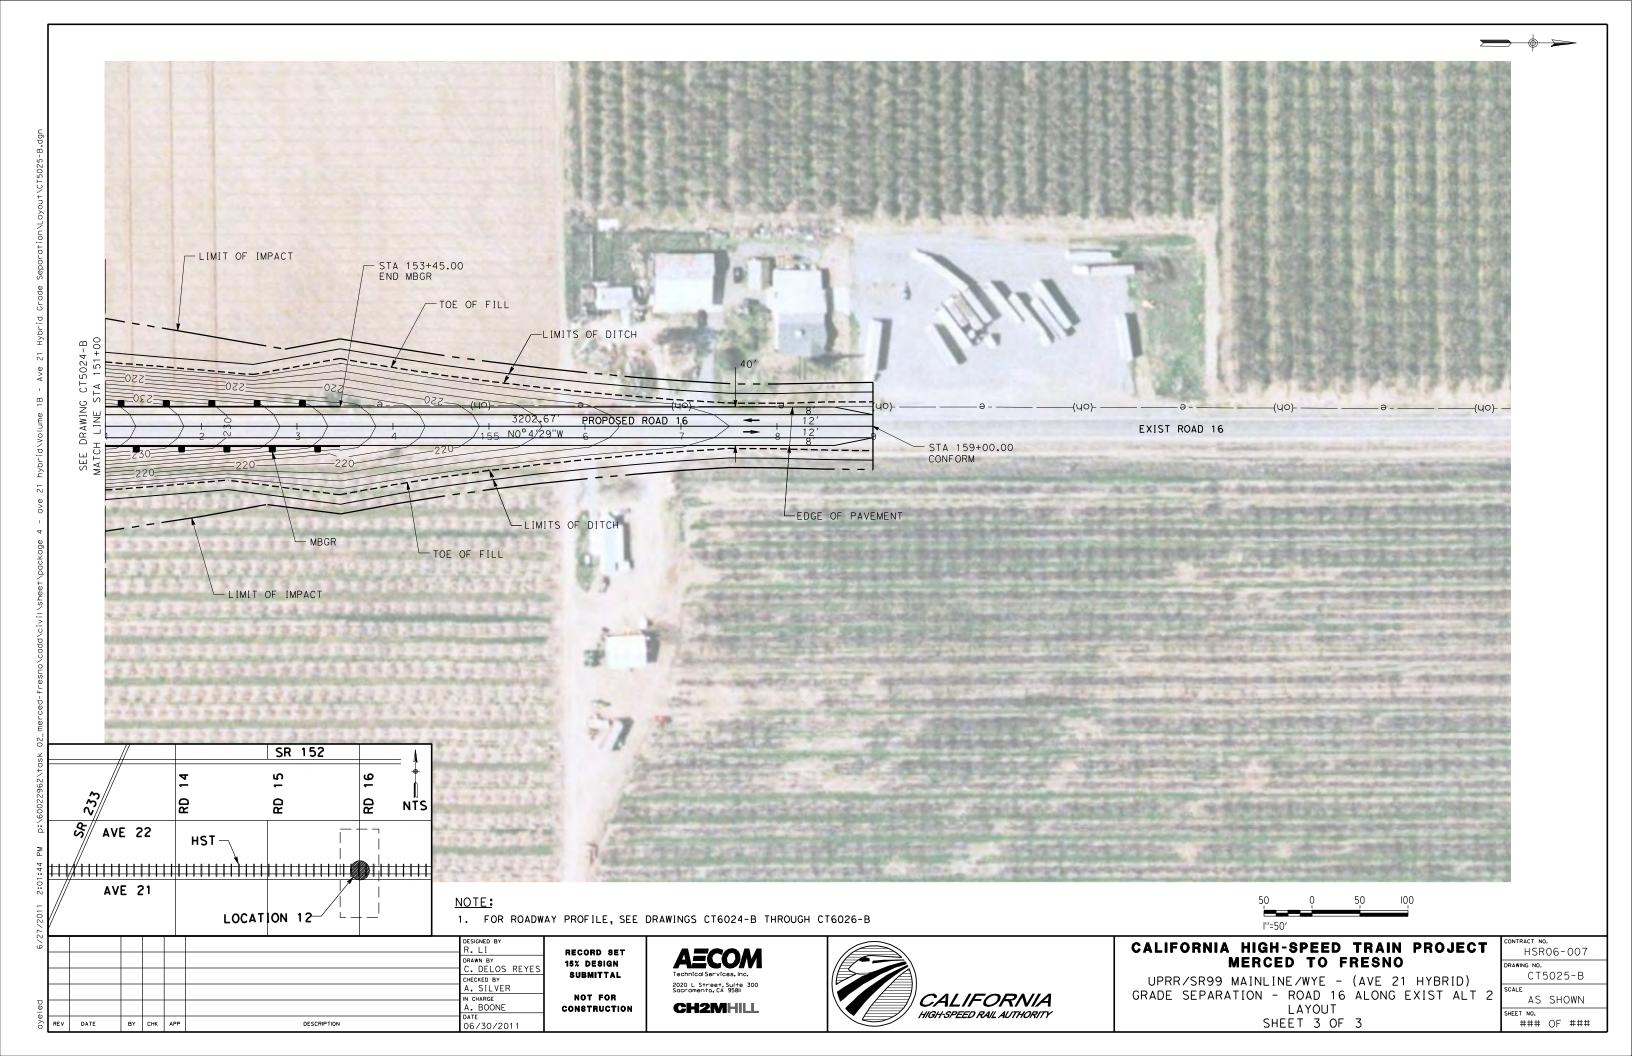

6% 4% 4% 1001 50′ Lt ETW & Lt Shid +2% RT ETW & RT Shid +2% 2% 2% 3000′ to 5000′ R, Rt 3000' to 5000' R, Lt AXIS OF ROTATION - CONTROL LINE 0% 0% L+ ETW -2% A L+ & R+ ETW -2% R+ ETW -2% <u>-2%</u> -2% <u>-4%</u> t Shid Rt Shid -5% <u>-6%</u> -6% SUPERELEVATION TEMPLATE DESIGNED BY CALIFORNIA HIGH-SPEED TRAIN PROJECT HSR06-007 RECORD SET AECOM DRAWN BY A. TRINH MERCED TO FRESNO 15% DESIGN SUBMITTAL CT5700-B CHECKED BY
A. SILVER UPRR/SR99 - (AVE 21 HYBRID) 2020 L Street, Suite 300 Sacramento, CA 95811 GRADE SEPARATION IN CHARGE
A. BOONE
DATE
06/30/2011 NOT FOR

CH2MHILL

CONSTRUCTION

REV DATE

BY CHK APP

DESCRIPTION

CALIFORNIA

HIGH-SPEED RAIL AUTHORITY

AS SHOWN

OF

SUPERELEVATION TEMPLATE

SHEET 1 OF 4

6% 4% 4% BEGIN 50′ 100′ 150′ Rt ETW & Rt Shid +2% 2% 2% 3000 to 5000 R, Lt MATCH LINE DRAWING CT57 AXIS OF ROTATION - CONTROL LINE 0% 0% L+ ETW +2% L+ & R+ ETW & \$hid -2% -2% <u>-2%</u> <u>-4%</u> Lt Shid -5% <u>-6%</u> -6% SUPERELEVATION TEMPLATE DESIGNED BY CALIFORNIA HIGH-SPEED TRAIN PROJECT AECOM HSR06-007 RECORD SET DRAWN BY
A. TRINH
CHECKED BY
A. SILVER MERCED TO FRESNO 15% DESIGN SUBMITTAL CT5701-B UPRR/SR99 - (AVE 21 HYBRID) 2020 L Street, Suite 300 Sacramento, CA 95811 GRADE SEPARATION

CALIFORNIA

HIGH-SPEED RAIL AUTHORITY

AS SHOWN

OF

SUPERELEVATION TEMPLATE

SHEET 2 OF 4

IN CHARGE
A. BOONE
DATE
06/30/2011

REV DATE

BY CHK APP

DESCRIPTION

NOT FOR

CONSTRUCTION

CH2MHILL

6% 4% 4% 1001 50´ R+ ETW & R+ Shid +2% L+ ETW & L+ Shid +2% 2% 2% 3000 to 5000 R, Lt 3000' + 5000' R, R+ AXIS OF ROTATION - CONTROL LINE 0% 0% MATCH DRAWING L+ ETW -2% R+ ETW -2% -2% <u>-2%</u> <u>-4%</u> -4% Lt Shid -5% Rt Shid -5% 100' <u>-6%</u> -6% SUPERELEVATION TEMPLATE DESIGNED BY CALIFORNIA HIGH-SPEED TRAIN PROJECT HSR06-007 RECORD SET AECOM DRAWN BY
A. TRINH
CHECKED BY
A. SILVER MERCED TO FRESNO 15% DESIGN SUBMITTAL CT5702-B UPRR/SR99 - (AVE 21 HYBRID) 2020 L Street, Suite 300 Sacramento, CA 95811 GRADE SEPARATION

CALIFORNIA

HIGH-SPEED RAIL AUTHORITY

AS SHOWN

OF

SUPERELEVATION TEMPLATE

SHEET 3 OF 4

IN CHARGE
A. BOONE
DATE
06/30/2011

REV DATE

BY CHK APP

DESCRIPTION

NOT FOR

CONSTRUCTION

CH2MHILL

6% 4% 4% 50′ 150′ 100 L+ ETW & L+ ShId +2% 2% 2% 3000′ to \$000′ R, Rt AXIS OF ROTATION - CONTROL LINE 0% 0% MATCH L DRAWING R+ ETW -2% L+ & R+ ETW -2% -2% <u>-2%</u> <u>-4%</u> Rt Shid -5% <u>-6%</u> -6% SUPERELEVATION TEMPLATE DESIGNED BY CALIFORNIA HIGH-SPEED TRAIN PROJECT HSR06-007 RECORD SET AECOM DRAWN BY
A. TRINH
CHECKED BY
A. SILVER MERCED TO FRESNO 15% DESIGN SUBMITTAL CT5703-B UPRR/SR99 - (AVE 21 HYBRID) 2020 L Street, Suite 300 Sacramento, CA 95811 GRADE SEPARATION

CALIFORNIA

HIGH-SPEED RAIL AUTHORITY

AS SHOWN

OF

SUPERELEVATION TEMPLATE

SHEET 4 OF 4

IN CHARGE
A. BOONE
DATE
06/30/2011

REV DATE

BY CHK APP

DESCRIPTION

NOT FOR

CONSTRUCTION

CH2MHILL

350 350 345 345 340 340 335 335 330 330 325 325 320 320 315 310 310 305 + PG STA 22+25 300 295 SEE DRAWING 400′ VC SSD 489′ 290 290 285 280 280 PROFILE 275 SCALE HORIZ: 1"=50' VERT: 1"=5' 270 15 NOT FOR CONSTRUCTION FOR INTERNAL USE ONLY DESIGNED BY R. GIBSON CALIFORNIA HIGH-SPEED TRAIN PROJECT HSR06-007 RECORD SET DRAWN BY F. DEMARCO MERCED TO FRESNO 15% DESIGN BNSF MAIN LINE - (AVE 21 HYBRID) GRADE SEPARATION - AVENUE 9 PROFILE SHEET 1 OF 3 SUBMITTAL CT1000-A CHECKED BY
J. ZANDIAN NOT FOR CALIFORNIA AS SHOWN N CHARGE A. BOONE **CH2MHILL** CONSTRUCTION HIGH-SPEED RAIL AUTHORITY DATE 06/30/2011

BY CHK APP

DESCRIPTION

365 360 360 355 355 350 350 345 345 340 340 335 335 330 330 325 325 320 320 315 315 310 310 305 305 300 300 400' VC SSD 476' 295 295 OG 290 -0.26% PROFILE 285 +44.30 Elev 29 SCALE HORIZ: 1"=50' VERT: 1"=5' 280 40 NOT FOR CONSTRUCTION FOR INTERNAL USE ONLY DESIGNED BY R. GIBSON CALIFORNIA HIGH-SPEED TRAIN PROJECT HSR06-007 RECORD SET DRAWN BY F. DEMARCO MERCED TO FRESNO 15% DESIGN BNSF MAIN LINE - (AVE 21 HYBRID) GRADE SEPARATION - AVENUE 9 PROFILE SHEET 3 OF 3 SUBMITTAL CT1002-A CHECKED BY
J. ZANDIAN NOT FOR CALIFORNIA AS SHOWN N CHARGE A. BOONE **CH2MHILL** CONSTRUCTION

DATE 06/30/2011

DESCRIPTION

BY CHK APP

HIGH-SPEED RAIL AUTHORITY

350 345 345 340 340 335 335 330 330 325 320 320 315 315 310 310 305 300 +28.95 EVC Elev 288.84 — PG 295 290 400′ VC SSD 502′ 285 280 280 275 275 PROFILE SCALE HORIZ: 1"=50' VERT: 1"=5' 270 270 265 NOT FOR CONSTRUCTION FOR INTERNAL USE ONLY DESIGNED BY R. GIBSON CALIFORNIA HIGH-SPEED TRAIN PROJECT HSR06-007 RECORD SET DRAWN BY F. DEMARCO MERCED TO FRESNO 15% DESIGN SUBMITTAL CT1003-A BNSF MAIN LINE - (AVE 21 HYBRID)
GRADE SEPARATION - AVENUE 10 CHECKED BY
J. ZANDIAN NOT FOR CALIFORNIA AS SHOWN N CHARGE A. BOONE PROFILE SHEET 1 OF 3 **CH2MHILL** CONSTRUCTION HEET NO. ### OF ### HIGH-SPEED RAIL AUTHORITY DATE 06/30/2011

DATE

BY CHK APP

350 345 345 340 340 335 330 330 325 320 320 315 315 800′ VC SSD 365′ DS 45MPH 310 310 300 ⊢ MATCH C62 SEE DRAWING 290 290 285 - OG -HST TOR = 289.97 280 280 275 PROFILE SCALE HORIZ: 1"=50' VERT: 1"=5' 270 265 30 35 NOT FOR CONSTRUCTION FOR INTERNAL USE ONLY DESIGNED BY R. GIBSON CALIFORNIA HIGH-SPEED TRAIN PROJECT HSR06-007 RECORD SET DRAWN BY F. DEMARCO MERCED TO FRESNO 15% DESIGN SUBMITTAL CT1004-A BNSF MAIN LINE - (AVE 21 HYBRID) GRADE SEPARATION - AVENUE 10 CHECKED BY
J. ZANDIAN 2020 L Street, Suite 300 Sacramento, CA 95811 NOT FOR CALIFORNIA AS SHOWN N CHARGE A. BOONE PROFILE **CH2MHILL** CONSTRUCTION HIGH-SPEED RAIL AUTHORITY DATE 06/30/2011 SHEET 2 OF 3 ### OF ### DATE BY CHK APP DESCRIPTION

350 345 345 340 340 335 335 330 330 325 320 320 315 315 310 310 305 305 300 300 295 295 290 290 400' VC SSD 512' 285 280 280 -0.49% 275 PROFILE SCALE HORIZ: 1"=50' VERT: 1"=5' 270 270 265 NOT FOR CONSTRUCTION FOR INTERNAL USE ONLY DESIGNED BY R. GIBSON CALIFORNIA HIGH-SPEED TRAIN PROJECT HSR06-007 RECORD SET DRAWN BY F. DEMARCO MERCED TO FRESNO 15% DESIGN SUBMITTAL CT1005-A CHECKED BY
J. ZANDIAN BNSF MAIN LINE - (AVE 21 HYBRID) GRADE SEPARATION - AVENUE 10 NOT FOR CALIFORNIA AS SHOWN N CHARGE A. BOONE PROFILE **CH2MHILL** CONSTRUCTION

DATE 06/30/2011

DATE

BY CHK APP

DESCRIPTION

HIGH-SPEED RAIL AUTHORITY

SHEET 3 OF 3

345 340 340 335 335 330 330 325 325 320 320 315 315 310 310 305 305 300 300 295 290 290 +13.10 Elev 279.12 400′ VC SSD 497′ CH LINE STA 25+25 DRAWING CT1007-A 285 285 280 0.40% 280 275 270 270 <u> 265</u> 265 PROFILE SCALE HORIZ: 1"=50' VERT: 1"=5' 25 NOT FOR CONSTRUCTION FOR INTERNAL USE ONLY DESIGNED BY R. GIBSON CALIFORNIA HIGH-SPEED TRAIN PROJECT RECORD SET 15% DESIGN HSR06-007 DRAWN BY F. DEMARCO MERCED TO FRESNO CT1006-A SUBMITTAL BNSF MAIN LINE - (AVE 21 HYBRID)
GRADE SEPARATION - AVENUE 11 CHECKED BY
J. ZANDIAN 2020 L Street, Suite 300 Sacramento, CA 9581 CALIFORNIA HIGH-SPEED RAIL AUTHORITY NOT FOR AS SHOWN N CHARGE A. BOONE PROFILE SHEET 1 OF 3 **CH2MHILL** CONSTRUCTION ### OF ###

DATE 06/30/2011

DATE

BY CHK APP

355 350 350 345 345 340 340 335 335 330 330 325 325 320 320 315 310 310 800' VC SSD 365' DS 45MPH 305 305 300 290 岁 - OG 280 280 +HST_TOR _=_287,89 --275 PROFILE SCALE_HORIZ: 1"=50" VERT: 1"=5" NOT FOR CONSTRUCTION FOR INTERNAL USE ONLY DESIGNED BY R. GIBSON CALIFORNIA HIGH-SPEED TRAIN PROJECT HSR06-007 RECORD SET DRAWN BY F. DEMARCO MERCED TO FRESNO 15% DESIGN CT1007-A SUBMITTAL BNSF MAIN LINE - (AVE 21 HYBRID)
GRADE SEPARATION - AVENUE 11 CHECKED BY
J. ZANDIAN 2020 L Street, Suite 300 Sacramento, CA 95811 CALIFORNIA HIGH-SPEED RAIL AUTHORITY NOT FOR AS SHOWN N CHARGE A. BOONE PROFILE SHEET 2 OF 3 **CH2MHILL** CONSTRUCTION HEET NO. ### OF ### DATE 06/30/2011

DATE

BY CHK APP

340 340 335 335 330 330 325 325 320 320 315 315 310 310 305 305 300 300 295 295 — PG 290 290 +64.73 EVC Elev 279.07 400′ VC SSD 412′ 285 285 - og 280 -0.34% 280 275 275 270 270 265 265 PROFILE SCALE_HORIZ: 1"=50' VERT: 1"=5' NOT FOR CONSTRUCTION FOR INTERNAL USE ONLY DESIGNED BY R. GIBSON CALIFORNIA HIGH-SPEED TRAIN PROJECT RECORD SET 15% DESIGN DRAWN BY F. DEMARCO MERCED TO FRESNO CT1008-A SUBMITTAL CHECKED BY
J. ZANDIAN NOT FOR CALIFORNIA

CH2MHILL

HIGH-SPEED RAIL AUTHORITY

N CHARGE A. BOONE

DESCRIPTION

DATE

BY CHK APP

DATE 06/30/2011

CONSTRUCTION

SHEET 3 OF 3

BNSF MAIN LINE - (AVE 21 HYBRID)
GRADE SEPARATION - AVENUE 11 **PROFILE**

HSR06-007 AS SHOWN ### OF ###

300 295 295 345 290 290 340 285 335 — PG 280 330 400' VC OG — 275 275 PROFILE SCALE HORIZ: 1"=50' VERT: 1"=5' 270 270 320 315 265 265 8 10 310 300 STA 24+2 CT1010-295 +64.52 Elev 281.94 +14.52 BVC Elev 281.19 500′ VC SSD 407′ 290 +20.49 BVC Elev 279.66 MAT(SEE 285 🖰 🖳 285 0.50% 280 🗒 🔻 300' VC SSD 815' 280 275 AM 275 **PROFILE** SCALE HORIZ: 1"=50' VERT: 1"=5' 270 270 265 15 NOT FOR CONSTRUCTION FOR INTERNAL USE ONLY DESIGNED BY R. GIBSON CALIFORNIA HIGH-SPEED TRAIN PROJECT HSR06-007 RECORD SET DRAWN BY F. DEMARCO MERCED TO FRESNO 15% DESIGN SUBMITTAL CT1009-A BNSF MAIN LINE - (AVE 21 HYBRID) GRADE SEPARATION - AVENUE 12 CHECKED BY
J. ZANDIAN 2020 L Street, Suite 300 Sacramento, CA 95811 NOT FOR CALIFORNIA AS SHOWN N CHARGE A. BOONE **CH2MHILL PROFILE** CONSTRUCTION HIGH-SPEED RAIL AUTHORITY DATE 06/30/2011 SHEET 1 OF 3 ### OF ###

DATE

BY CHK APP

350 345 345 340 340 335 335 330 330 325 320 320 315 315 PG_ 310 310 900′ VC SSD 365′ 305 305 300 74 24+25 T1009-A 290 N. W. SEE DRA 280 280 →HST TOR = 285.99 275 275 **PROFILE** SCALE HORIZ: 1"=50' VERT: 1"=5' 270 265 35 NOT FOR CONSTRUCTION FOR INTERNAL USE ONLY DESIGNED BY R. GIBSON CALIFORNIA HIGH-SPEED TRAIN PROJECT HSR06-007 RECORD SET DRAWN BY F. DEMARCO MERCED TO FRESNO 15% DESIGN CT1010-A SUBMITTAL BNSF MAIN LINE - (AVE 21 HYBRID) GRADE SEPARATION - AVENUE 12 CHECKED BY
J. ZANDIAN 2020 L Street, Suite 300 Sacramento, CA 95811 NOT FOR CALIFORNIA AS SHOWN N CHARGE A. BOONE **CH2MHILL PROFILE** CONSTRUCTION HIGH-SPEED RAIL AUTHORITY DATE 06/30/2011 SHEET 2 OF 3 ### OF ### DATE BY CHK APP DESCRIPTION

295 295 290 290 285 ₹ 285 280 二世 280 275 ₹ 275 PROFILE 270 SCALE HORIZ: 1"=50' VERT: 1"=5' 270 265 265 0.50% — og **PROFILE** SCALE HORIZ: 1"=50' VERT: 1"=5' 45 50 NOT FOR CONSTRUCTION FOR INTERNAL USE ONLY DESIGNED BY R. GIBSON CALIFORNIA HIGH-SPEED TRAIN PROJECT RECORD SET 15% DESIGN HSR06-007 DRAWN BY F. DEMARCO MERCED TO FRESNO CT1011-A SUBMITTAL BNSF MAIN LINE - (AVE 21 HYBRID) GRADE SEPARATION - AVENUE 12 CHECKED BY
J. ZANDIAN 2020 L Street, Suite 300 Sacramento, CA 95811 NOT FOR CALIFORNIA AS SHOWN N CHARGE A. BOONE **CH2MHILL PROFILE** CONSTRUCTION SHEET NO. ### OF ### HIGH-SPEED RAIL AUTHORITY DATE 06/30/2011

DATE

BY CHK APP

DESCRIPTION

SHEET 3 OF 3

350 345 345 340 340 335 335 330 330 325 320 320 315 315 310 305 MATCH LINE STA 23+25 SEE DRAWING CT1013-A 300 295 295 400' VC SSD 444' 290 — og 290 0.00% 285 280 280 275 PROFILE 270 SCALE HORIZ: 1"=50' VERT: 1"=5' NOT FOR CONSTRUCTION FOR INTERNAL USE ONLY DESIGNED BY R. GIBSON CALIFORNIA HIGH-SPEED TRAIN PROJECT HSR06-007 RECORD SET DRAWN BY F. DEMARCO MERCED TO FRESNO 15% DESIGN CT1012-A SUBMITTAL BNSF MAIN LINE - (AVE 21 HYBRID) GRADE SEPARATION - AVENUE 13 CHECKED BY
J. ZANDIAN NOT FOR CALIFORNIA AS SHOWN N CHARGE A. BOONE **CH2MHILL PROFILE** CONSTRUCTION ### OF ###

DATE 06/30/2011

DATE

BY CHK APP

DESCRIPTION

HIGH-SPEED RAIL AUTHORITY

SHEET 1 OF 3

360 355 355 350 350 345 345 340 340 335 330 330 325 325 320 320 800' VC SSD 465' DS 45MPH — PG 315 310 BNSF TCH LINE DRAWING -HST TOR = 289.77 à 295 V 290 290 74'45 285 **PROFILE** 280 280 SCALE HORIZ: 1"=50' VERT: 1"=5' NOT FOR CONSTRUCTION FOR INTERNAL USE ONLY DESIGNED BY R. GIBSON CALIFORNIA HIGH-SPEED TRAIN PROJECT HSR06-007 RECORD SET DRAWN BY F. DEMARCO MERCED TO FRESNO 15% DESIGN CT1013-A SUBMITTAL BNSF MAIN LINE - (AVE 21 HYBRID) GRADE SEPARATION - AVENUE 13 CHECKED BY
J. ZANDIAN NOT FOR CALIFORNIA AS SHOWN N CHARGE A. BOONE **CH2MHILL PROFILE** CONSTRUCTION HIGH-SPEED RAIL AUTHORITY DATE 06/30/2011 SHEET 2 OF 3

DATE

BY CHK APP

DESCRIPTION

345 345 340 340 335 335 330 330 325 320 320 315 315 310 310 305 305 300 300 +19.38 EVC Elev 286.29 400' VC SSD 568' 295 295 290 290 __ OG -0.76% 285 280 280 275 PROFILE 270 SCALE HORIZ: 1"=50' VERT: 1"=5' NOT FOR CONSTRUCTION FOR INTERNAL USE ONLY DESIGNED BY R. GIBSON CALIFORNIA HIGH-SPEED TRAIN PROJECT HSR06-007 RECORD SET DRAWN BY F. DEMARCO MERCED TO FRESNO 15% DESIGN CT1014-A SUBMITTAL BNSF MAIN LINE - (AVE 21 HYBRID) GRADE SEPARATION - AVENUE 13 CHECKED BY
J. ZANDIAN NOT FOR CALIFORNIA AS SHOWN N CHARGE A. BOONE **CH2MHILL PROFILE** CONSTRUCTION

DATE 06/30/2011

DATE

BY CHK APP

DESCRIPTION

HIGH-SPEED RAIL AUTHORITY

OF

SHEET 3 OF 3

360 355 355 350 350 345 345 340 340 335 330 330 325 320 320 315 310 305 300 300 — PG 400′ VC SSD 549′ 295 290 290 285 PROFILE 280 280 SCALE HORIZ: 1"=50' VERT: 1"=5' NOT FOR CONSTRUCTION FOR INTERNAL USE ONLY DESIGNED BY R. GIBSON CALIFORNIA HIGH-SPEED TRAIN PROJECT HSR06-007 RECORD SET DRAWN BY F. DEMARCO MERCED TO FRESNO 15% DESIGN CT1015-A SUBMITTAL BNSF MAIN LINE - (AVE 21 HYBRID) CHECKED BY
J. ZANDIAN GRADE SEPARATION - AVENUE 15
PROFILE
SHEET 1 OF 3 CALIFORNIA HIGH-SPEED RAIL AUTHORITY NOT FOR AS SHOWN N CHARGE A. BOONE **CH2MHILL** CONSTRUCTION ### OF ### DATE 06/30/2011 BY CHK APP DESCRIPTION

360 355 355 350 350 345 345 340 340 335 330 330 325 325 320 320 315 310 310 305 305 300 300 400′ VC SSD 563′ - OG 295 290 290 285 PROFILE 280 SCALE HORIZ: 1"=50' VERT: 1"=5' 40 45 50 NOT FOR CONSTRUCTION FOR INTERNAL USE ONLY DESIGNED BY R. GIBSON CALIFORNIA HIGH-SPEED TRAIN PROJECT HSR06-007 RECORD SET DRAWN BY F. DEMARCO MERCED TO FRESNO 15% DESIGN CT1017-A SUBMITTAL BNSF MAIN LINE - (AVE 21 HYBRID) CHECKED BY
J. ZANDIAN GRADE SEPARATION - AVENUE 15
PROFILE
SHEET 3 OF 3 NOT FOR CALIFORNIA AS SHOWN N CHARGE A. BOONE **CH2MHILL** CONSTRUCTION HIGH-SPEED RAIL AUTHORITY DATE 06/30/2011


BY CHK APP


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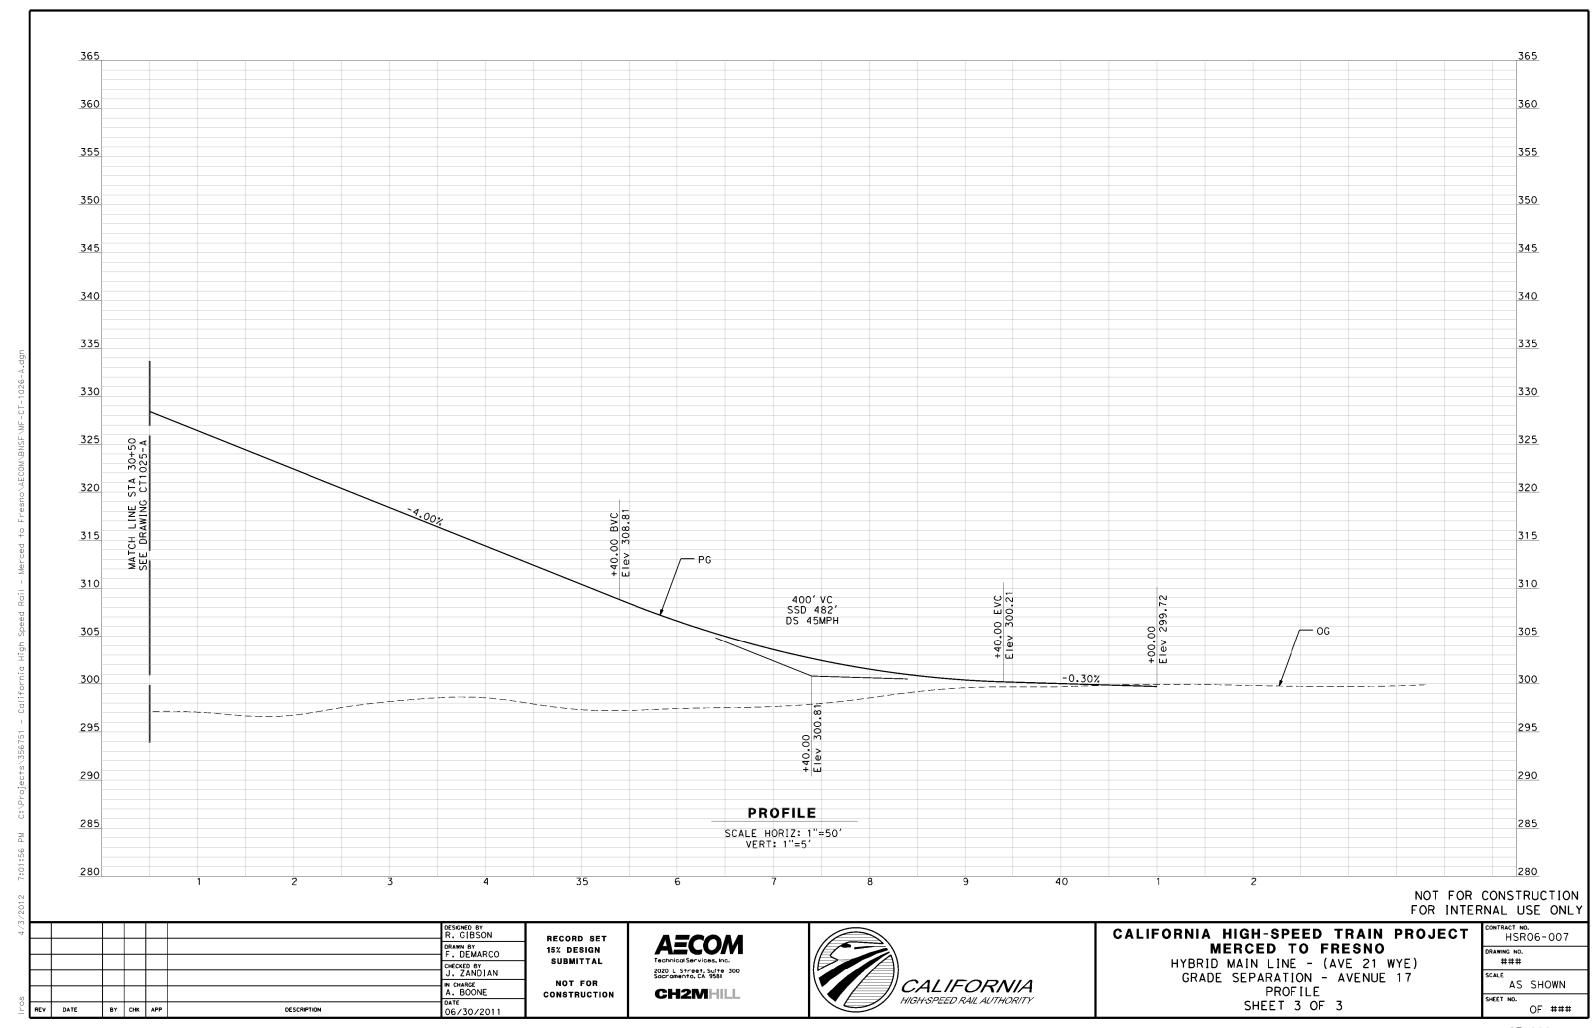
350 350 345 345 340 340 335 330 330 325 325 320 320 315 310 - PG MATCH LINE STA 17 SEE DRAWING CT101 305 300 400′ VC SSD 590 295 290 0.84% 285 280 280 PROFILE 275 SCALE HORIZ: 1"=50' VERT: 1"=5' 10 NOT FOR CONSTRUCTION FOR INTERNAL USE ONLY DESIGNED BY R. GIBSON CALIFORNIA HIGH-SPEED TRAIN PROJECT HSR06-007 RECORD SET DRAWN BY F. DEMARCO MERCED TO FRESNO 15% DESIGN SUBMITTAL CT1018-A BNSF MAIN LINE - (AVE 21 HYBRID) CHECKED BY
J. ZANDIAN GRADE SEPARATION - AVENUE 15 1/2 CALIFORNIA HIGH-SPEED RAIL AUTHORITY NOT FOR AS SHOWN N CHARGE A. BOONE PROFILE SHEET 1 OF 3 **CH2M**HILL CONSTRUCTION SHEET NO. ### DATE 06/30/2011


BY CHK APP


360 360 355 350 350 345 340 335 335 330 330 325 320 320 <u>2</u> 2 315 310 310 305 305 300 300 295 295 — og +12.54 Elev, 296.52 290 PROFILE 285 SCALE HORIZ: 1"=50' VERT: 1"=5' NOT FOR CONSTRUCTION FOR INTERNAL USE ONLY 35 DESIGNED BY R. GIBSON CALIFORNIA HIGH-SPEED TRAIN PROJECT HSR06-007 RECORD SET DRAWN BY F. DEMARCO MERCED TO FRESNO 15% DESIGN SUBMITTAL CT1020-A BNSF MAIN LINE - (AVE 21 HYBRID) CHECKED BY
J. ZANDIAN GRADE SEPARATION - AVENUE 15 1/2 CALIFORNIA NOT FOR AS SHOWN N CHARGE A. BOONE PROFILE SHEET 3 OF 3 **CH2MHILL** CONSTRUCTION SHEET NO. ### OF ### HIGH-SPEED RAIL AUTHORITY DATE 06/30/2011 BY CHK APP DESCRIPTION




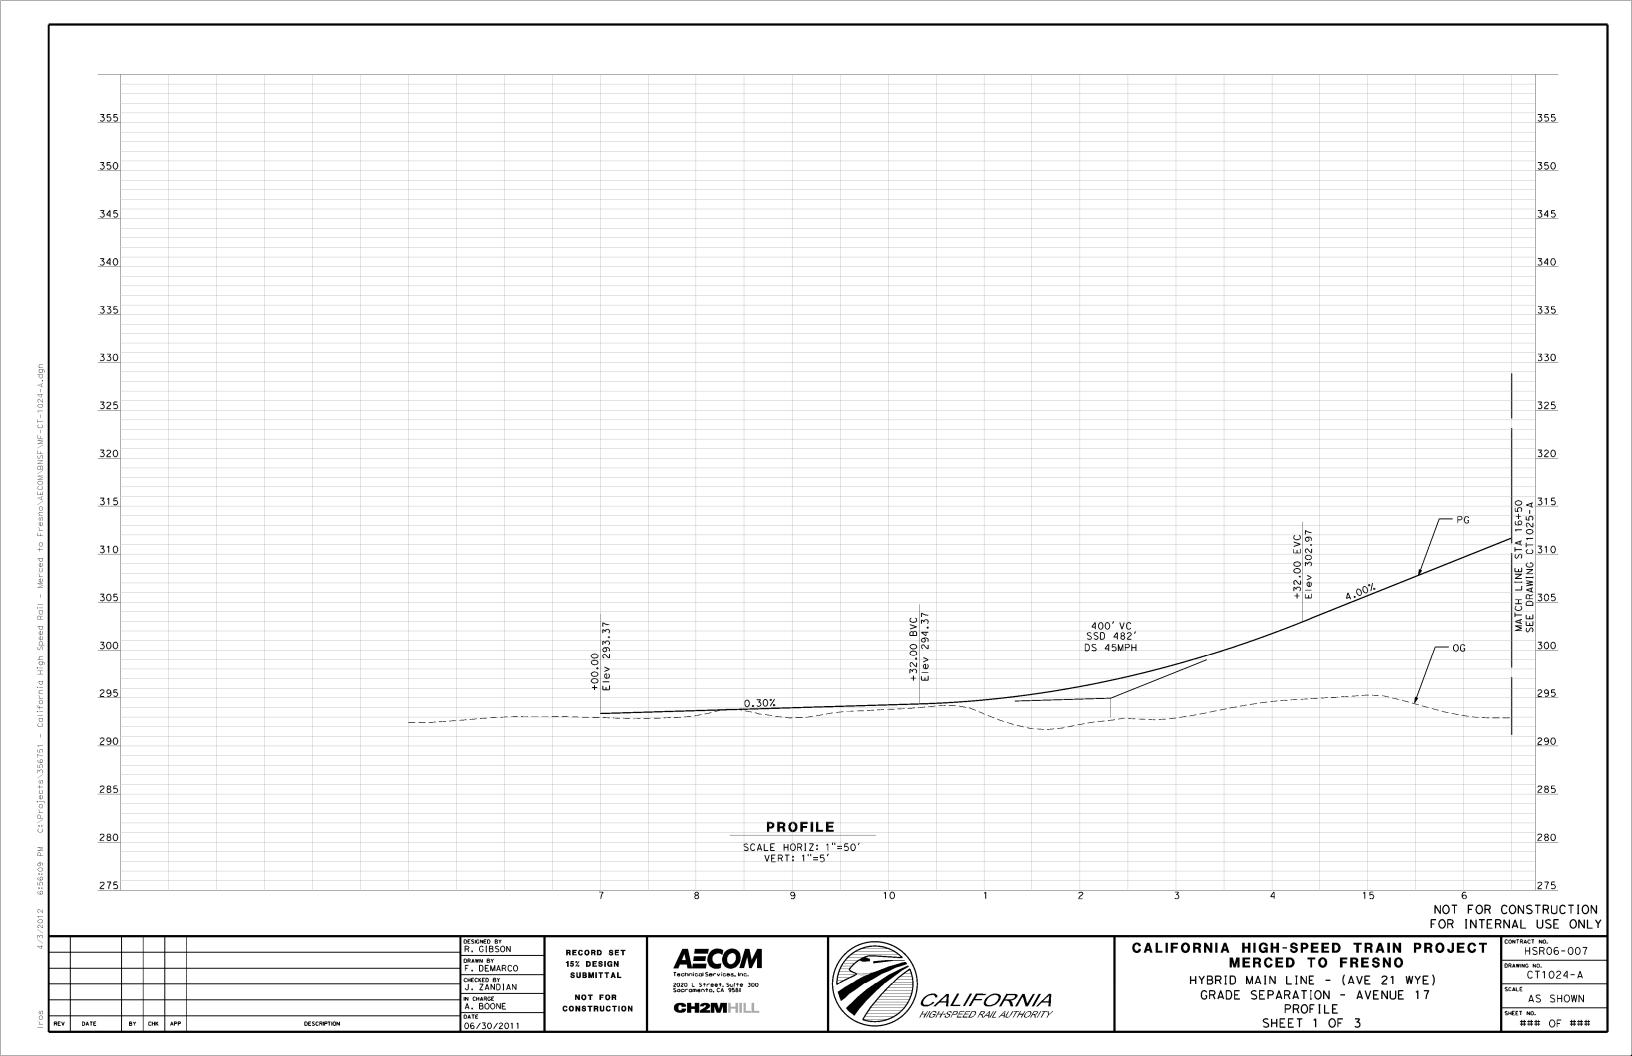


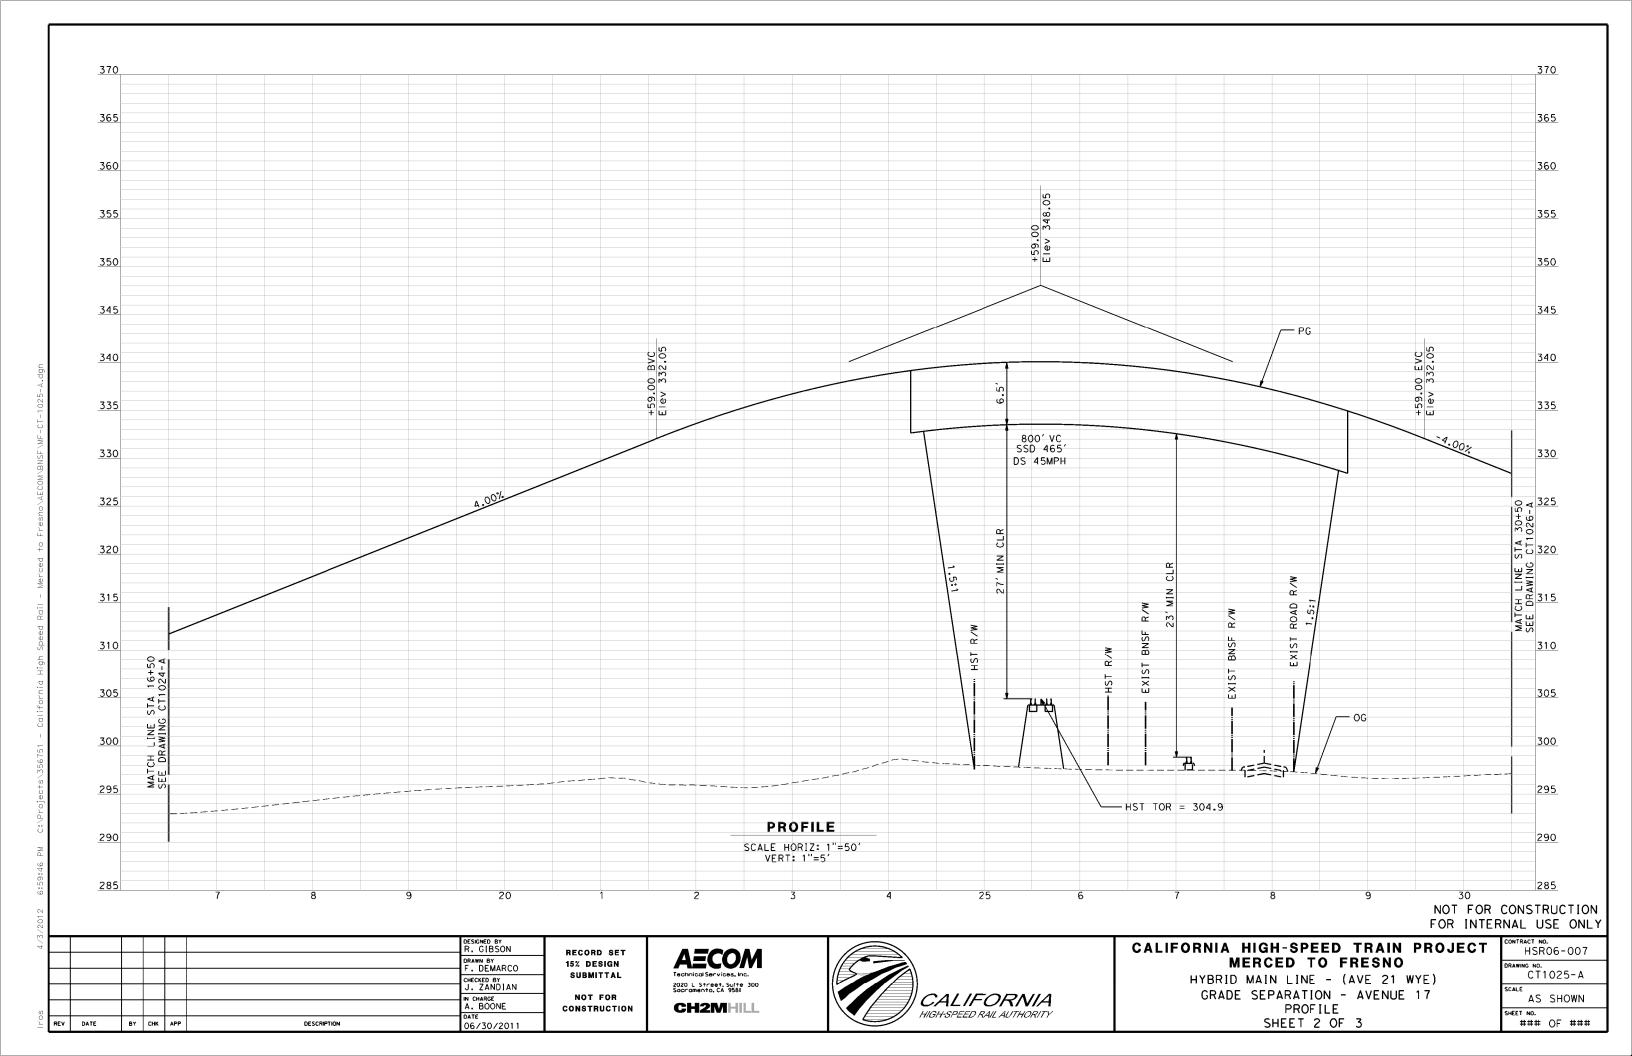


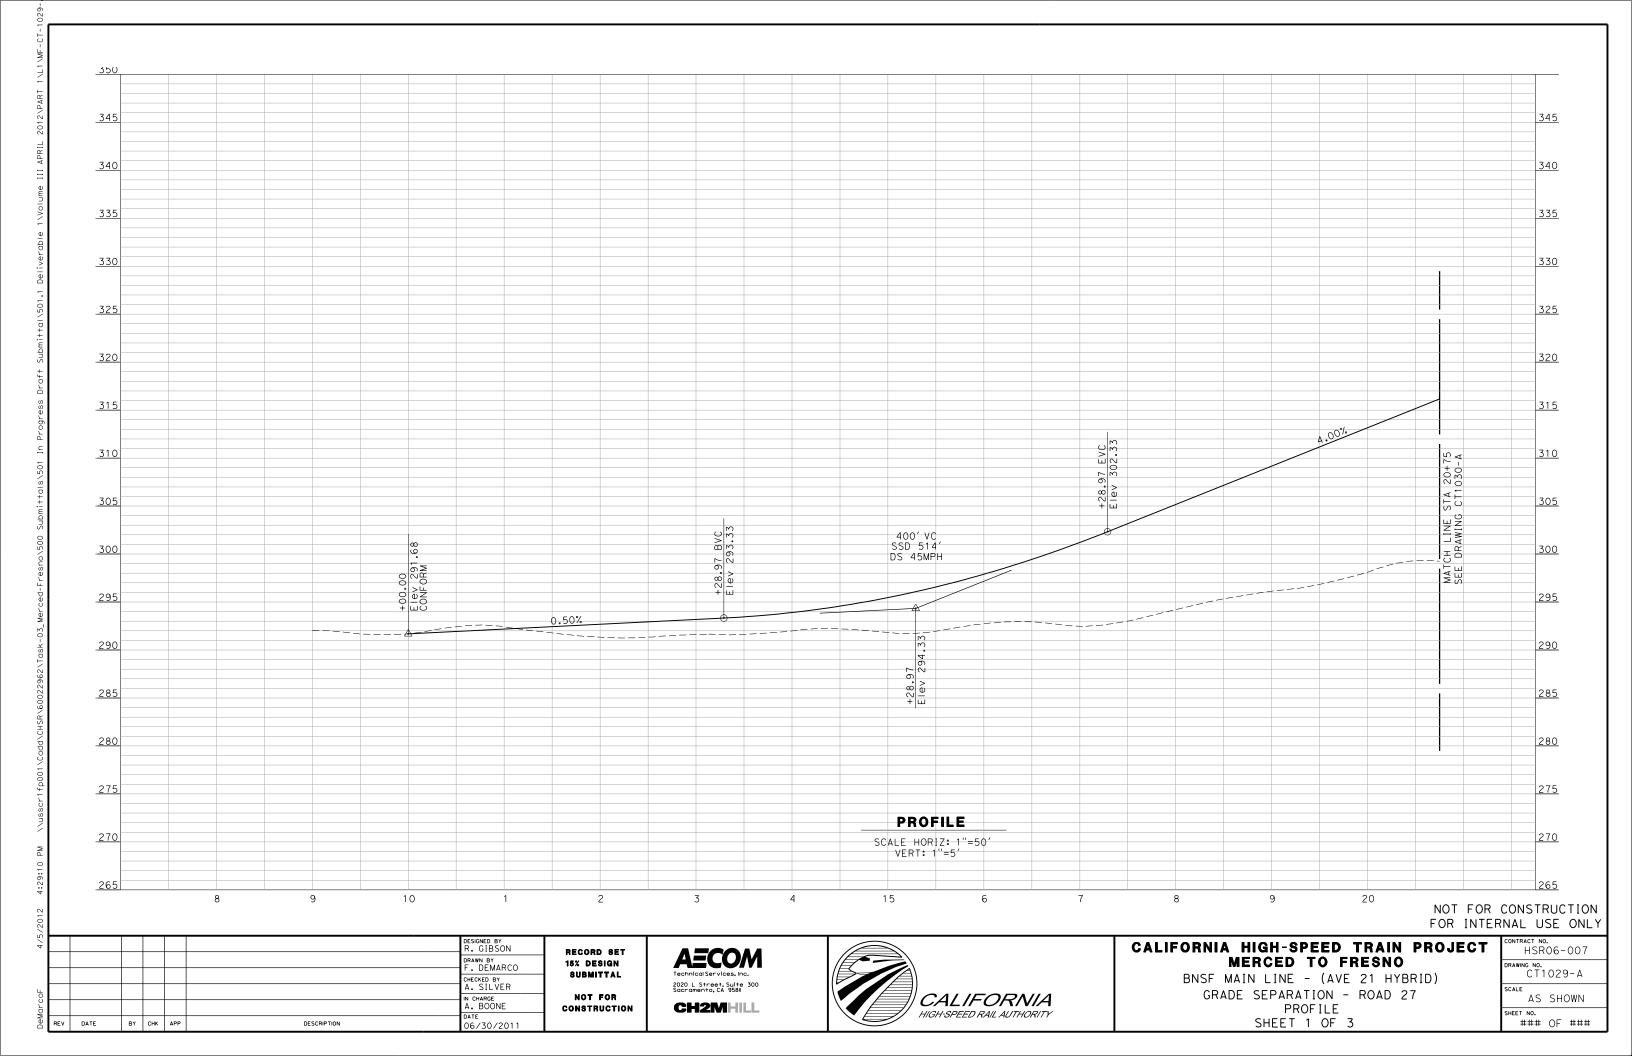


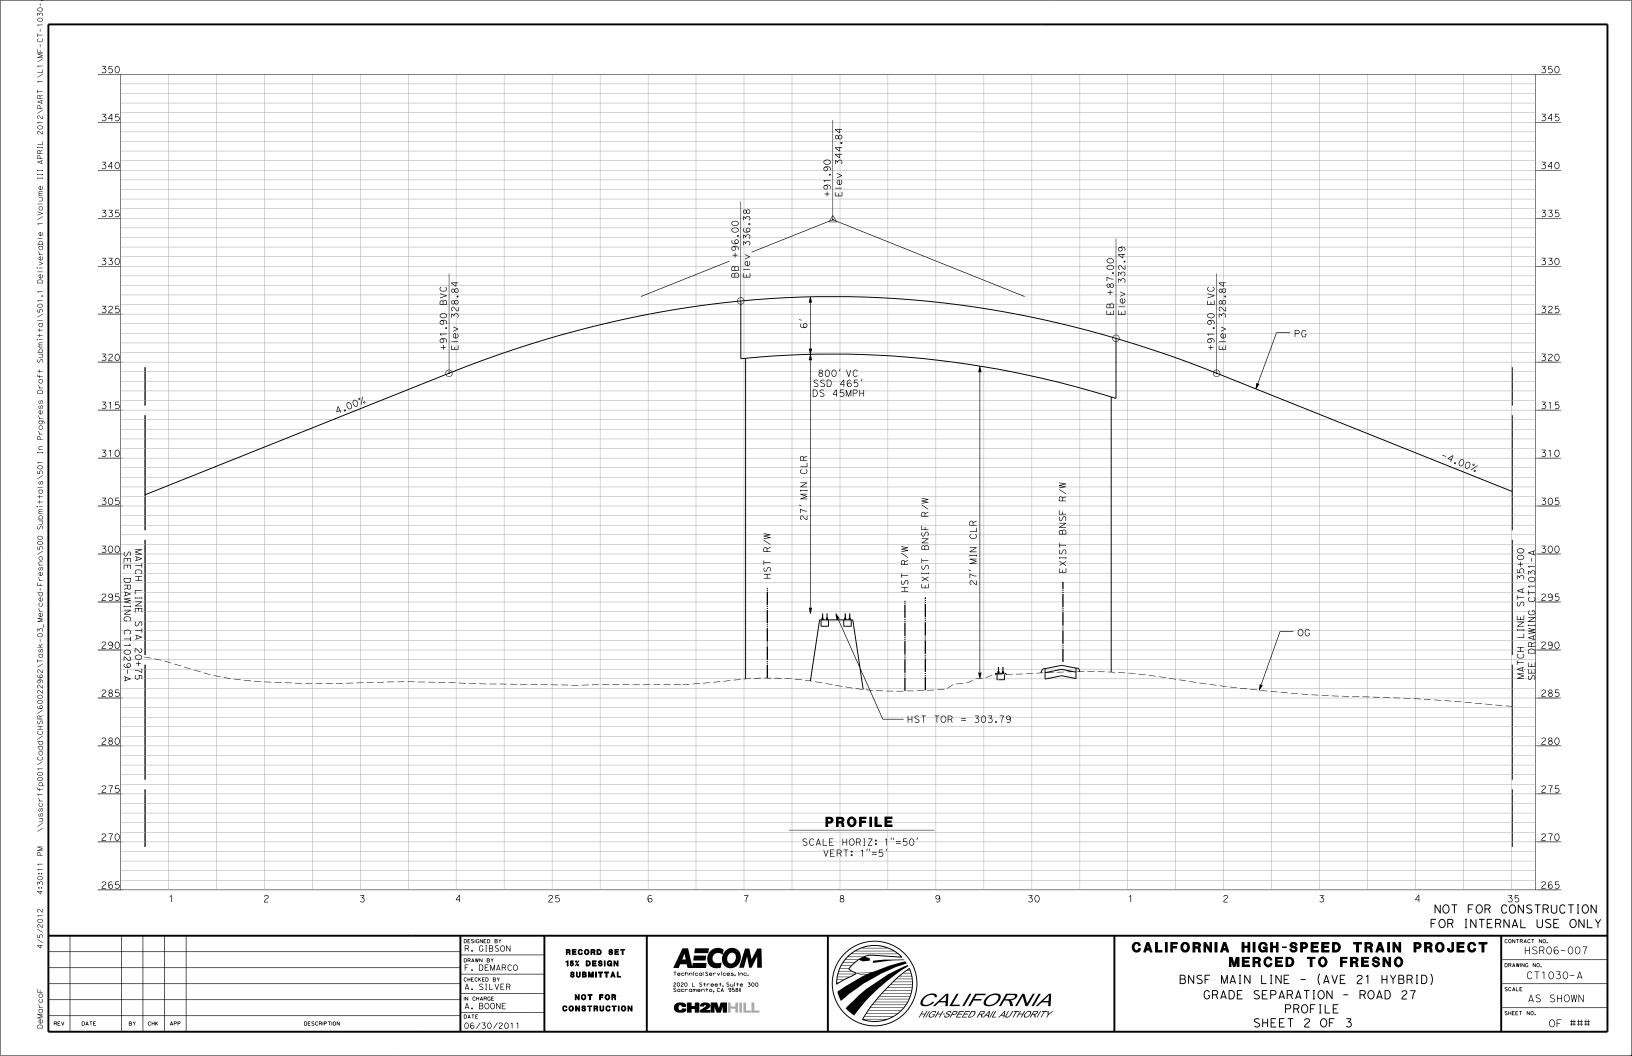


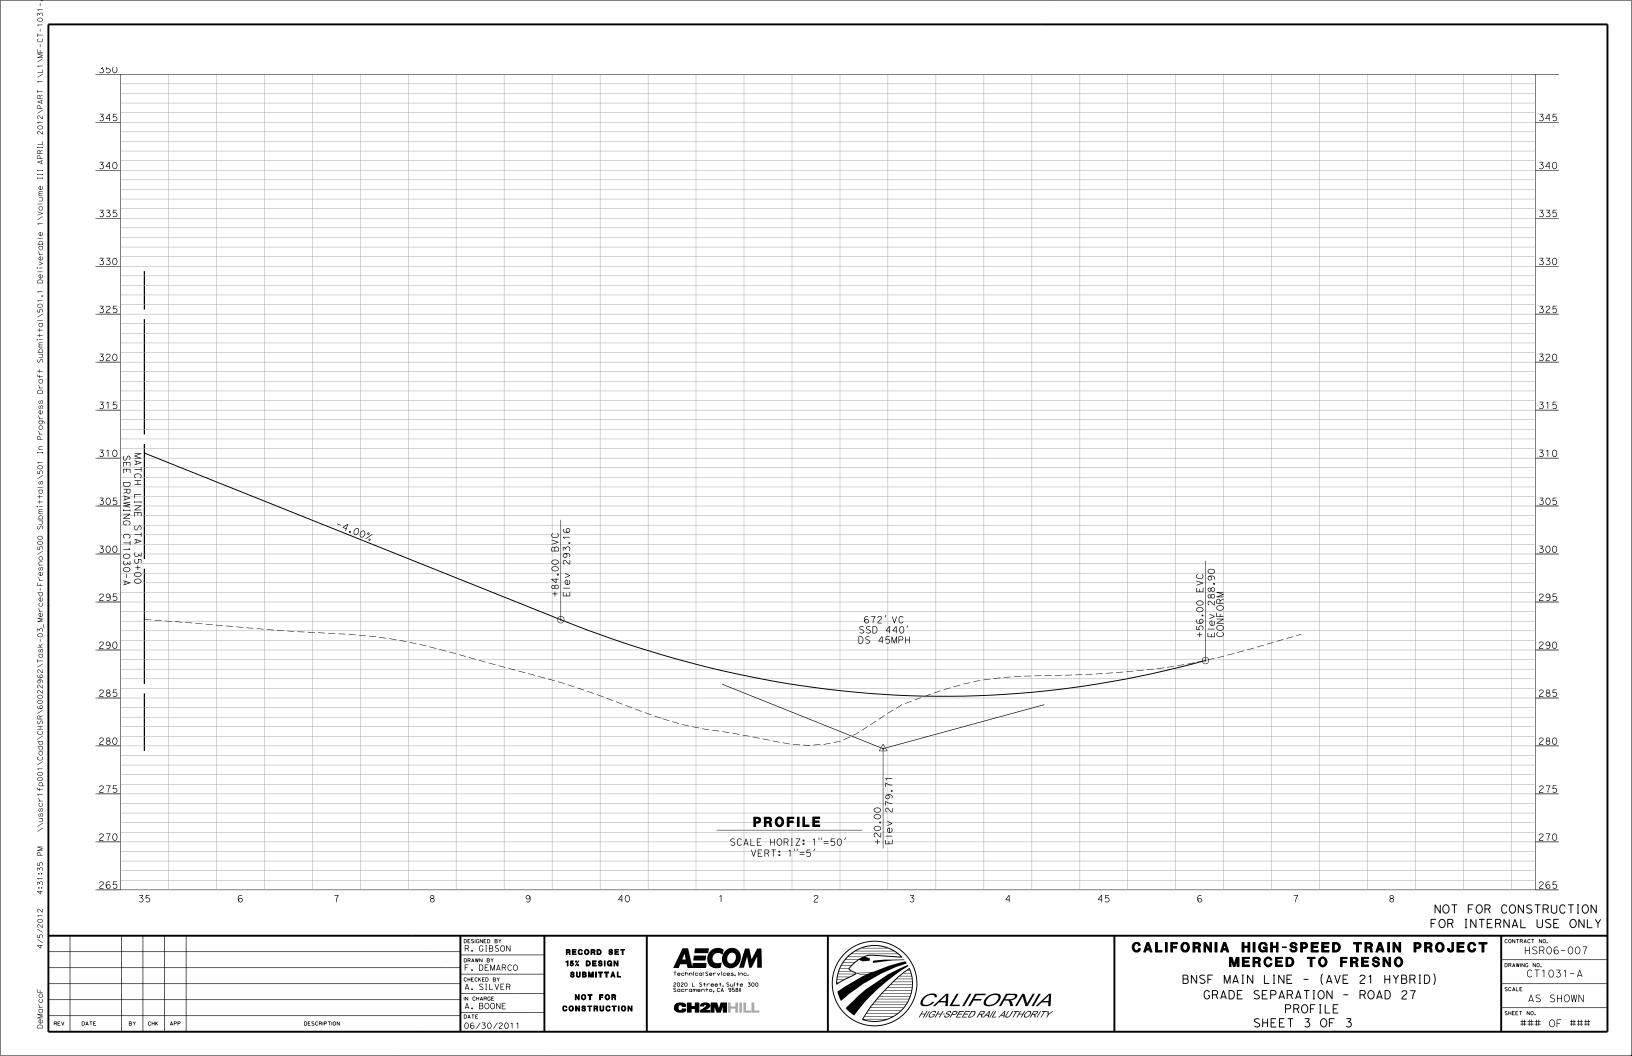


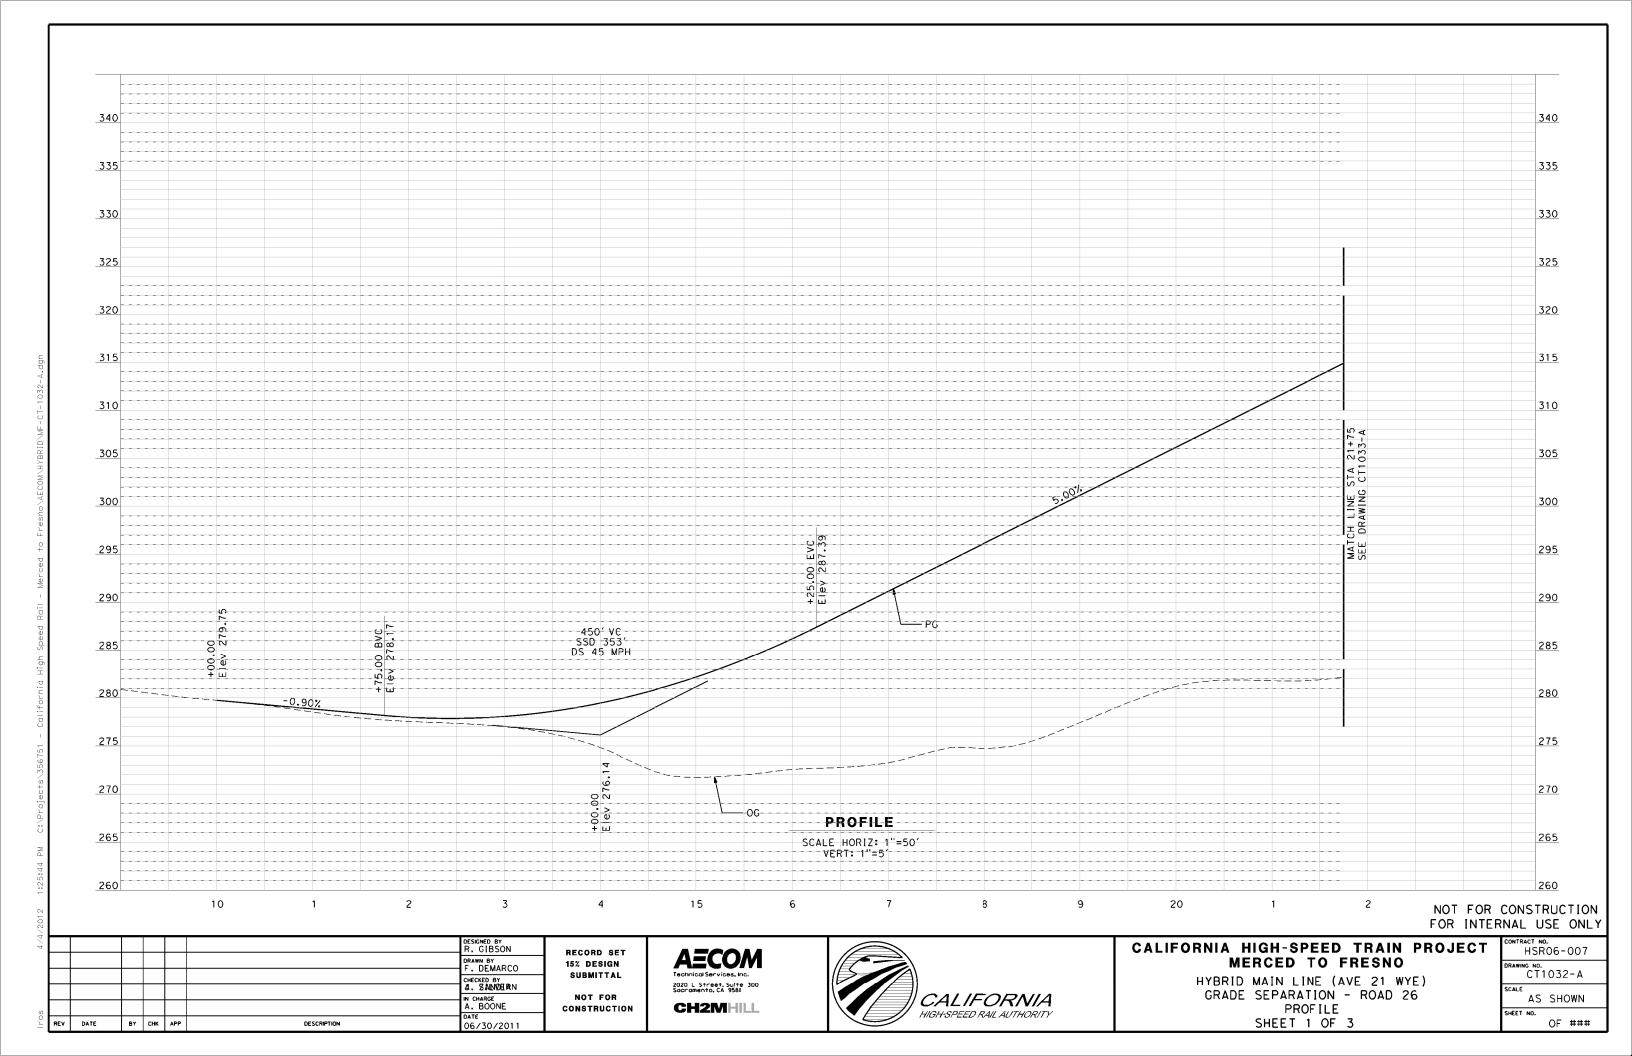


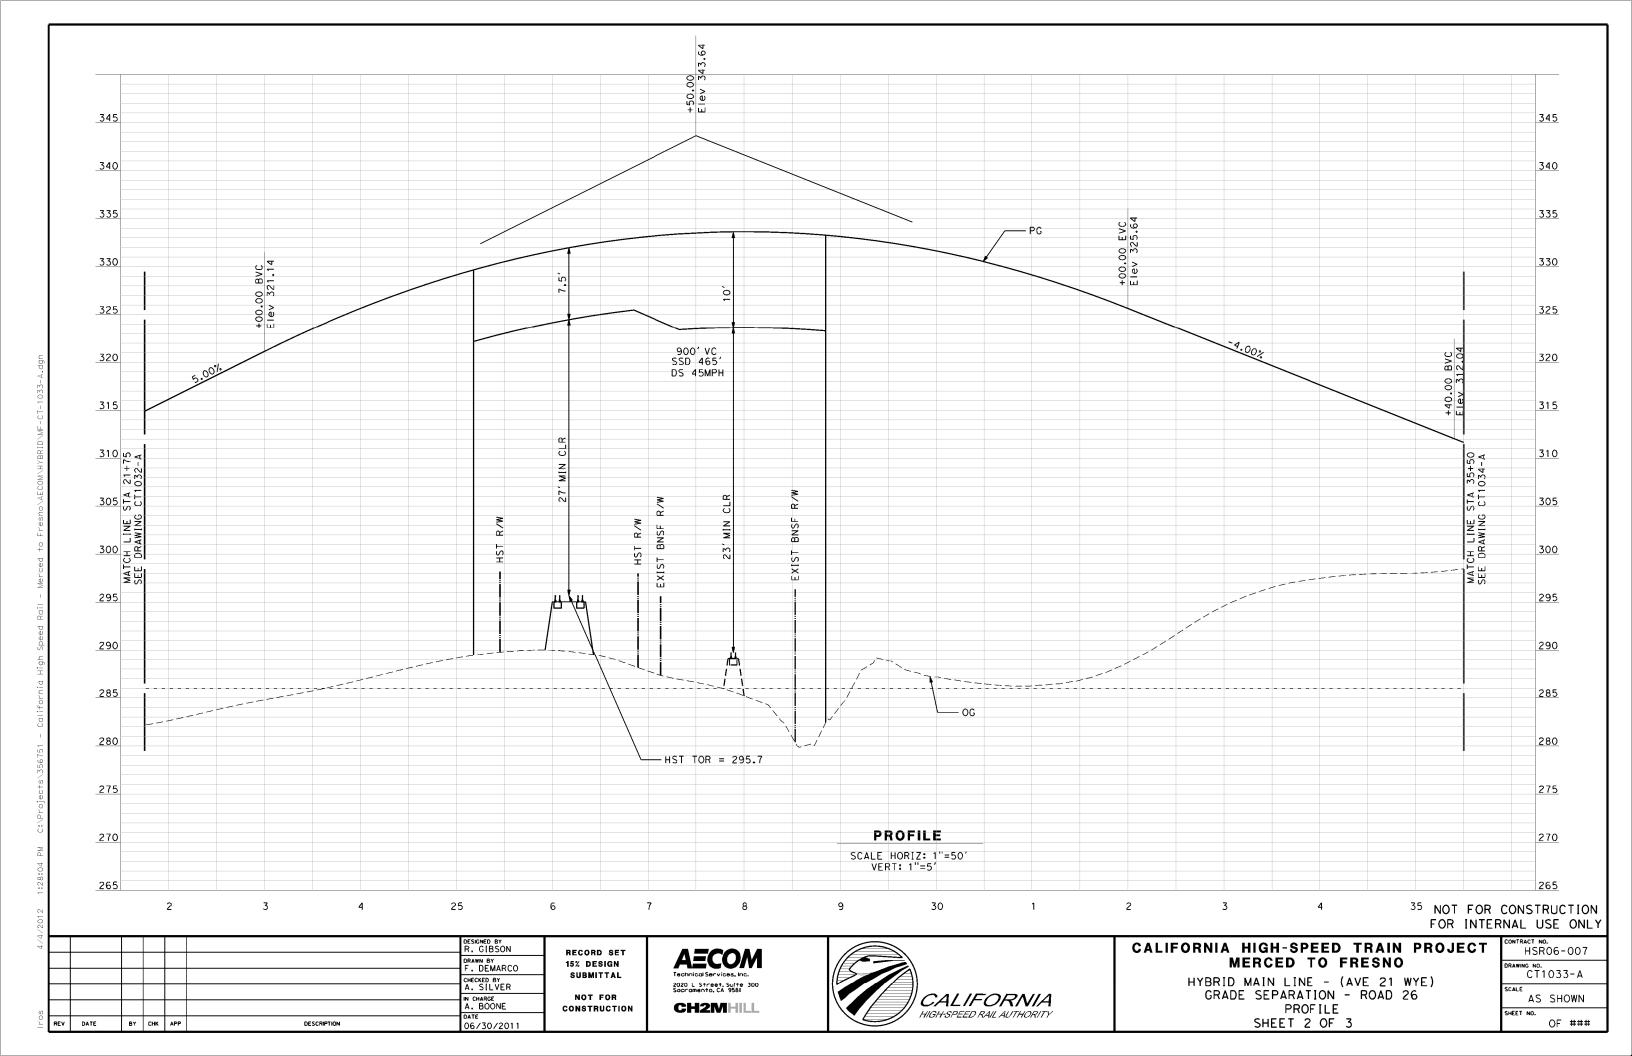

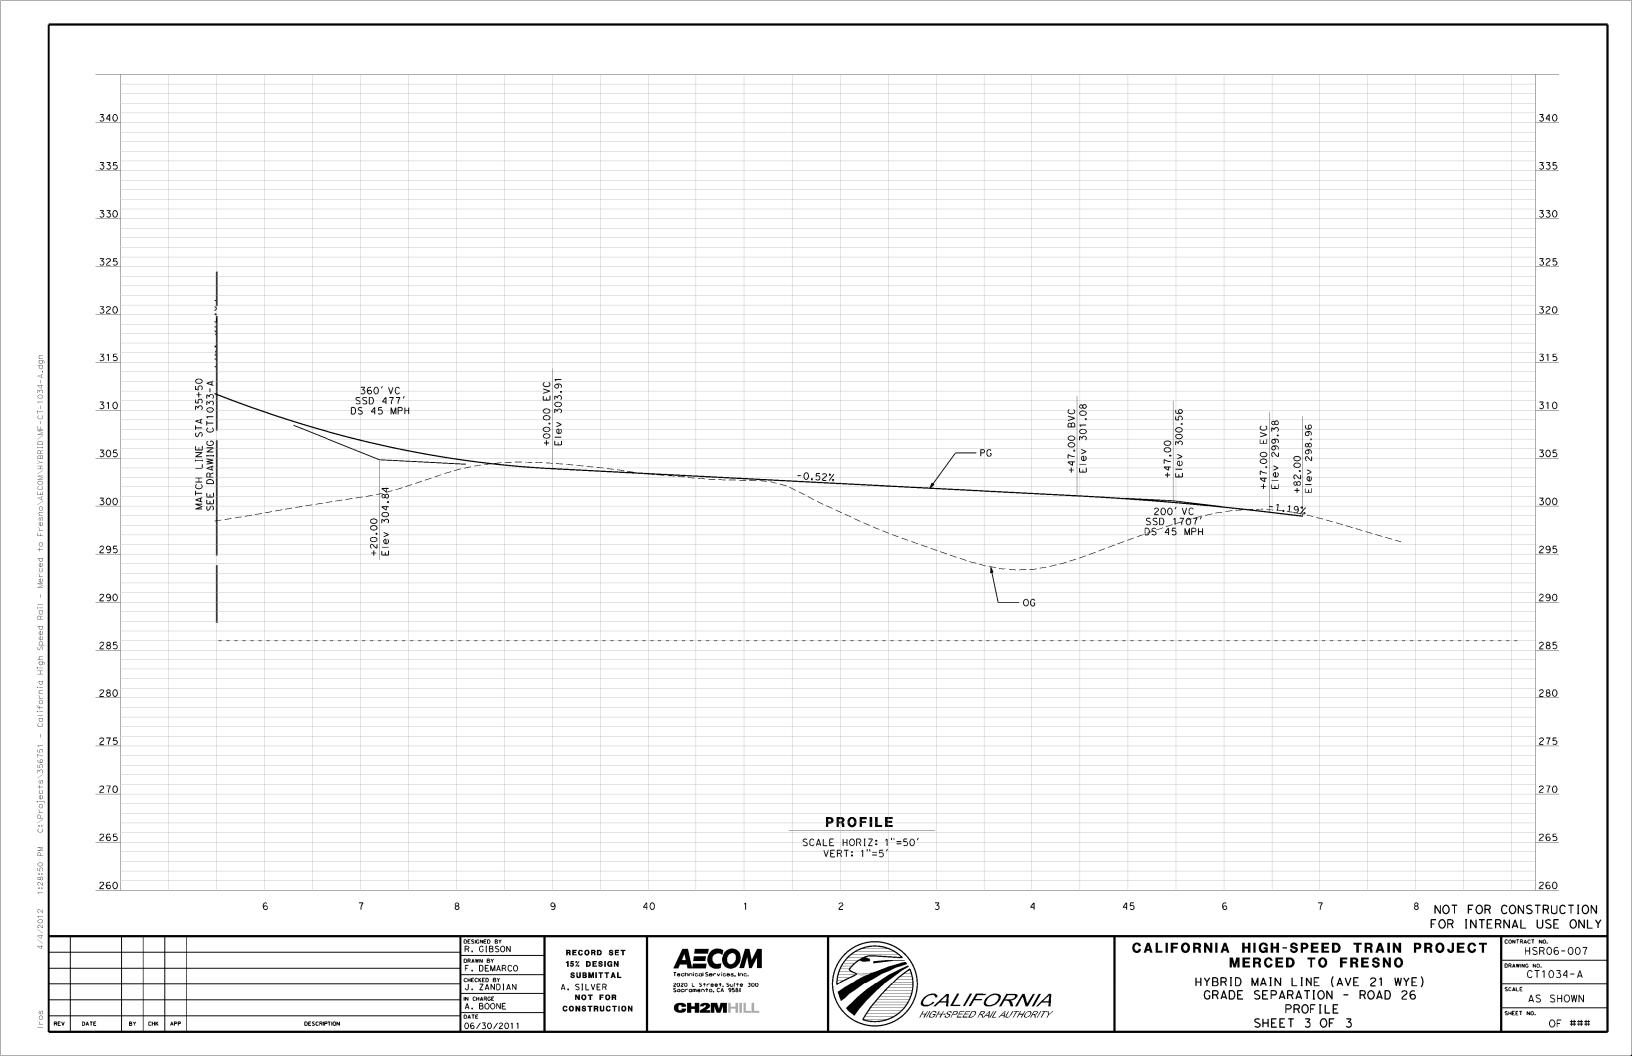

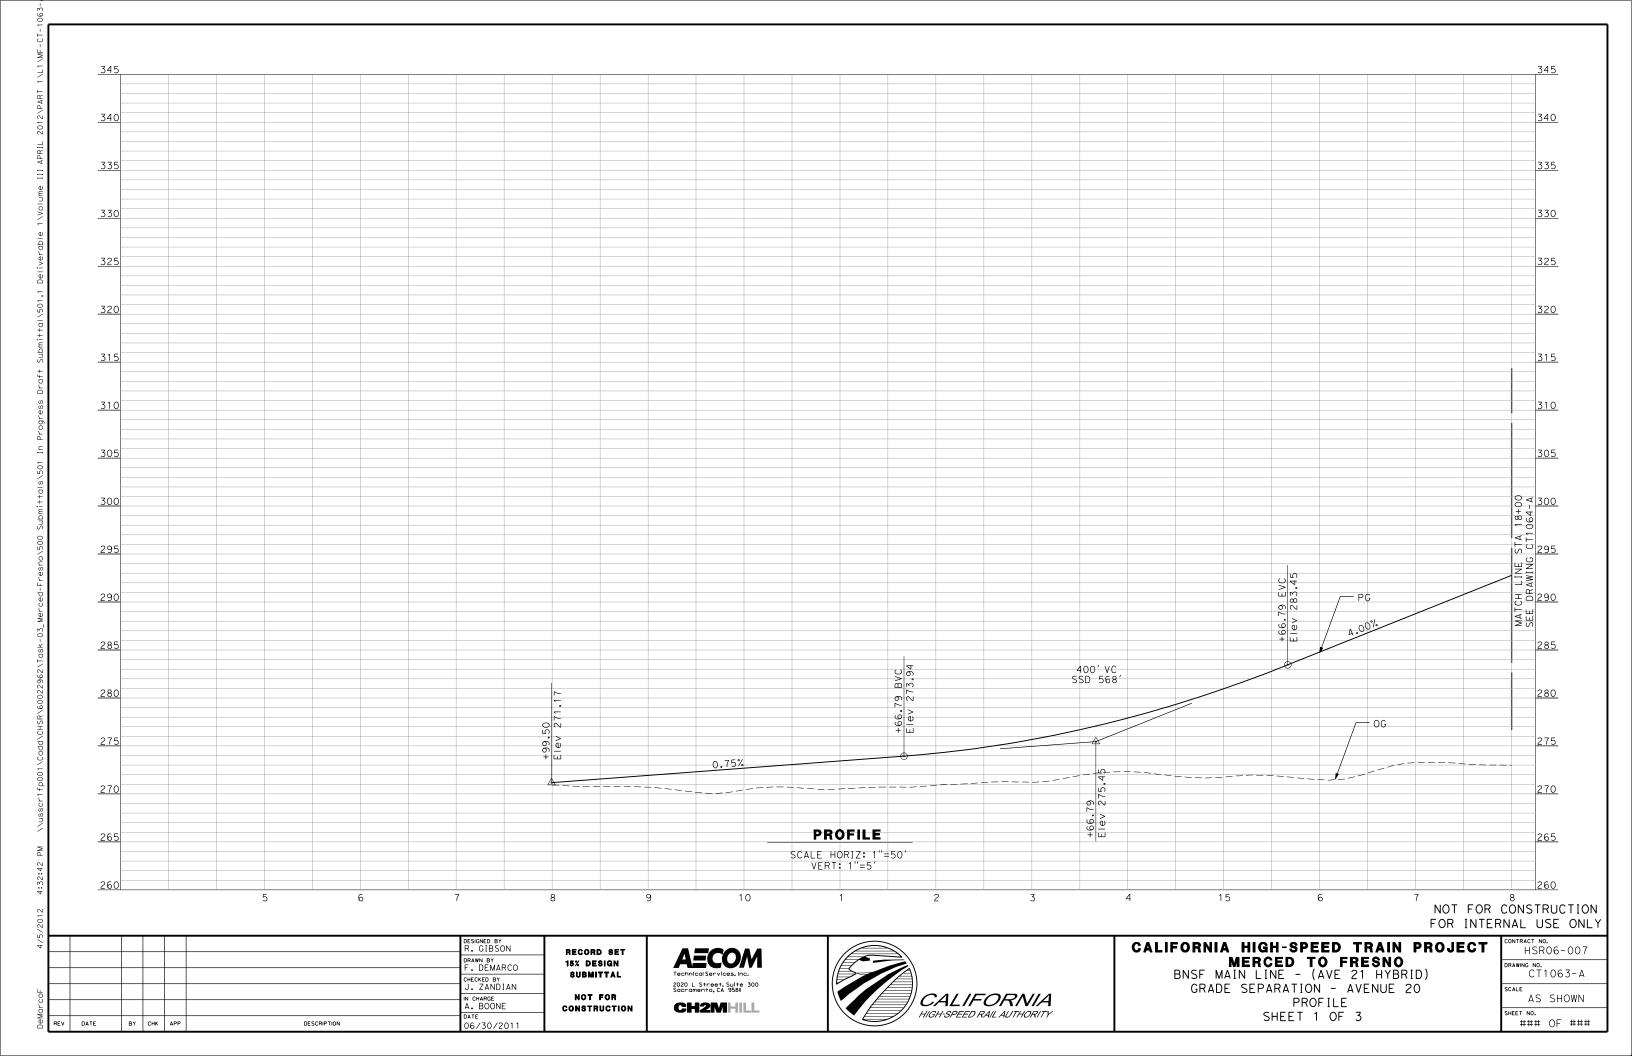

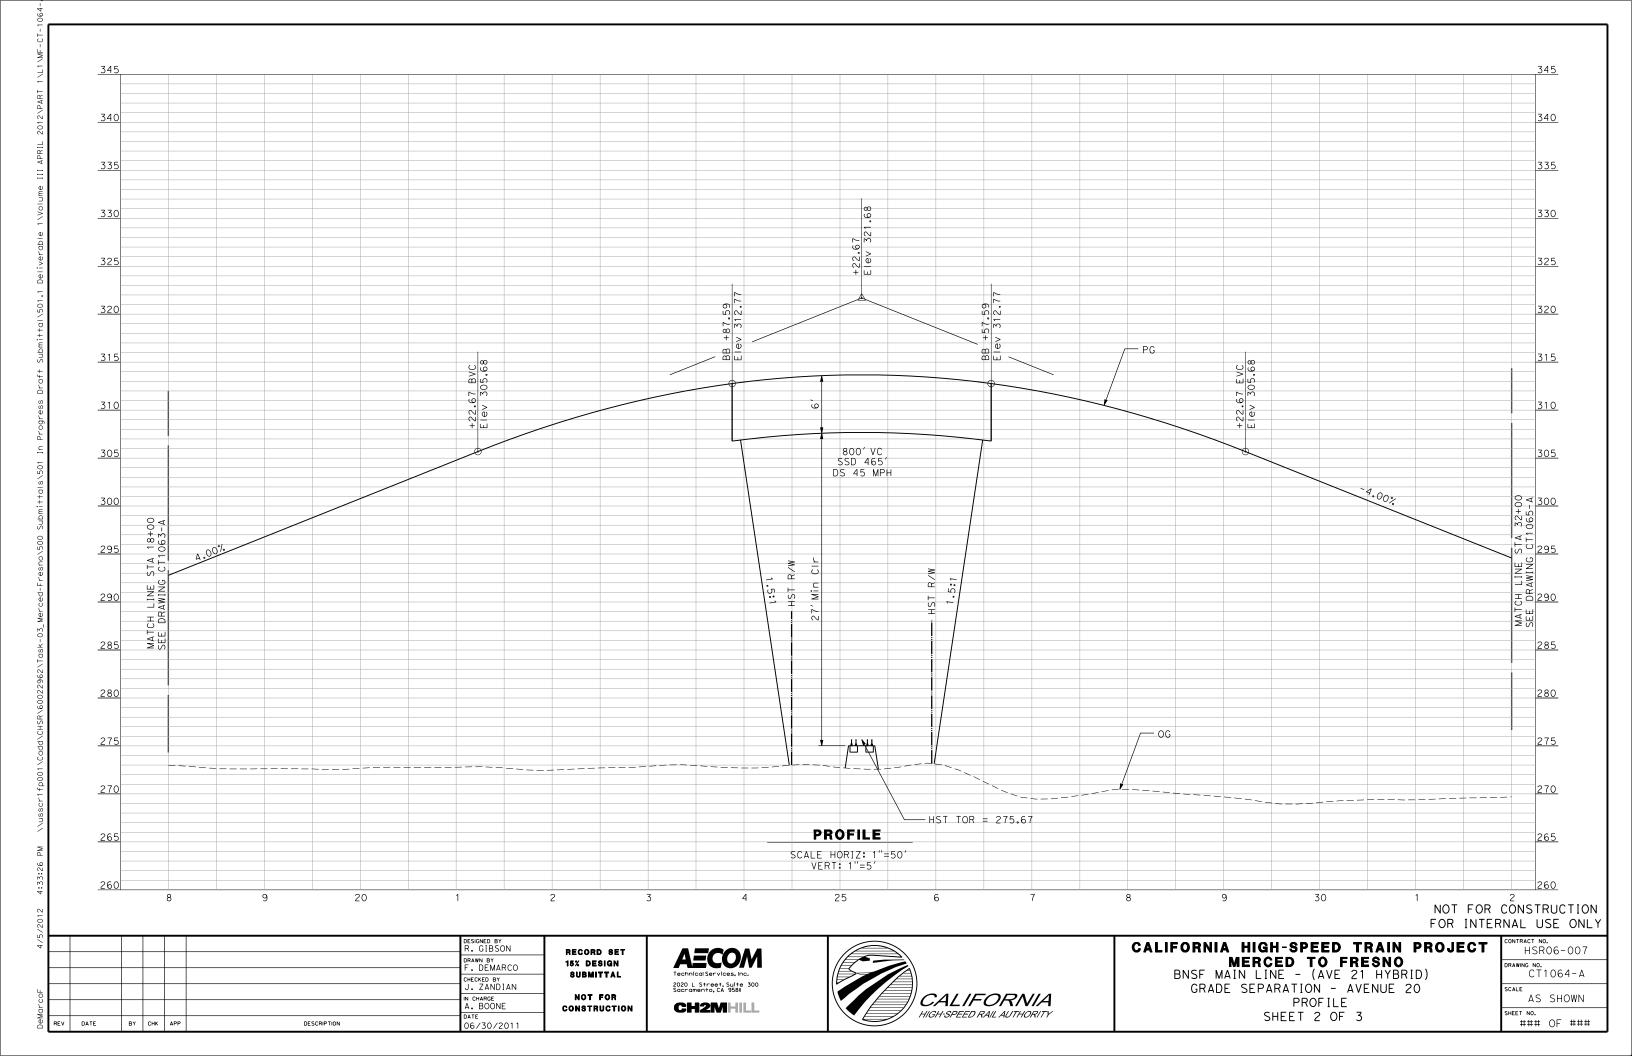

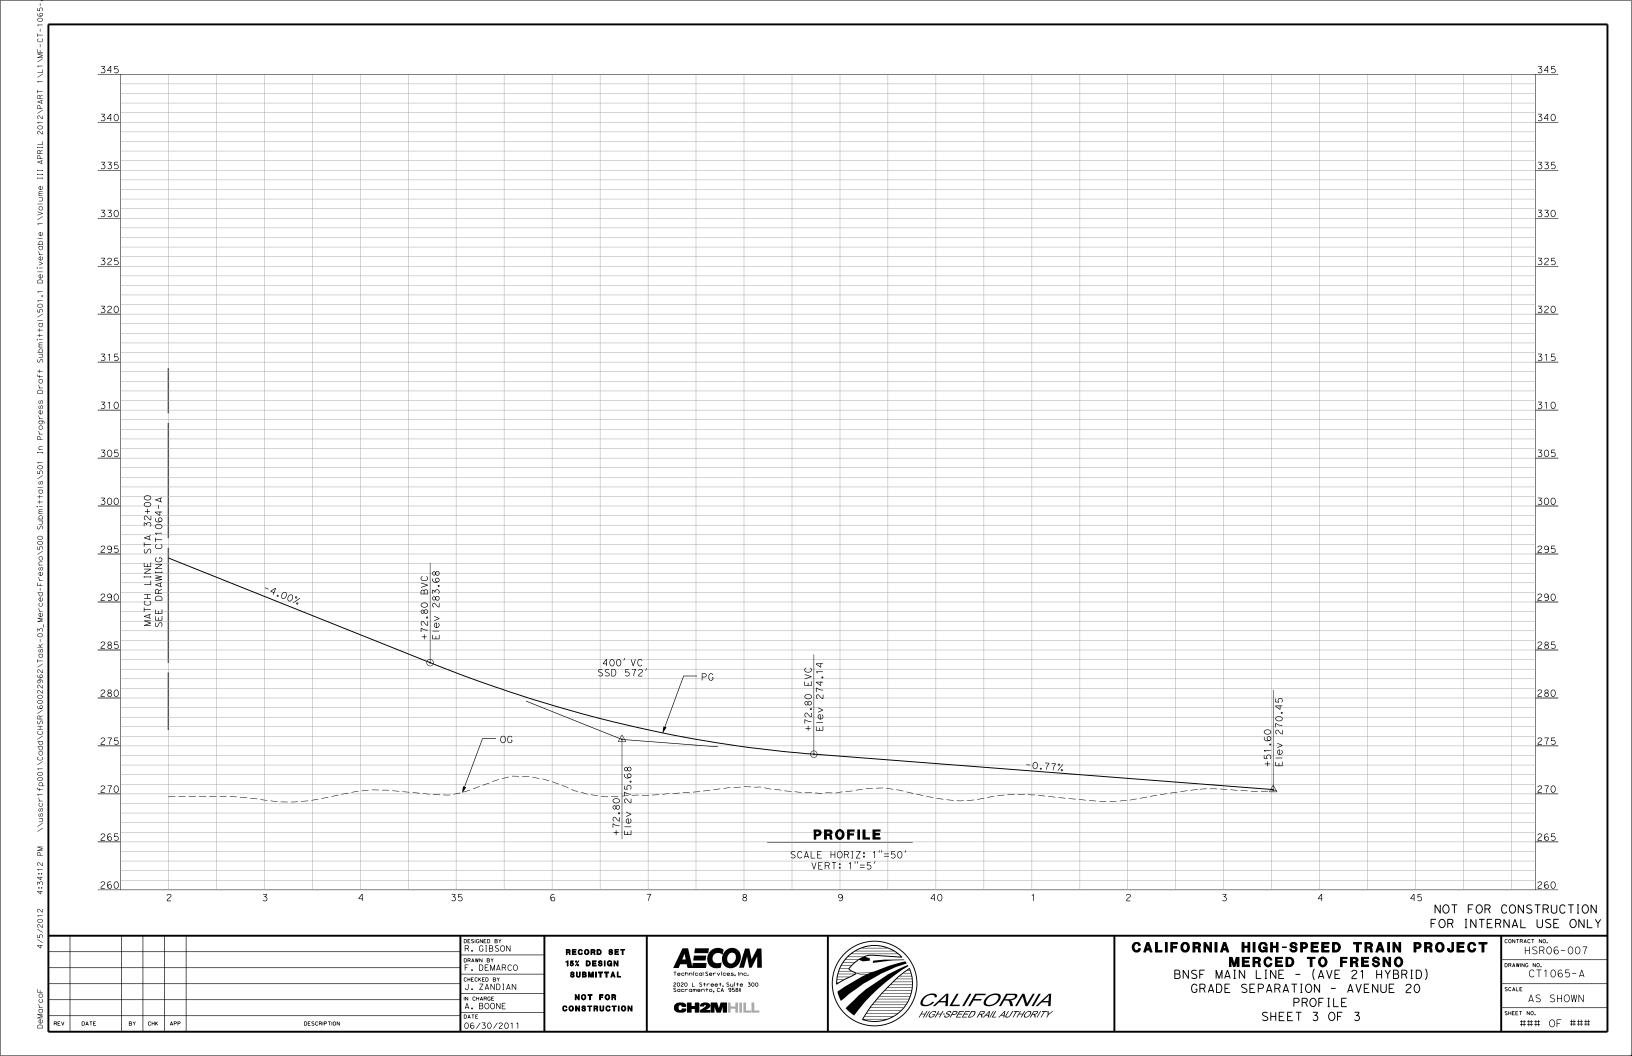

345 345 340 340 335 335 330 330 325 325 320 320 315 310 310 305 305 10R 4 300 10R 4 10R 23 + 00 10R 5 300 +29.46 EVC Elev 286.90 295 290 400′ VC SSD 632′ +29.46 BVC Elev 276.94 285 285 280 280 +29,46 Elev 278.90 275 275 0.98% 270 270 PROFILE 265 SCALE HORIZ: 1"=50' VERT: 1"=5' 260 15 20 NOT FOR CONSTRUCTION FOR INTERNAL USE ONLY DESIGNED BY R. GIBSON CALIFORNIA HIGH-SPEED TRAIN PROJECT HSR06-007 RECORD SET MERCED TO FRESNO
BNSF MAIN LINE - (AVE 21 HYBRID)
GRADE SEPARATION - AVENUE 20 1/2
PROFILE
SHEET 1 OF 3 DRAWN BY F. DEMARCO 15% DESIGN CT1066-A SUBMITTAL CHECKED BY
J. ZANDIAN CALIFORNIA NOT FOR AS SHOWN IN CHARGE A. BOONE **CH2M**HILL CONSTRUCTION DATE 06/30/2011 HIGH-SPEED RAIL AUTHORITY ### OF ###

BY CHK APP

DESCRIPTION

345 345 340 340 335 335 330 330 325 320 320 315 310 310 305 305 300 300 295 290 290 +35.47 EVC Elev 278.04 400' VC SSD 523' 285 285 280 280 275 270 270 PROFILE 265 SCALE HORIZ: 1"=50' VERT: 1"=5' 40 45 9 NOT FOR CONSTRUCTION FOR INTERNAL USE ONLY DESIGNED BY R. GIBSON CALIFORNIA HIGH-SPEED TRAIN PROJECT HSR06-007 RECORD SET MERCED TO FRESNO BNSF MAIN LINE - (AVE 21 HYBRID) GRADE SEPARATION - AVENUE 20 1/2 PROFILE SHEET 3 OF 3 DRAWN BY F. DEMARCO 15% DESIGN CT1068-A SUBMITTAL CHECKED BY
J. ZANDIAN NOT FOR CALIFORNIA AS SHOWN N CHARGE A. BOONE **CH2MHILL** CONSTRUCTION DATE 06/30/2011 HIGH-SPEED RAIL AUTHORITY OF ### BY CHK AP### DESCRIPTION

330 330 325 325 320 315 0.50% 310 310 305 305 300 300 10 15 00+340 + 02-0201.T. 340 DRAWING DRAWING JAMING 335 330 325 325 400′ VC SSD 515′ 320 320 315 315 0.50% 310 310 **PROFILE** 305 SCALE HORIZ: 1"=50' VERT: 1"=5' 20 25 30 NOT FOR CONSTRUCTION FOR INTERNAL USE ONLY DESIGNED BY R. GIBSON CALIFORNIA HIGH-SPEED TRAIN PROJECT HSR06-007 RECORD SET MERCED TO FRESNO BNSF MAIN LINE - (AVE 21 HYBRID) GRADE SEPARATION - ROAD 22 DRAWN BY F. DEMARCO 15% DESIGN SUBMITTAL CT1069-A CHECKED BY
J. ZANDIAN NOT FOR CALIFORNIA AS SHOWN N CHARGE A. BOONE PROFILE SHEET 1 OF 3 **CH2MHILL** CONSTRUCTION HIGH-SPEED RAIL AUTHORITY DATE 06/30/2011

REV DATE

BY CHK APP


DESCRIPTION


330 <u>385</u> 325 380 325 375 320 320 6 370 365 310 310 360 305 305 355 300 300 350 345 340 335 330 330 325 320 -0.53% 315 310 310 **PROFILE** 305 305 SCALE HORIZ: 1"=50' VERT: 1"=5' 50 55 9 NOT FOR CONSTRUCTION FOR INTERNAL USE ONLY DESIGNED BY R. GIBSON CALIFORNIA HIGH-SPEED TRAIN PROJECT HSR06-007 RECORD SET MERCED TO FRESNO BNSF MAIN LINE - (AVE 21 HYBRID) GRADE SEPARATION - ROAD 22 DRAWN BY F. DEMARCO 15% DESIGN SUBMITTAL CT1071-A CHECKED BY
J. ZANDIAN NOT FOR CALIFORNIA AS SHOWN N CHARGE A. BOONE PROFILE SHEET 3 OF 3 **CH2MHILL** CONSTRUCTION DATE 06/30/2011 HIGH-SPEED RAIL AUTHORITY ### OF ###


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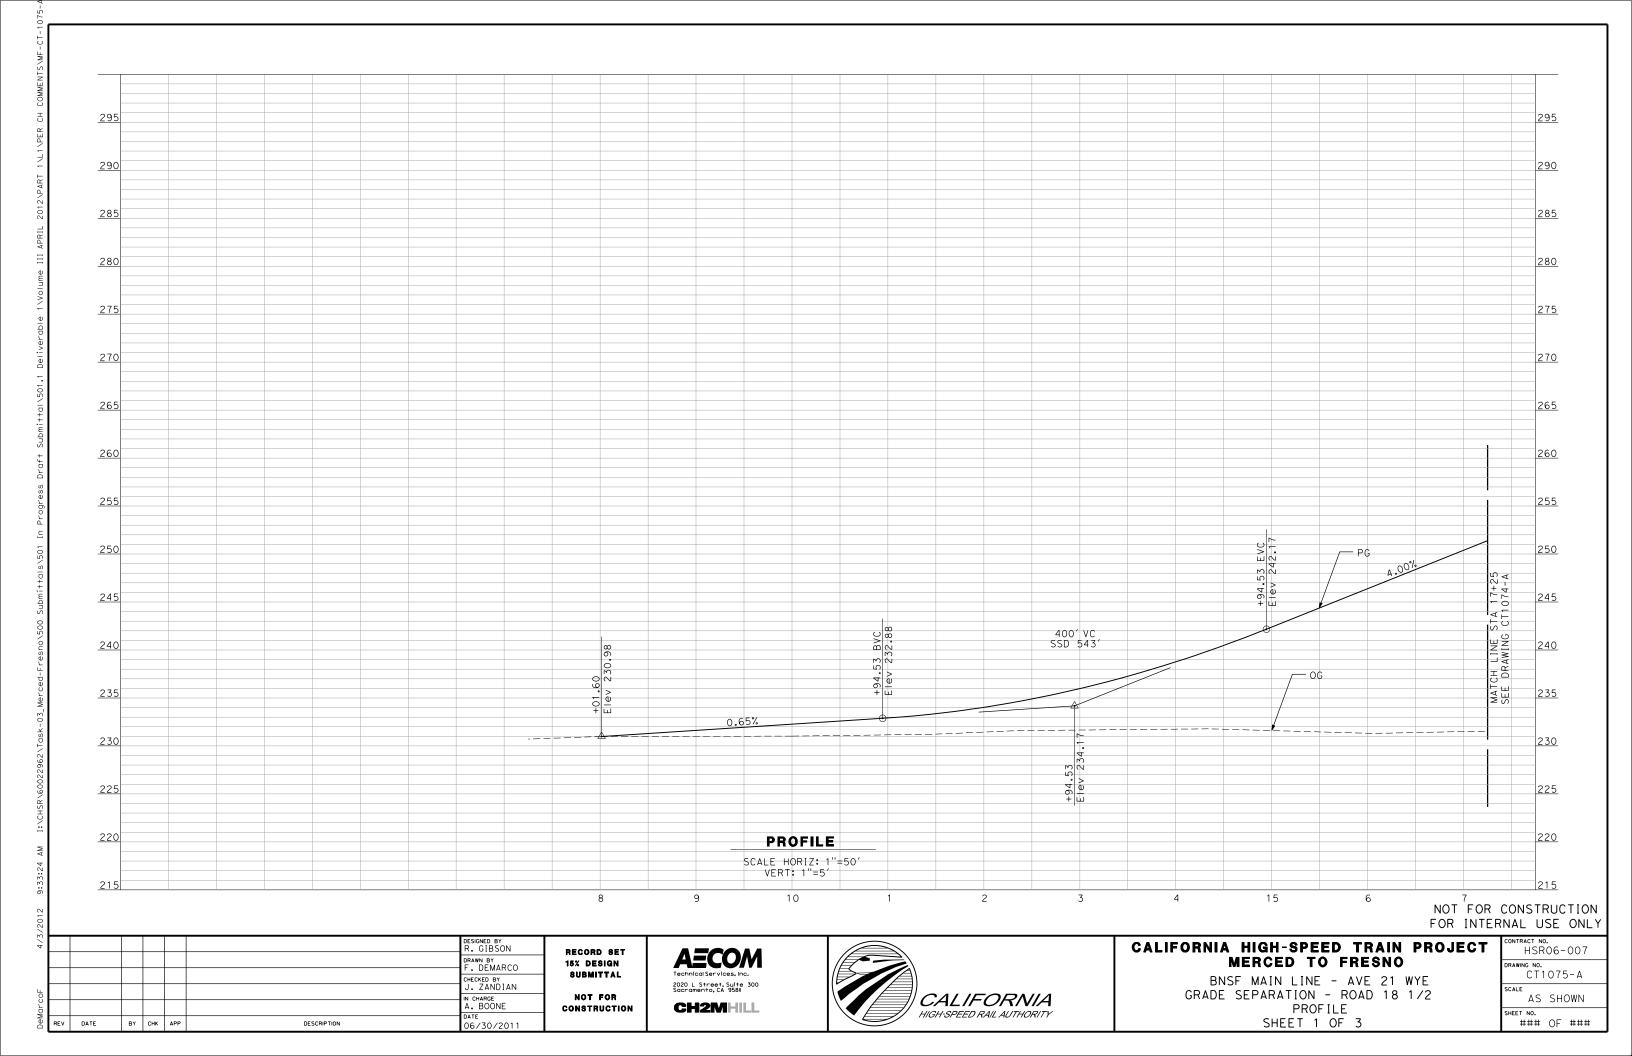
BY CHK APP


DESCRIPTION



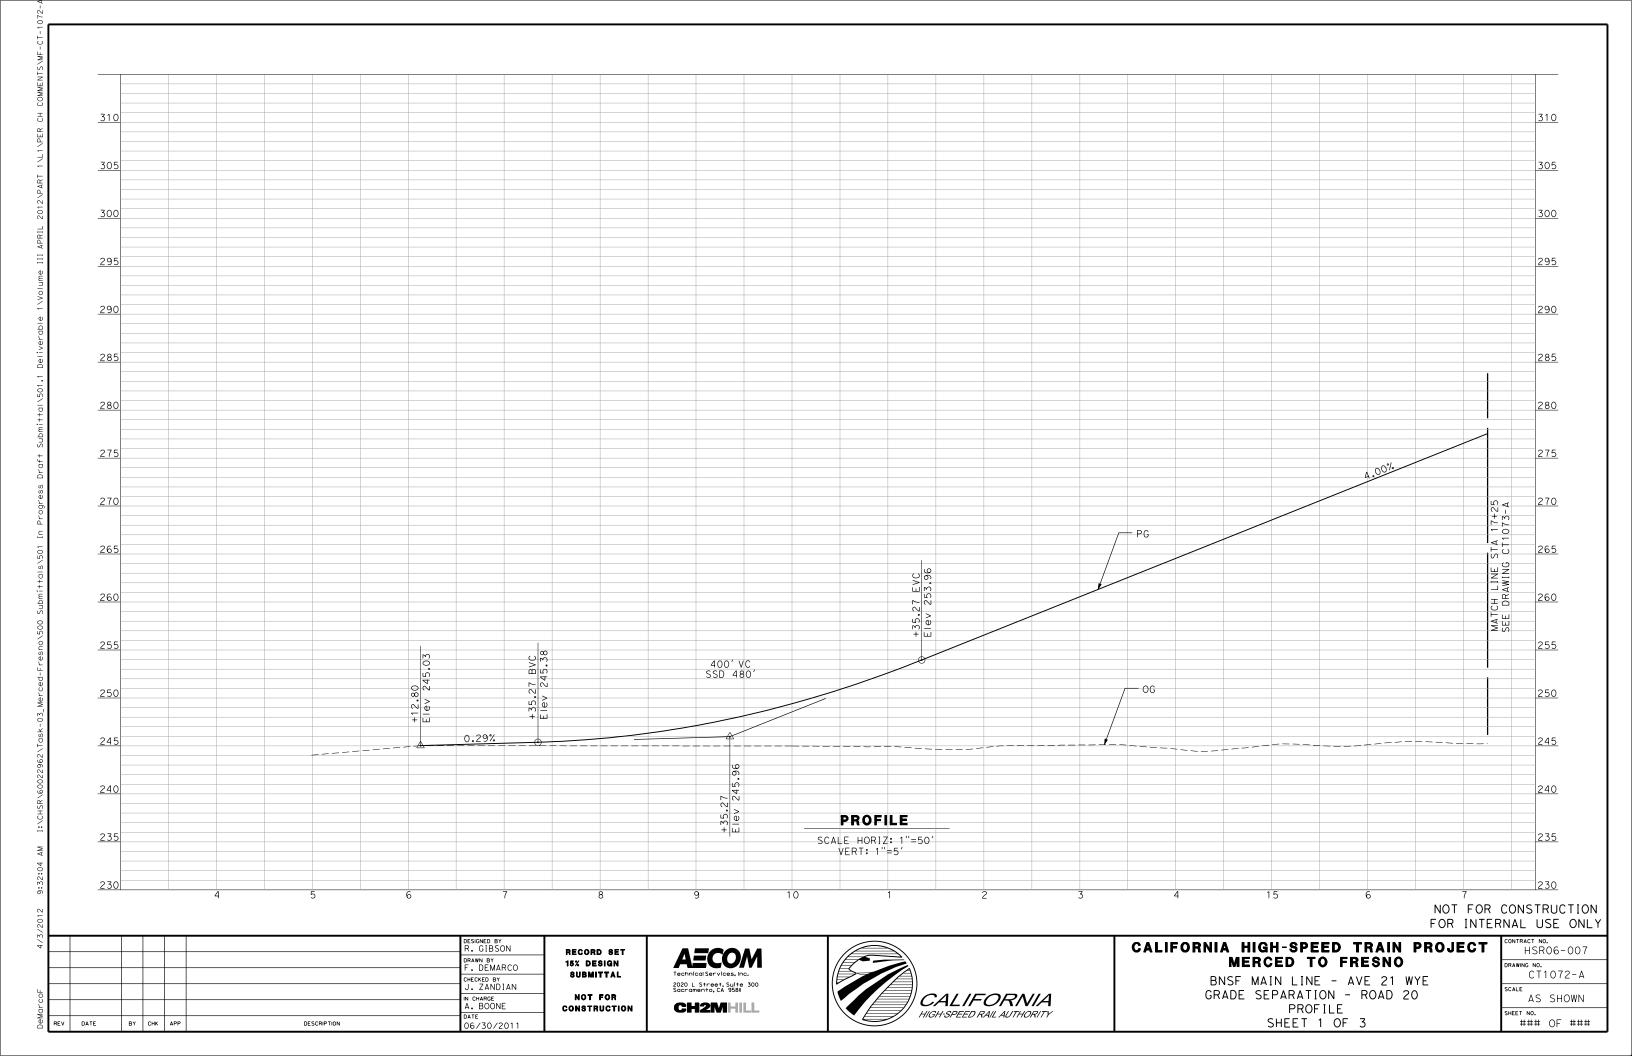

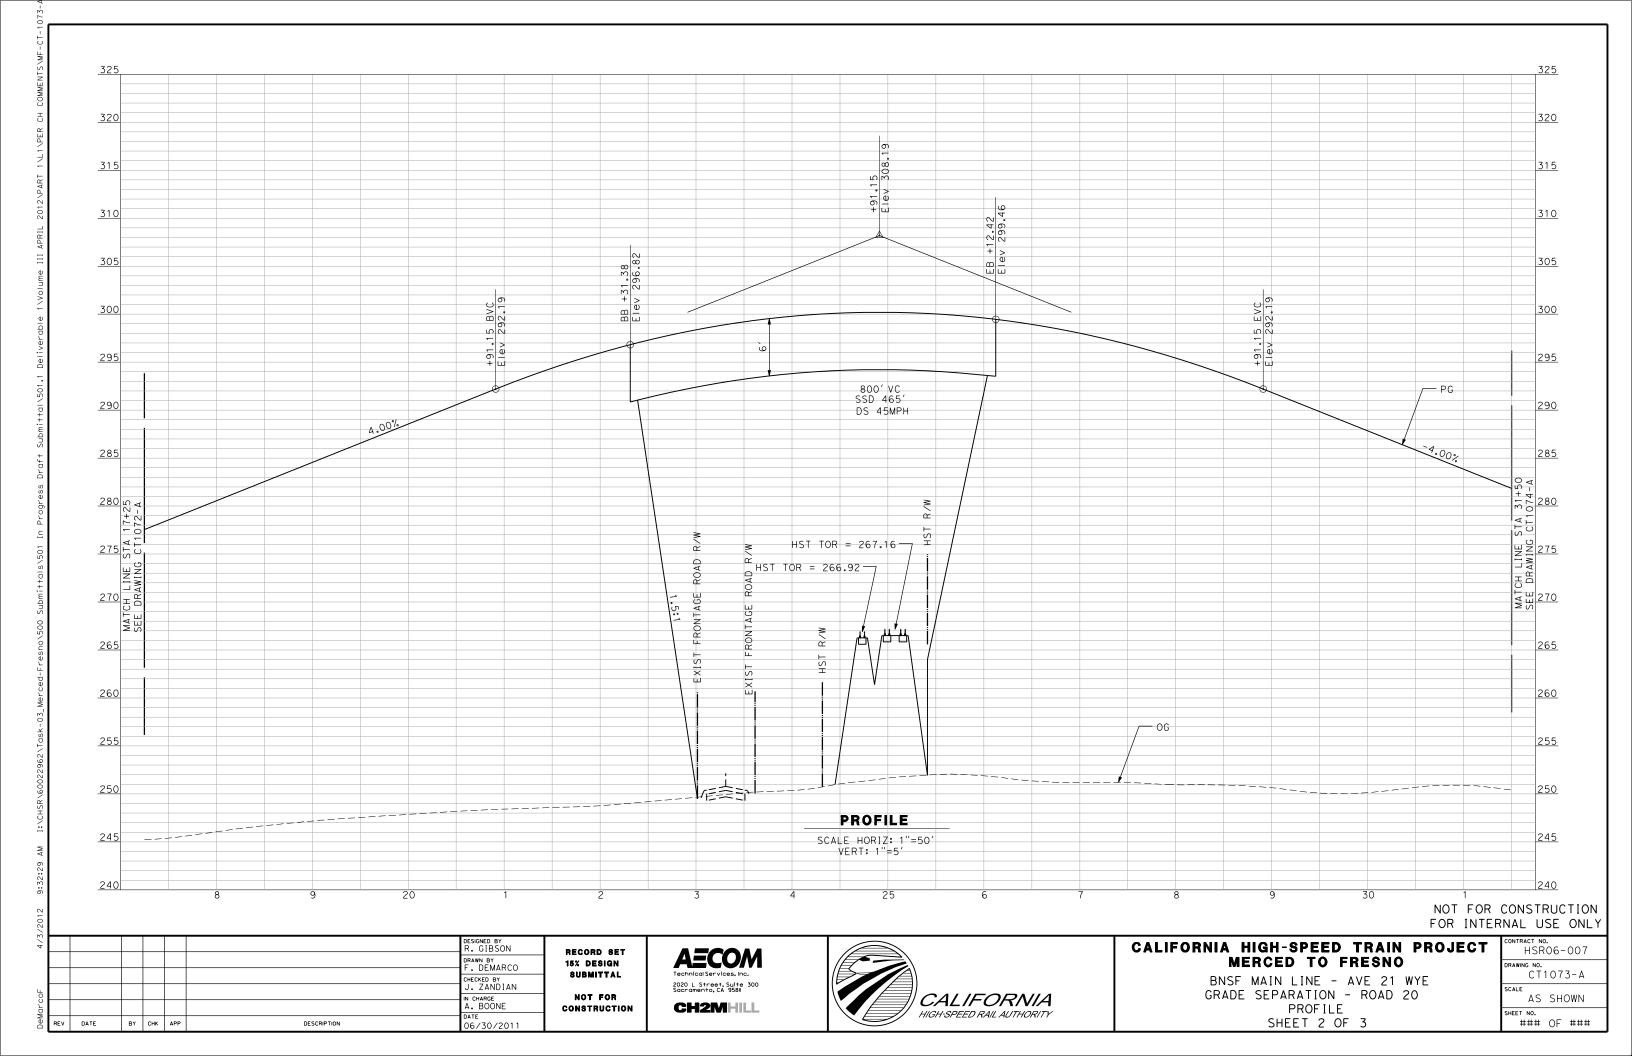

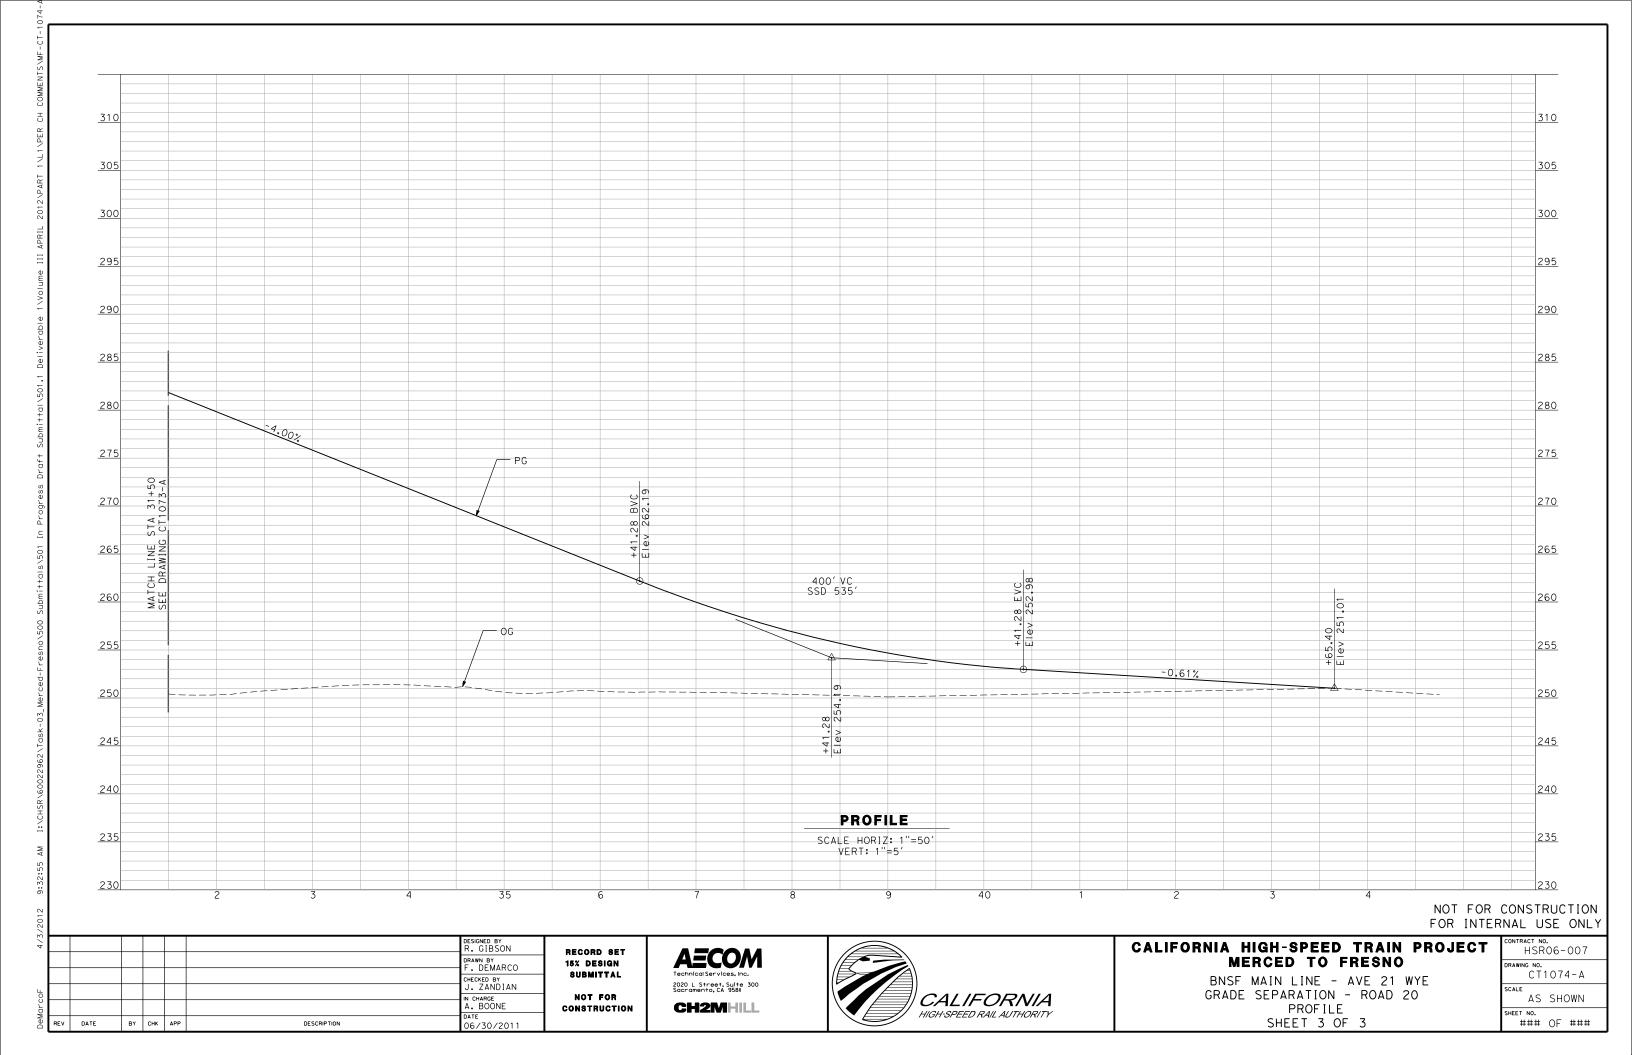

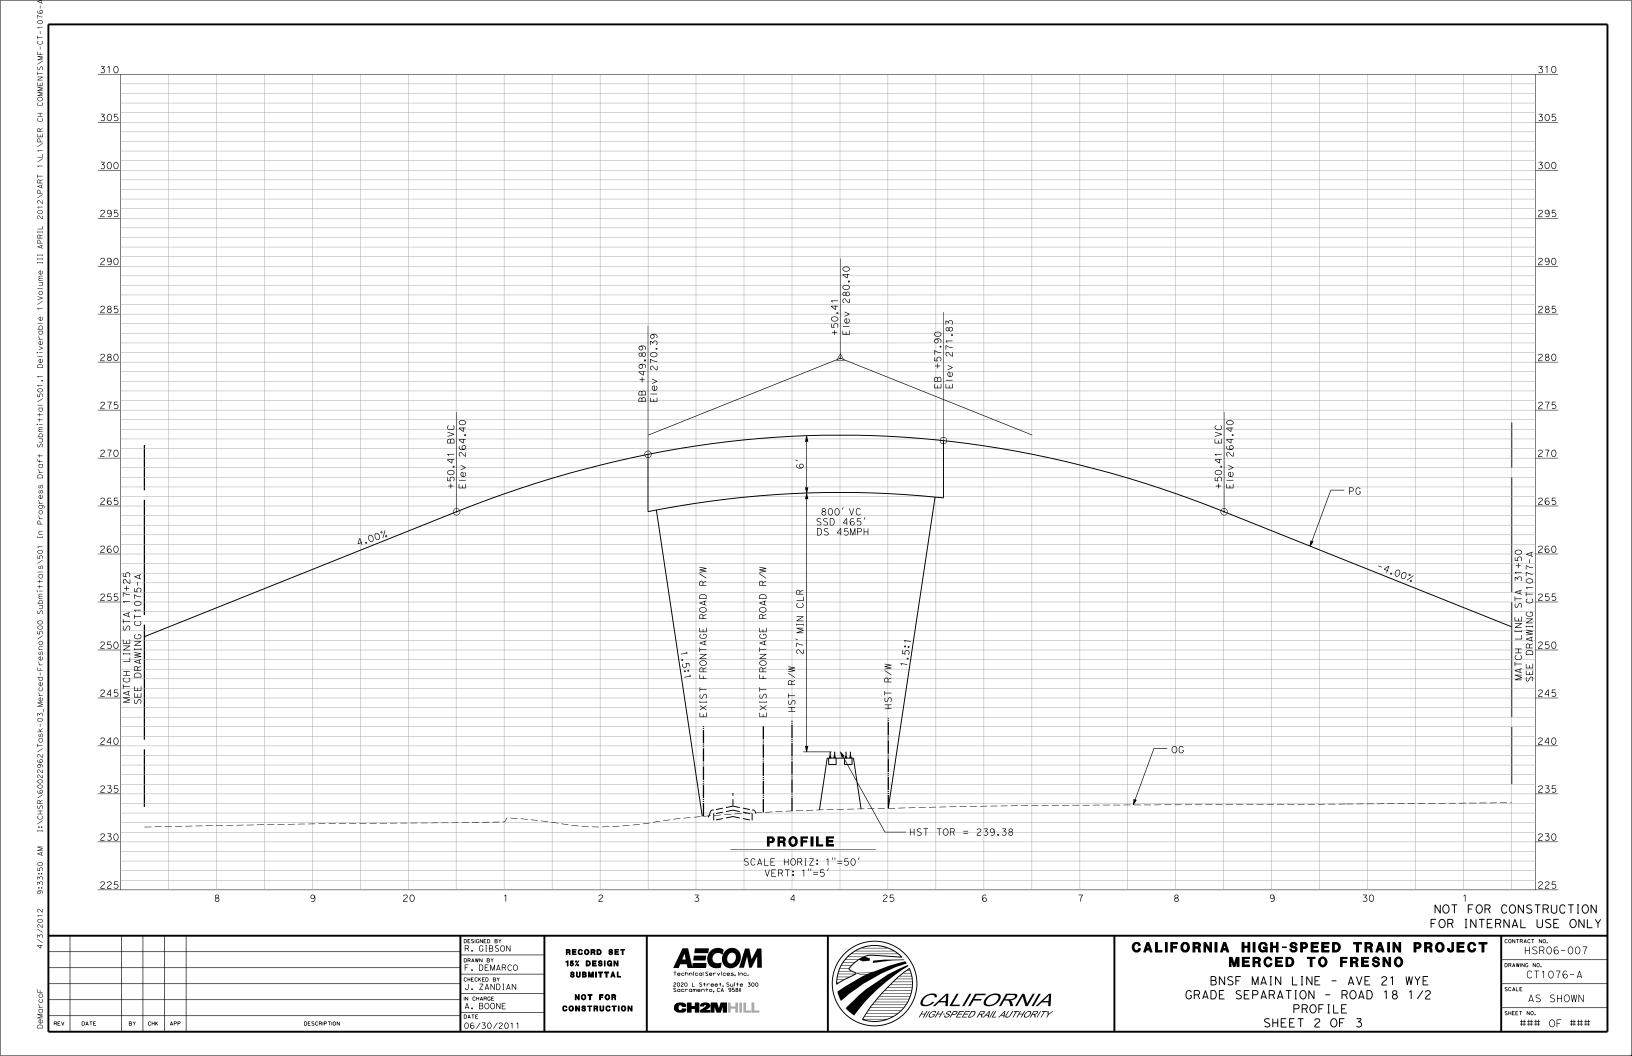

295 295 290 290 285 280 280 275 270 270 265 265 260 260 255 250 245 245 400' VC SSD 476' 240 240 -0.26% 235 230 230 225 220 PROFILE SCALE HORIZ: 1"=50' VERT: 1"=5' 215 NOT FOR CONSTRUCTION FOR INTERNAL USE ONLY DESIGNED BY R. GIBSON CALIFORNIA HIGH-SPEED TRAIN PROJECT HSR06-007 RECORD SET DRAWN BY F. DEMARCO MERCED TO FRESNO 15% DESIGN RAWING NO. CT1077-A SUBMITTAL BNSF MAIN LINE - AVE 21 WYE GRADE SEPARATION - ROAD 18 1/2 CHECKED BY
J. ZANDIAN NOT FOR CALIFORNIA AS SHOWN IN CHARGE A. BOONE **CH2MHILL** CONSTRUCTION PROFILE

DATE 06/30/2011

BY CHK APP

DESCRIPTION

HIGH-SPEED RAIL AUTHORITY

OF

SHEET 3 OF 3

350 350 345 345 340 340 335 335 330 330 325 325 320 320 315 310 310 TA 36+00 T1147-A 305 300 MATCH SEE DRA -0.50% 200' VC 290 290 285 285 280 280 275 PROFILE SCALE HORIZ: 1"=50' VERT: 1"=5' 270 40 NOT FOR CONSTRUCTION FOR INTERNAL USE ONLY DESIGNED BY R. GIBSON CALIFORNIA HIGH-SPEED TRAIN PROJECT RECORD SET 15% DESIGN HSR06-007 DRAWN BY F. DEMARCO MERCED TO FRESNO CT1148-A BNSF MAIN LINE - (AVE 21 HYBRID)
GRADE SEPARATION - AVENUE 7
PROFILE
SHEET 3 OF 3 SUBMITTAL CHECKED BY A. SILVER NOT FOR CALIFORNIA AS SHOWN N CHARGE A. BOONE **CH2MHILL** CONSTRUCTION

DATE 06/30/2011

BY CHK APP

DESCRIPTION

HIGH-SPEED RAIL AUTHORITY

OF ###

230 225 225 +72.68 Elev 213.23 220 220 215 210 210 205 200 200 195 195 600′ VC SSD 304′ — PG 190 190 185 185 300′ VC SSD 254 15' MIN CLR 180 300' VC SSD 254' 180 175 175 170 \rightarrow HST TOR = 165.64 170 165 160 160 155 PROFILE 150 150 SCALE HORIZ: 1"=50' VERT: 1"=5' 145 15 20 NOT FOR CONSTRUCTION FOR INTERNAL USE ONLY DESIGNED BY R. GIBSON CALIFORNIA HIGH-SPEED TRAIN PROJECT HSR06-007 RECORD SET DRAWN BY F. DEMARCO MERCED TO FRESNO CT1149-A 15% DESIGN BNSF MERCED CONNECTION - AVE 21 HYBRID GRADE SEPARATION - G Street
PROFILE
SHEET 1 OF 1 SUBMITTAL CHECKED BY A. SILVER 2020 L Street, Suite 300 Sacramento, CA 95811 CALIFORNIA HIGH-SPEED RAIL AUTHORITY NOT FOR AS SHOWN N CHARGE A. BOONE **CH2MHILL** CONSTRUCTION DATE 06/30/2011 OF ### DATE BY CHK APP DESCRIPTION

285 285 280 280 275 275 270 265 265 260 260 250 250 240 240 235 225 220 220 450′VC SSD 564′ DS 45MPH 0.30% 205 205 PROFILE SCALE HORIZ: 1"=50' VERT: 1"=5' 200 125 DESIGNED BY CALIFORNIA HIGH-SPEED TRAIN PROJECT HSR06-007 RECORD SET DRAWN BY
A. TRINH
CHECKED BY
A. SILVER MERCED TO FRESNO 15% DESIGN SUBMITTAL СТ6000-В UPRR/SR99 MAINLINE/WYE - (AVE 21 HYBRID) GRADE SEPARATION - ROAD 16 ALT 1 2020 L Street, Suite 300 Sacramento, CA 95811 NOT FOR IN CHARGE A. BOONE DATE 06/30/2011 CALIFORNIA AS SHOWN **CH2MHILL PROFILE** CONSTRUCTION HIGH-SPEED RAIL AUTHORITY

BY CHK APP

DESCRIPTION

SHEET 1 OF 4

285 285 280 280 275 275 270 265 265 260 260 255 250 250 245 240 240 235 PG-\ 235 230 SEE 225 225 450'VC SSD 564' DS 45MPH 220 220 215 210 205 PROFILE SCALE HORIZ: 1"=50' VERT: 1"=5' 200 135 DESIGNED BY CALIFORNIA HIGH-SPEED TRAIN PROJECT HSR06-007 RECORD SET AECOM DRAWN BY
A. TRINH
CHECKED BY
A. SILVER MERCED TO FRESNO 15% DESIGN SUBMITTAL CT6001-B UPRR/SR99 MAINLINE/WYE - (AVE 21 HYBRID) GRADE SEPARATION - ROAD 16 ALT 1 2020 L Street, Suite 300 Sacramento, CA 95811 NOT FOR IN CHARGE A. BOONE DATE 06/30/2011 CALIFORNIA AS SHOWN **CH2MHILL PROFILE** CONSTRUCTION HIGH-SPEED RAIL AUTHORITY SHEET 2 OF 4

REV DATE

BY CHK APP

DESCRIPTION

285 285 280 280 275 275 270 270 265 265 260 260 800' VC SSD 365' DS 45 MPH 255 250 250 245 240 240 ROAD R/W 235 230 PROPOSED SOU * 225 LINE CT6003-220 220 __ OG 215 210 210 - HST TOR 223.52 205 205 H\$T TOR 218.24 PROFILE SCALE HORIZ: 1"=50' VERT: 1"=5' 200 DESIGNED BY CALIFORNIA HIGH-SPEED TRAIN PROJECT HSR06-007 RECORD SET drawn by A. TRINH MERCED TO FRESNO 15% DESIGN SUBMITTAL CT6002-B CHECKED BY A. SILVER UPRR/SR99 MAINLINE/WYE - (AVE 21 HYBRID) GRADE SEPARATION - ROAD 16 ALT 1 2020 L Street, Suite 300 Sacramento, CA 95811 IN CHARGE A. BOONE DATE 06/30/2011 NOT FOR CALIFORNIA AS SHOWN **CH2MHILL PROFILE** CONSTRUCTION HIGH-SPEED RAIL AUTHORITY SHEET 3 OF 4

REV DATE

BY CHK APP

DESCRIPTION

285 285 280 280 275 270 265 265 260 260 250 250 245 240 240 235 225 450' VC SSD 564' DS 45MPH 220 220 — OG 215 -0.50% 210 210 205 205 PROFILE SCALE HORIZ: 1"=50' VERT: 1"=5' 200 DESIGNED BY CALIFORNIA HIGH-SPEED TRAIN PROJECT HSR06-007 RECORD SET DRAWN BY
A. TRINH
CHECKED BY
A. SILVER MERCED TO FRESNO 15% DESIGN SUBMITTAL СТ6003-В UPRR/SR99 MAINLINE/WYE - (AVE 21 HYBRID) GRADE SEPARATION - ROAD 16 ALT 1 2020 L Street, Suite 300 Sacramento, CA 95811 NOT FOR IN CHARGE A. BOONE DATE 06/30/2011 CALIFORNIA AS SHOWN **CH2MHILL PROFILE** CONSTRUCTION HIGH-SPEED RAIL AUTHORITY

BY CHK APP

DESCRIPTION

SHEET 4 OF 4

300 300 295 290 290 285 280 280 275 270 270 265 265 260 260 255 255 250 250 245 240 240 235 235 +76.00 BVC Elev 224.16 230 230 OG — 225 220 220 PROFILE SCALE HORIZ: 1"=50' VERT: 1"=5' 215 115 DESIGNED BY CALIFORNIA HIGH-SPEED TRAIN PROJECT HSR06-007 RECORD SET AECOM DRAWN BY
A. TRINH
CHECKED BY
A. SILVER MERCED TO FRESNO 15% DESIGN SUBMITTAL CT6004-B UPRR/SR99 MAINLINE/WYE - (AVE 21 HYBRID) 2020 L Street, Suite 300 Sacramento, CA 95811 GRADE SEPARATION - ROAD 17 1/2 NOT FOR IN CHARGE A. BOONE DATE 06/30/2011 CALIFORNIA AS SHOWN **CH2MHILL PROFILE** CONSTRUCTION HIGH-SPEED RAIL AUTHORITY SHEET 1 OF 4

REV DATE

BY CHK APP

DESCRIPTION

300 300 295 290 290 285 280 280 275 270 270 265 265 260 255 255 250 450' VC SSD 564' DS 45MPH 240 240 0.50% 235 235 0.74% 230 230 225 225 220 220 PROFILE SCALE HORIZ: 1"=50' VERT: 1"=5' 215 125 DESIGNED BY CALIFORNIA HIGH-SPEED TRAIN PROJECT HSR06-007 RECORD SET DRAWN BY
A. TRINH
CHECKED BY
A. SILVER MERCED TO FRESNO 15% DESIGN SUBMITTAL CT6016-B UPRR/SR99 WYE - (AVE 21 HYBRID) GRADE SEPARATION - AVENUE 22 2020 L Street, Suite 300 Sacramento, CA 95811 IN CHARGE A. BOONE DATE 06/30/2011 NOT FOR CALIFORNIA AS SHOWN **CH2MHILL** PROFILE CONSTRUCTION HIGH-SPEED RAIL AUTHORITY SHEET 1 OF 3

REV DATE

BY CHK APP

DESCRIPTION

305 305 300 300 295 295 290 290 285 280 280 275 270 270 265 260 260 255 250 245 245 240 240 LINE CT6020-PG-PROFILE SCALE HORIZ: 1"=50' VERT: 1"=5' 220 115 DESIGNED BY CALIFORNIA HIGH-SPEED TRAIN PROJECT HSR06-007 RECORD SET DRAWN BY
A. TRINH
CHECKED BY
A. SILVER MERCED TO FRESNO 15% DESIGN SUBMITTAL CT6019-B UPRR/SR99 WYE - (AVE 21 HYBRID) GRADE SEPARATION - AVENUE 21 1/2 2020 L Street, Suite 300 Sacramento, CA 95811 NOT FOR IN CHARGE A. BOONE DATE 06/30/2011 CALIFORNIA AS SHOWN **CH2MHILL** CONSTRUCTION PROF ILE HIGH-SPEED RAIL AUTHORITY

BY CHK APP

DESCRIPTION


SHEET 1 OF 5

<u> 305</u> 305 300 300 295 295 290 290 285 280 280 275 270 270 265 260 260 +74,54 EVC E1ev 246,46 255 +24,54 BVC Elev 236.33 245 245 450′VC SSD 564′ DS 45MPH 240 240 PG-235 235 230 230 PROFILE SCALE HORIZ: 1"=50' VERT: 1"=5' 220 130 DESIGNED BY CALIFORNIA HIGH-SPEED TRAIN PROJECT HSR06-007 RECORD SET AECOM DRAWN BY
A. TRINH
CHECKED BY
A. SILVER MERCED TO FRESNO 15% DESIGN SUBMITTAL CT6020-B UPRR/SR99 WYE - (AVE 21 HYBRID) GRADE SEPARATION - AVENUE 21 1/2 2020 L Street, Suite 300 Sacramento, CA 95811 NOT FOR IN CHARGE A. BOONE DATE 06/30/2011 CALIFORNIA AS SHOWN **CH2MHILL** PROFILE CONSTRUCTION HIGH-SPEED RAIL AUTHORITY

BY CHK APP

DESCRIPTION

SHEET 2 OF 5

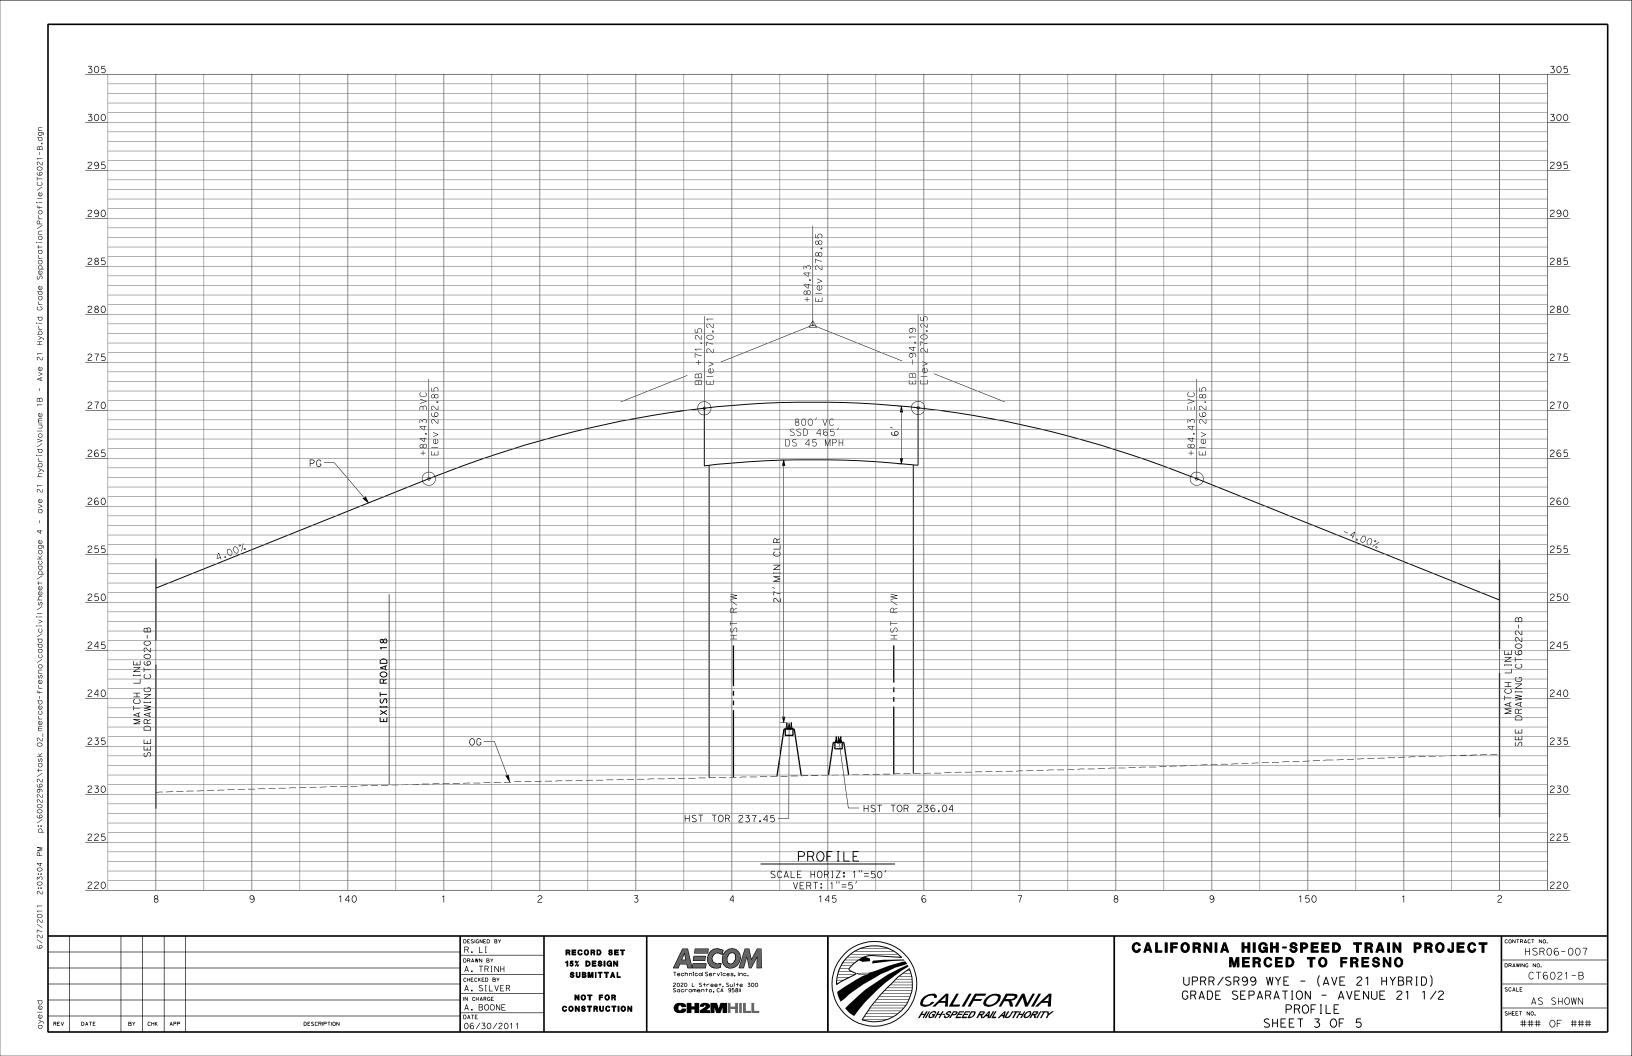

305 <u> 305</u> 300 300 295 295 290 290 285 280 280 275 270 270 265 265 260 260 255 250 250 MATCH 450'VC SSD 564' DS 45MPH 245 245 86.06 lev 23 240 LINE CT6023-240 -0.30% 235 230 230 PROFILE SCALE HORIZ: 1"=50' VERT: 1"=5' 220 160 DESIGNED BY CALIFORNIA HIGH-SPEED TRAIN PROJECT HSR06-007 RECORD SET DRAWN BY
A. TRINH
CHECKED BY
A. SILVER MERCED TO FRESNO 15% DESIGN SUBMITTAL CT6022-B UPRR/SR99 WYE - (AVE 21 HYBRID) GRADE SEPARATION - AVENUE 21 1/2 2020 L Street, Suite 300 Sacramento, CA 95811 NOT FOR IN CHARGE A. BOONE DATE 06/30/2011 CALIFORNIA AS SHOWN **CH2MHILL** PROFILE CONSTRUCTION HIGH-SPEED RAIL AUTHORITY

REV DATE

BY CHK APP

DESCRIPTION

SHEET 4 OF 5

305 305 300 300 295 295 290 290 285 280 280 275 275 270 270 265 265 260 260 255 255 250 245 245 240 240 235 235 230 230 PROFILE SCALE HORIZ: 1"=50' VERT: 1"=5' 220 170 DESIGNED BY CALIFORNIA HIGH-SPEED TRAIN PROJECT HSR06-007 RECORD SET DRAWN BY
A. TRINH
CHECKED BY
A. SILVER MERCED TO FRESNO 15% DESIGN SUBMITTAL CT6023-B UPRR/SR99 WYE - (AVE 21 HYBRID) GRADE SEPARATION - AVENUE 21 1/2 2020 L Street, Suite 300 Sacramento, CA 95811 NOT FOR IN CHARGE
A. BOONE
DATE
06/30/2011 CALIFORNIA AS SHOWN **CH2MHILL** PROFILE CONSTRUCTION

REV DATE

BY CHK APP

DESCRIPTION

HIGH-SPEED RAIL AUTHORITY

SHEET NO. ### OF ###

SHEET 5 OF 5

285 285 280 280 275 270 265 265 260 260 255 250 250 245 240 240 235 +19.97 EVC 225 +69.97 BVC Elev 211.67 220 220 450' VC SSD 564' DS 45 MPH 215 OG — 210 205 205 PROFILE SCALE HORIZ: 1"=50' VERT: 1"=5' 200 130 DESIGNED BY CALIFORNIA HIGH-SPEED TRAIN PROJECT HSR06-007 RECORD SET DRAWN BY
C. DELOS REYES
CHECKED BY
A. SILVER MERCED TO FRESNO 15% DESIGN SUBMITTAL CT6024-B UPRR/SR99 MAINLINE/WYE - (AVE 21 HYBRID) GRADE SEPARATION - ROAD 16 ALONG EXIST ALT 2 2020 L Street, Suite 300 Sacramento, CA 95811 IN CHARGE A. BOONE DATE 06/30/2011 NOT FOR CALIFORNIA AS SHOWN **CH2MHILL PROFILE** CONSTRUCTION HIGH-SPEED RAIL AUTHORITY SHEET 1 OF 3 ### OF ###

BY CHK APP


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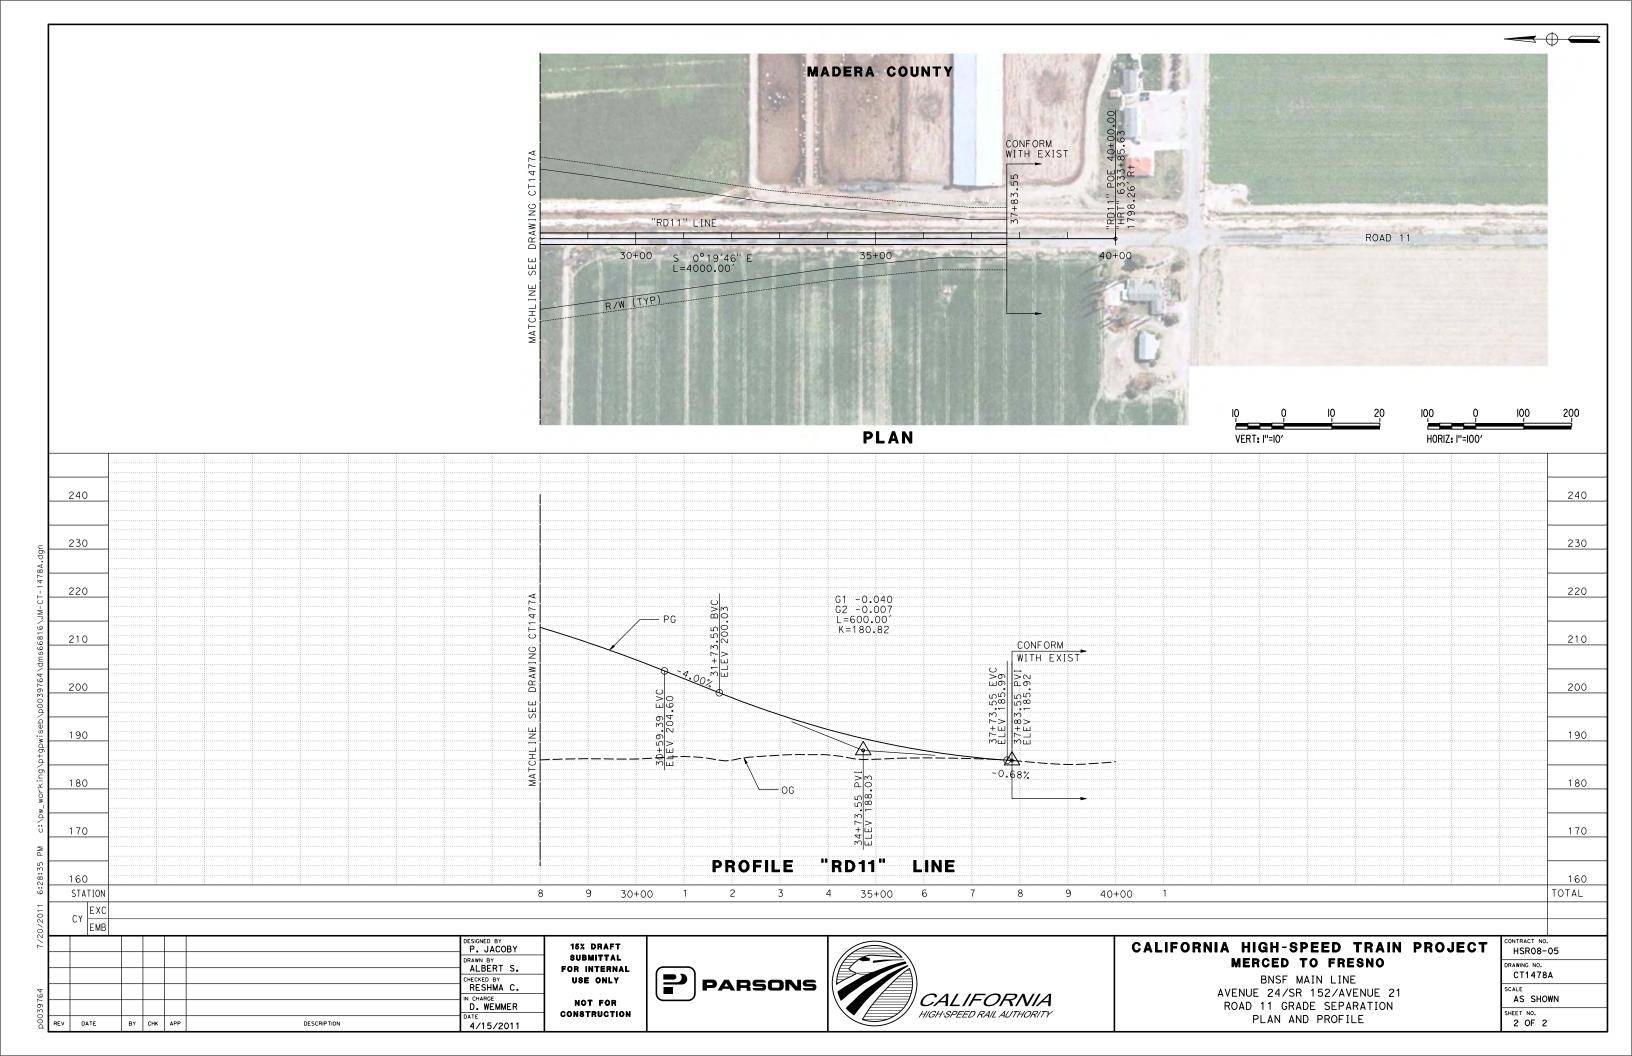
285 285 280 280 275 270 265 265 260 260 255 250 250 245 240 240 235 230 225 220 +00.00 Elev 212. CONFORM 220 450′ VC SSD 564′ DS 45 MPH 215 210 210 205 205 PROFILE SCALE HORIZ: 1"=50' VERT: 1"=5' 200 160 165 DESIGNED BY CALIFORNIA HIGH-SPEED TRAIN PROJECT HSR06-007 RECORD SET AECOM DRAWN BY
C. DELOS REYES
CHECKED BY
A. SILVER MERCED TO FRESNO 15% DESIGN SUBMITTAL CT6026-B UPRR/SR99 MAINLINE/WYE - (AVE 21 HYBRID)
GRADE SEPARATION - ROAD 16 ALONG EXIST ALT 2 2020 L Street, Suite 300 Sacramento, CA 95811 NOT FOR IN CHARGE A. BOONE DATE 06/30/2011 CALIFORNIA AS SHOWN **CH2MHILL PROFILE** CONSTRUCTION HIGH-SPEED RAIL AUTHORITY SHEET 3 OF 3 ### OF ###


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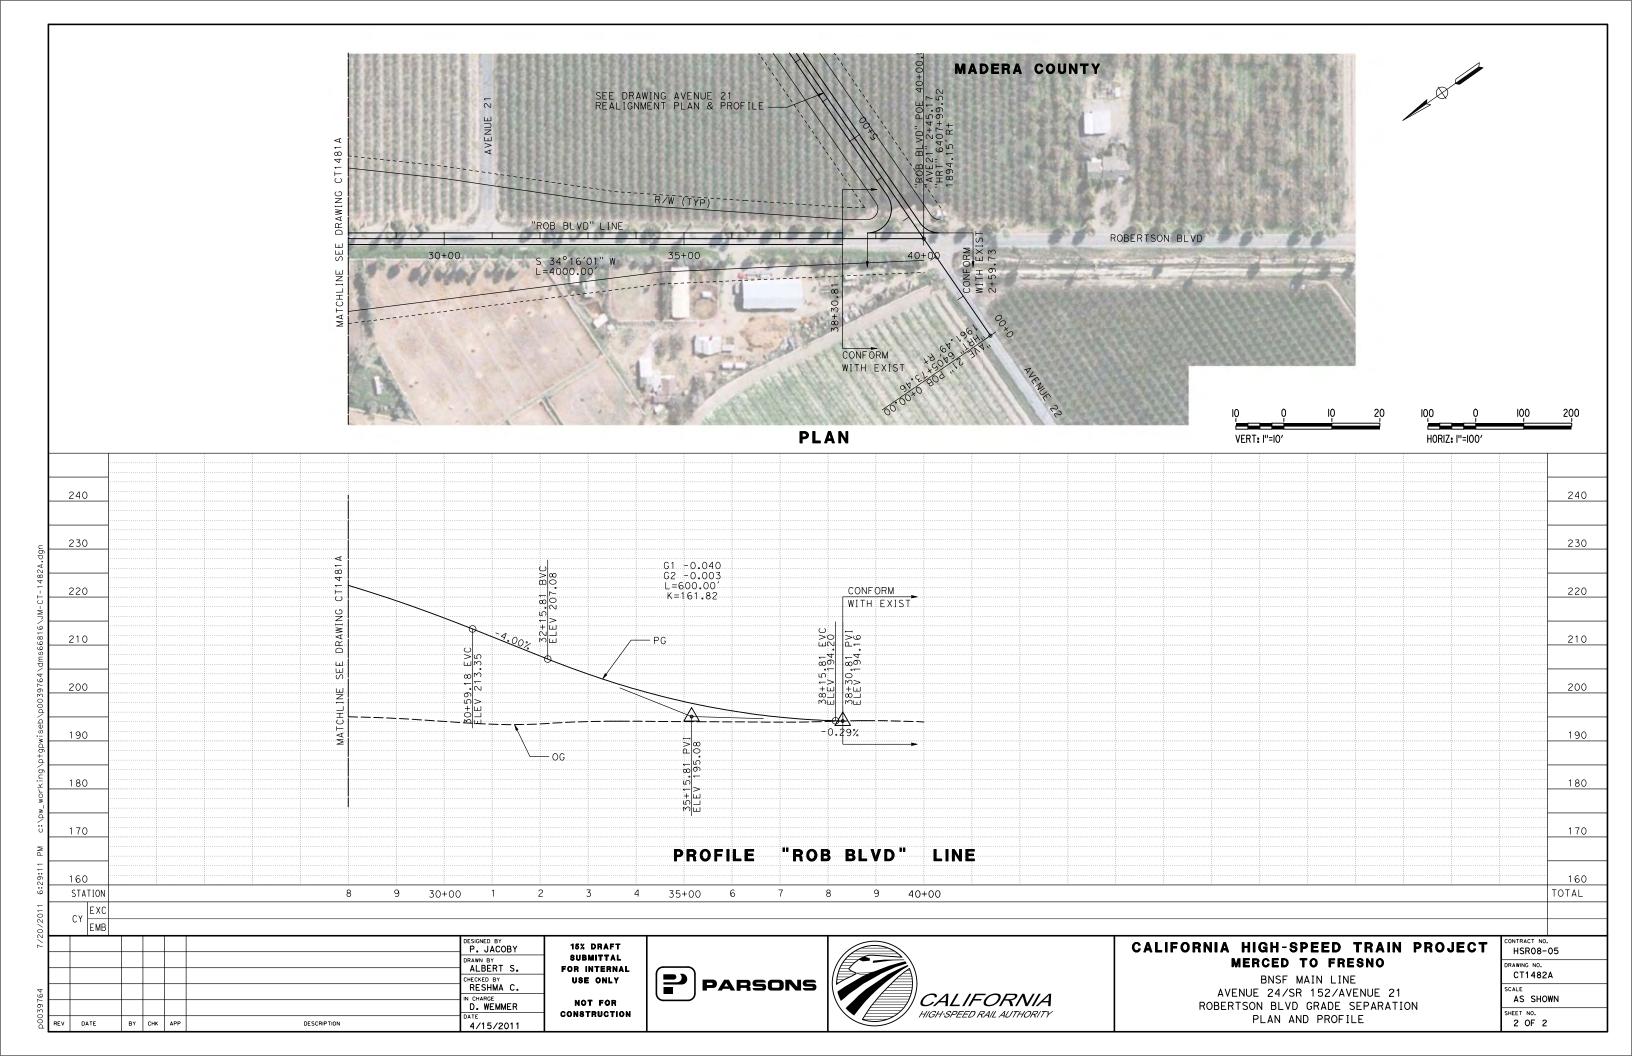
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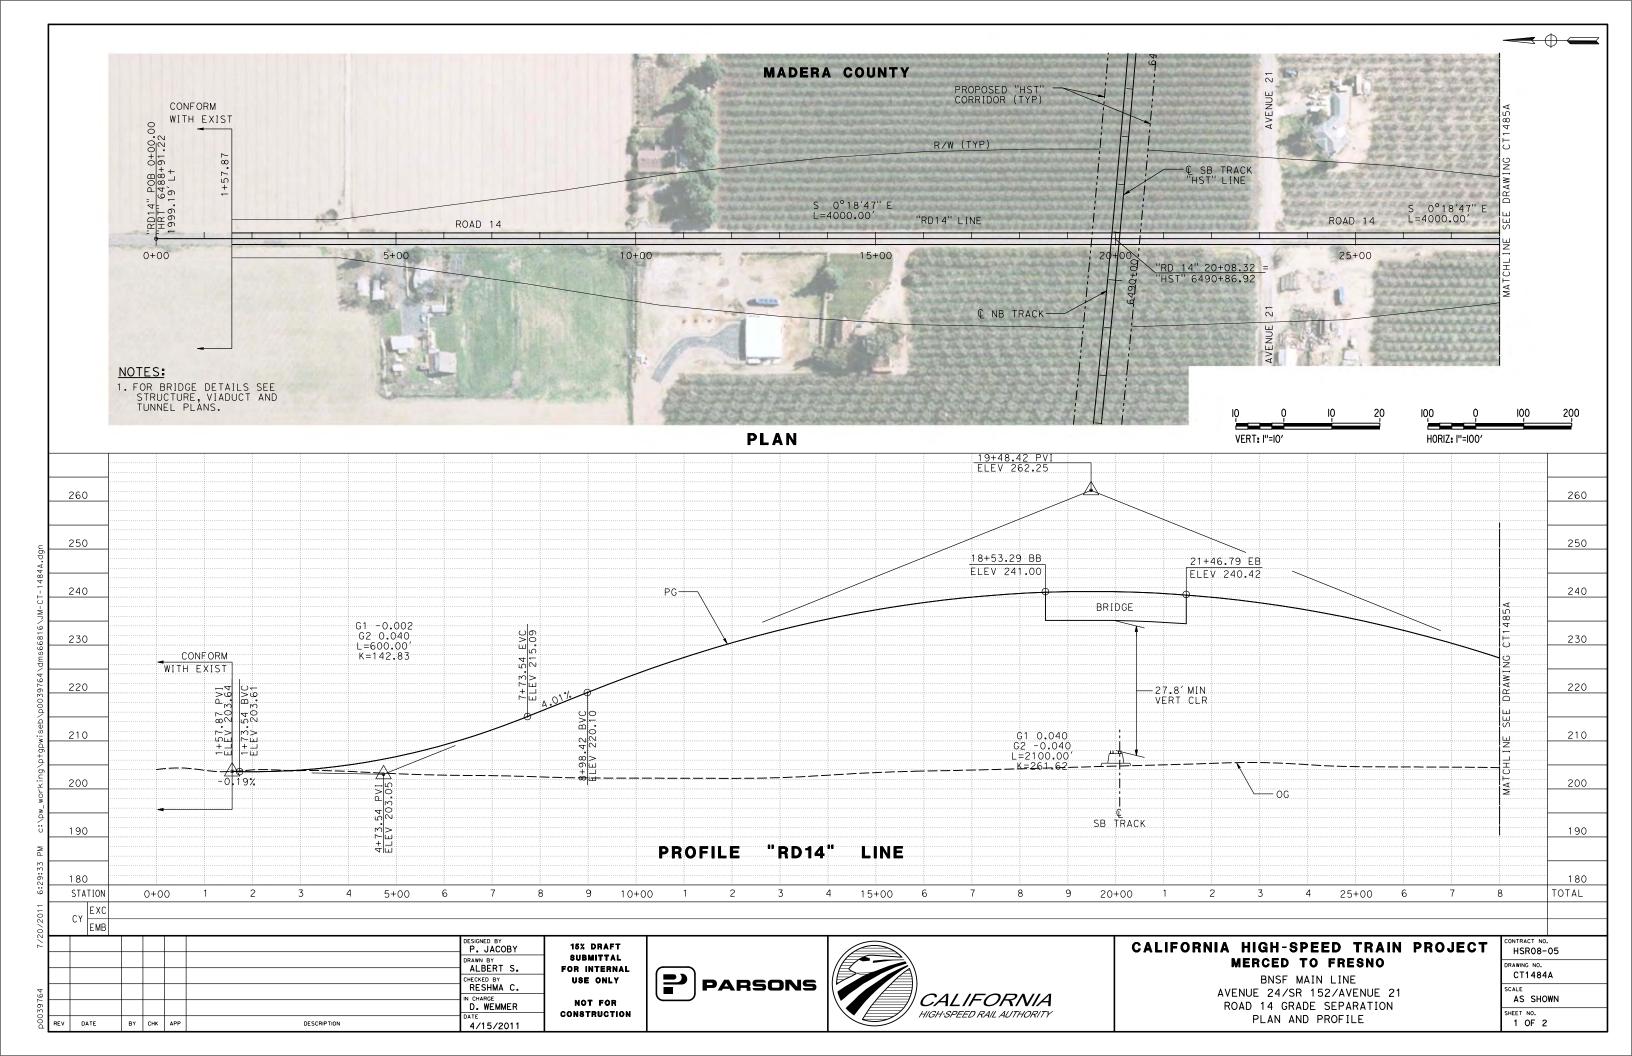
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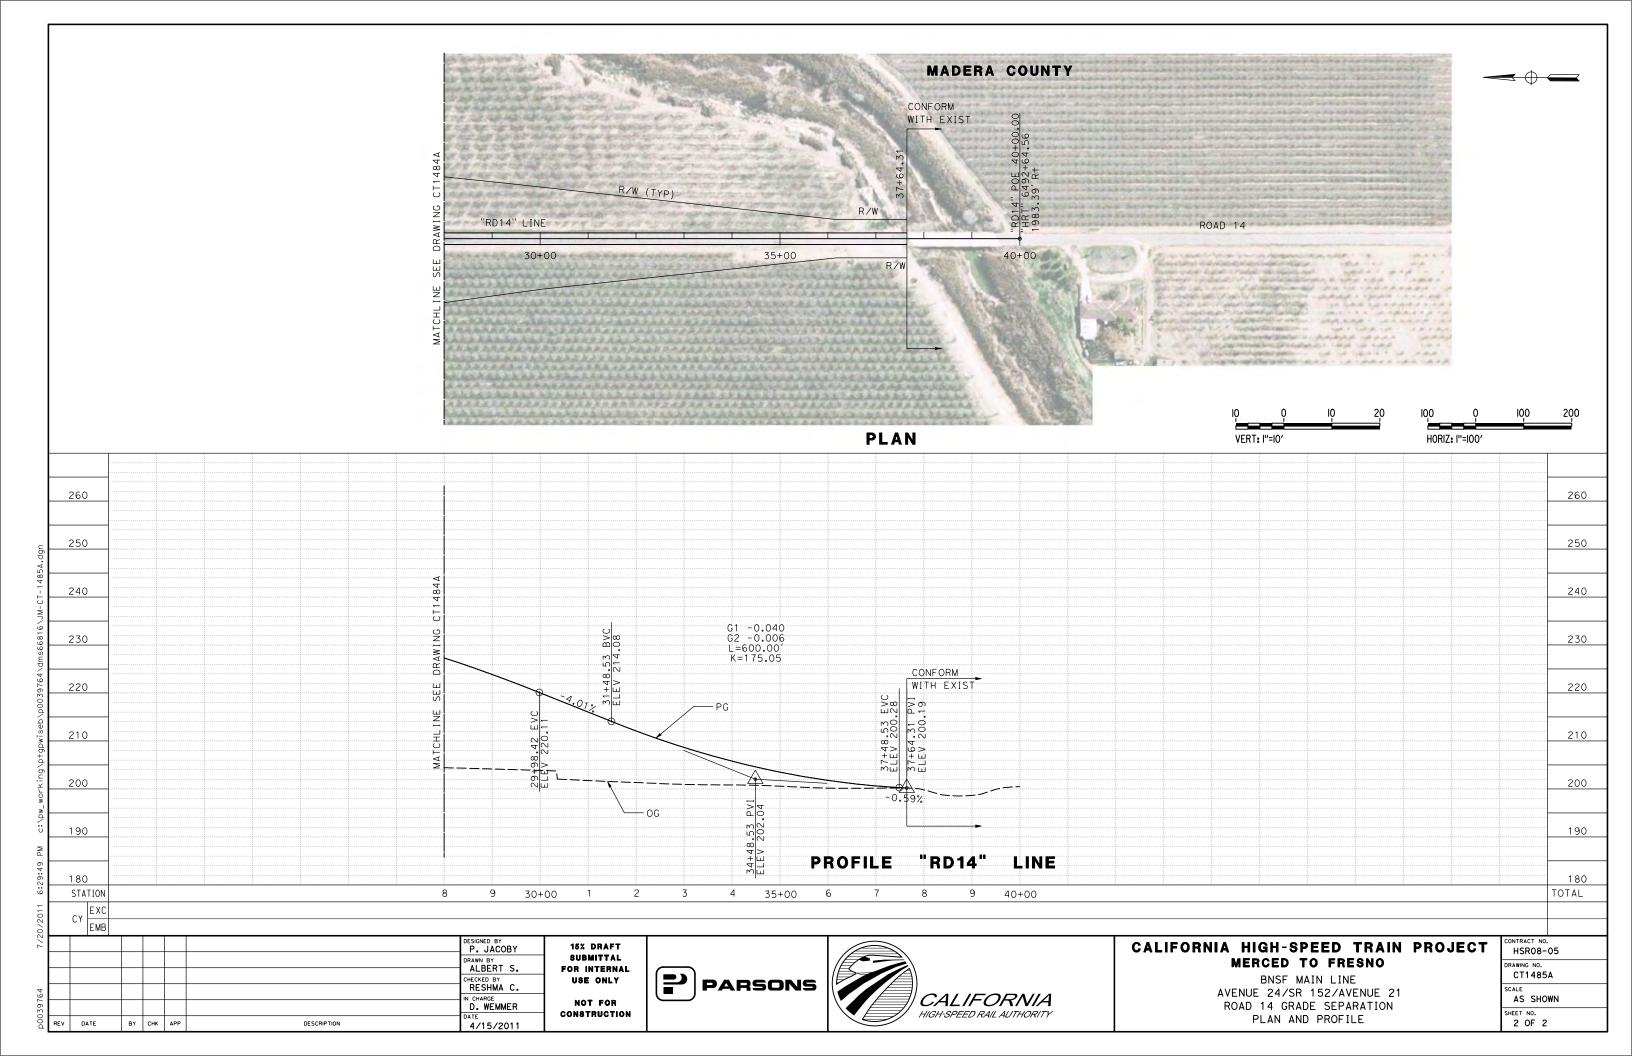











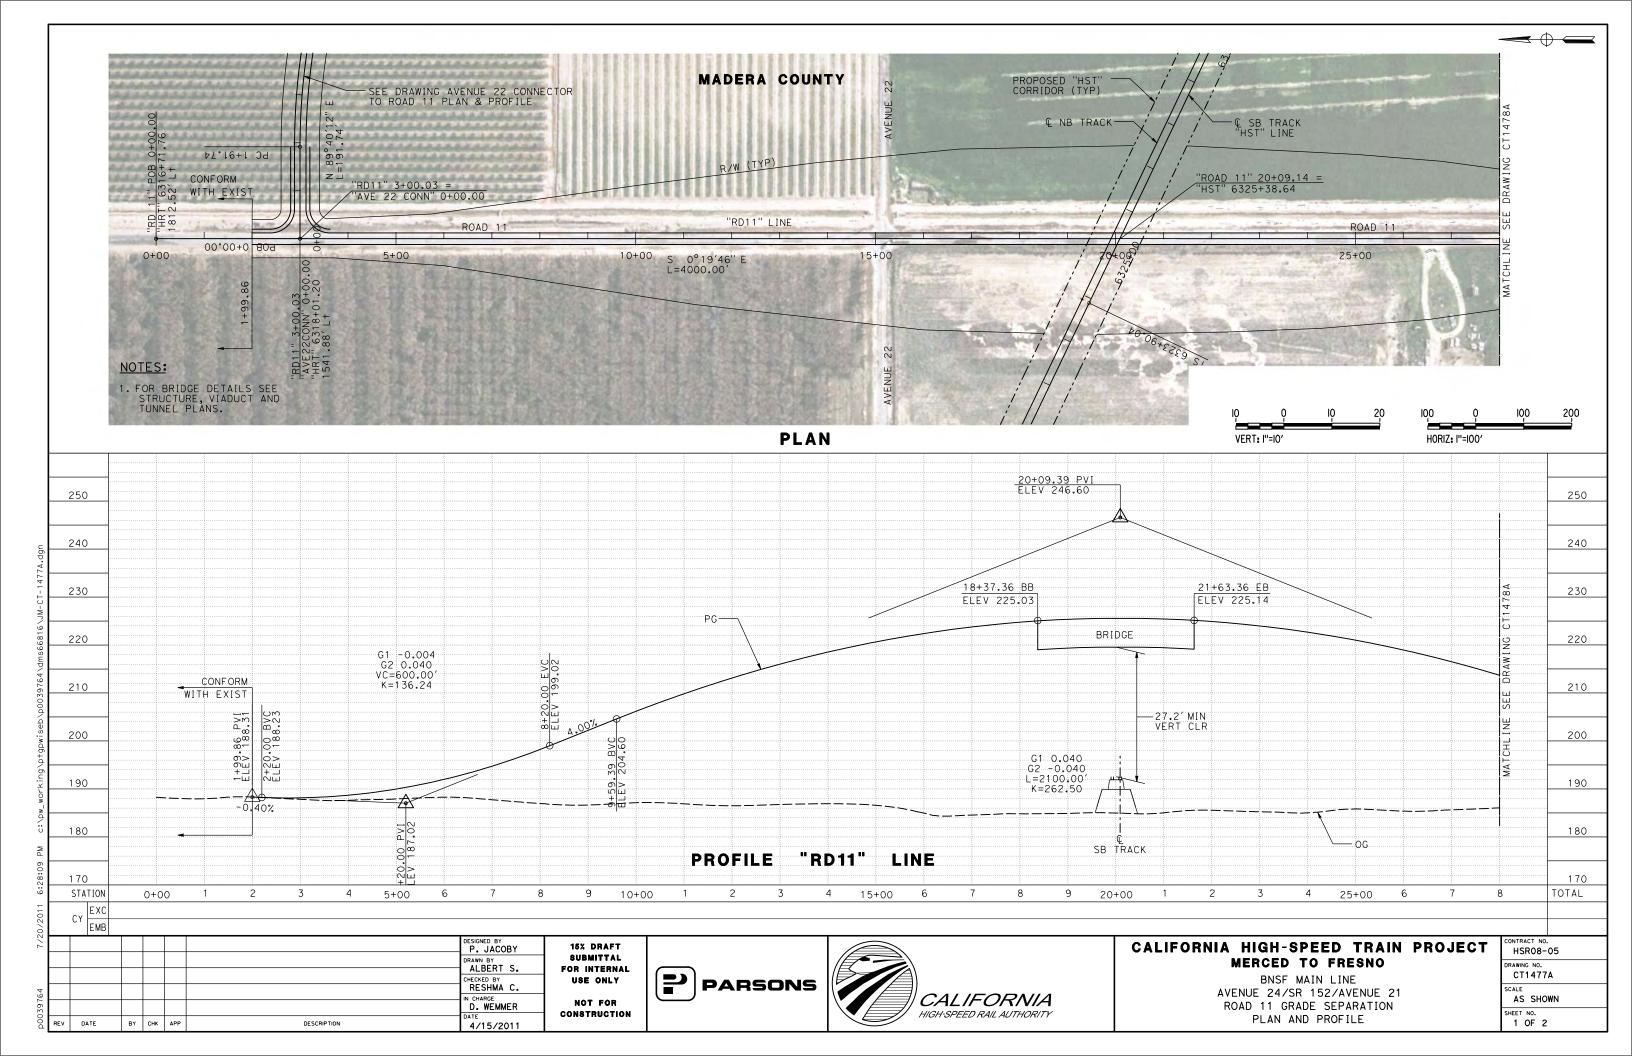


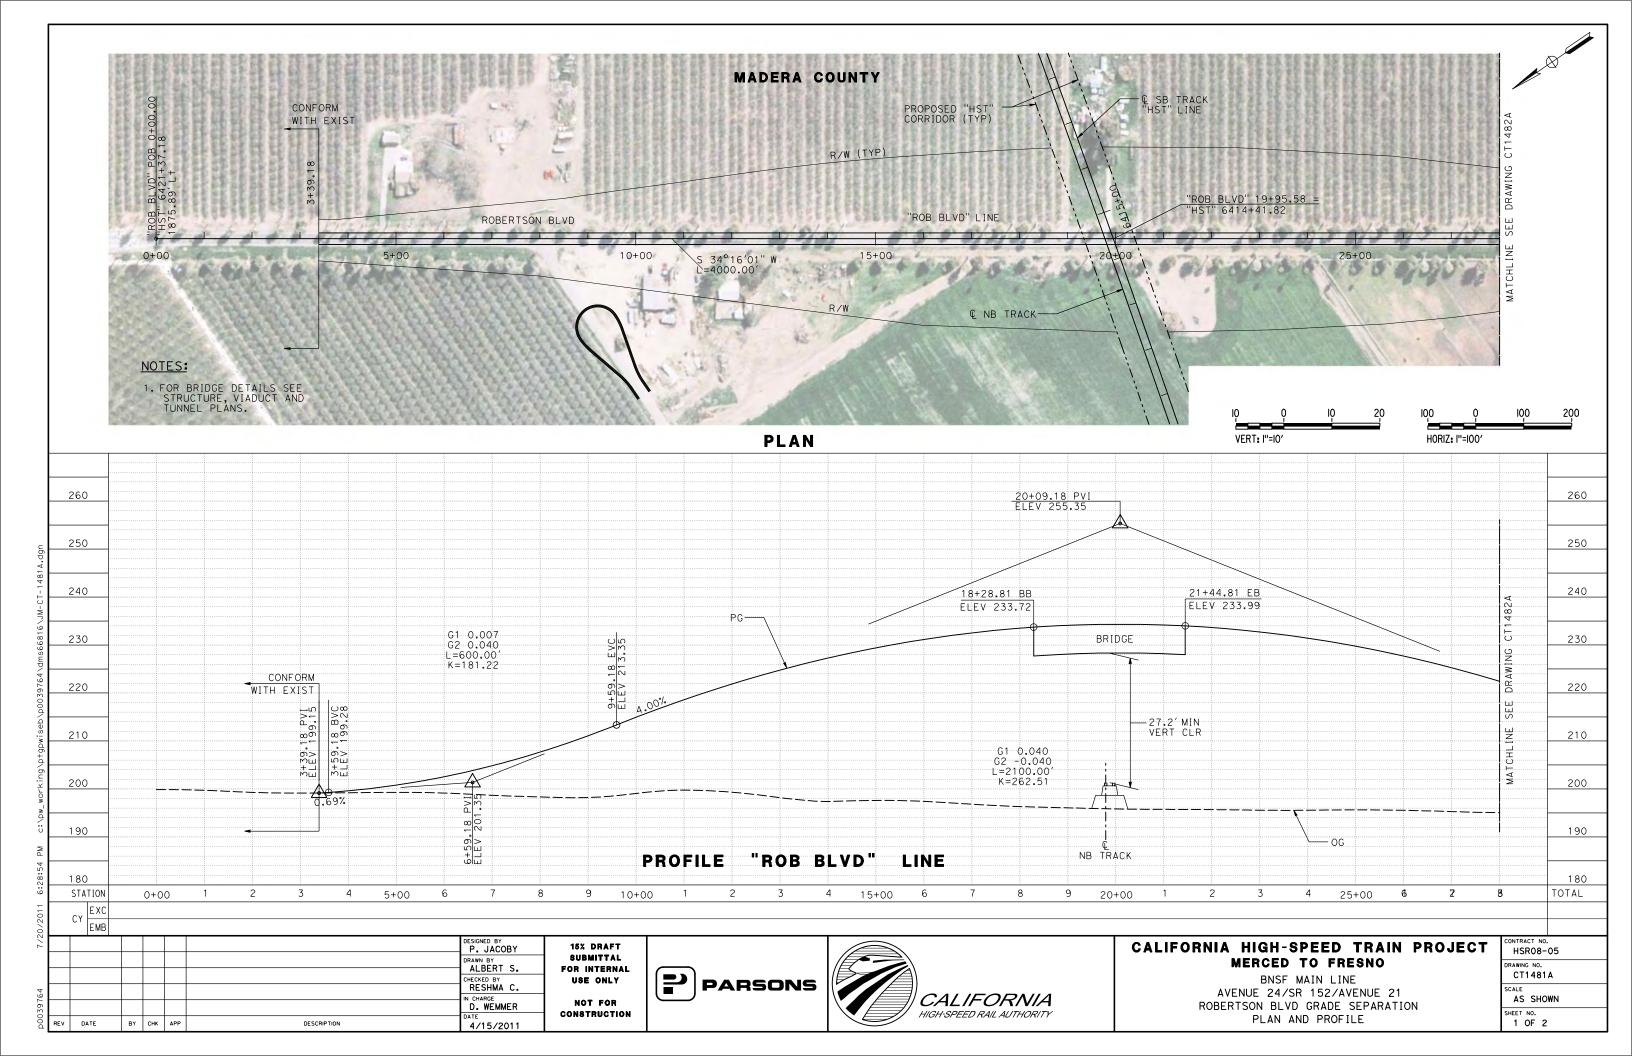


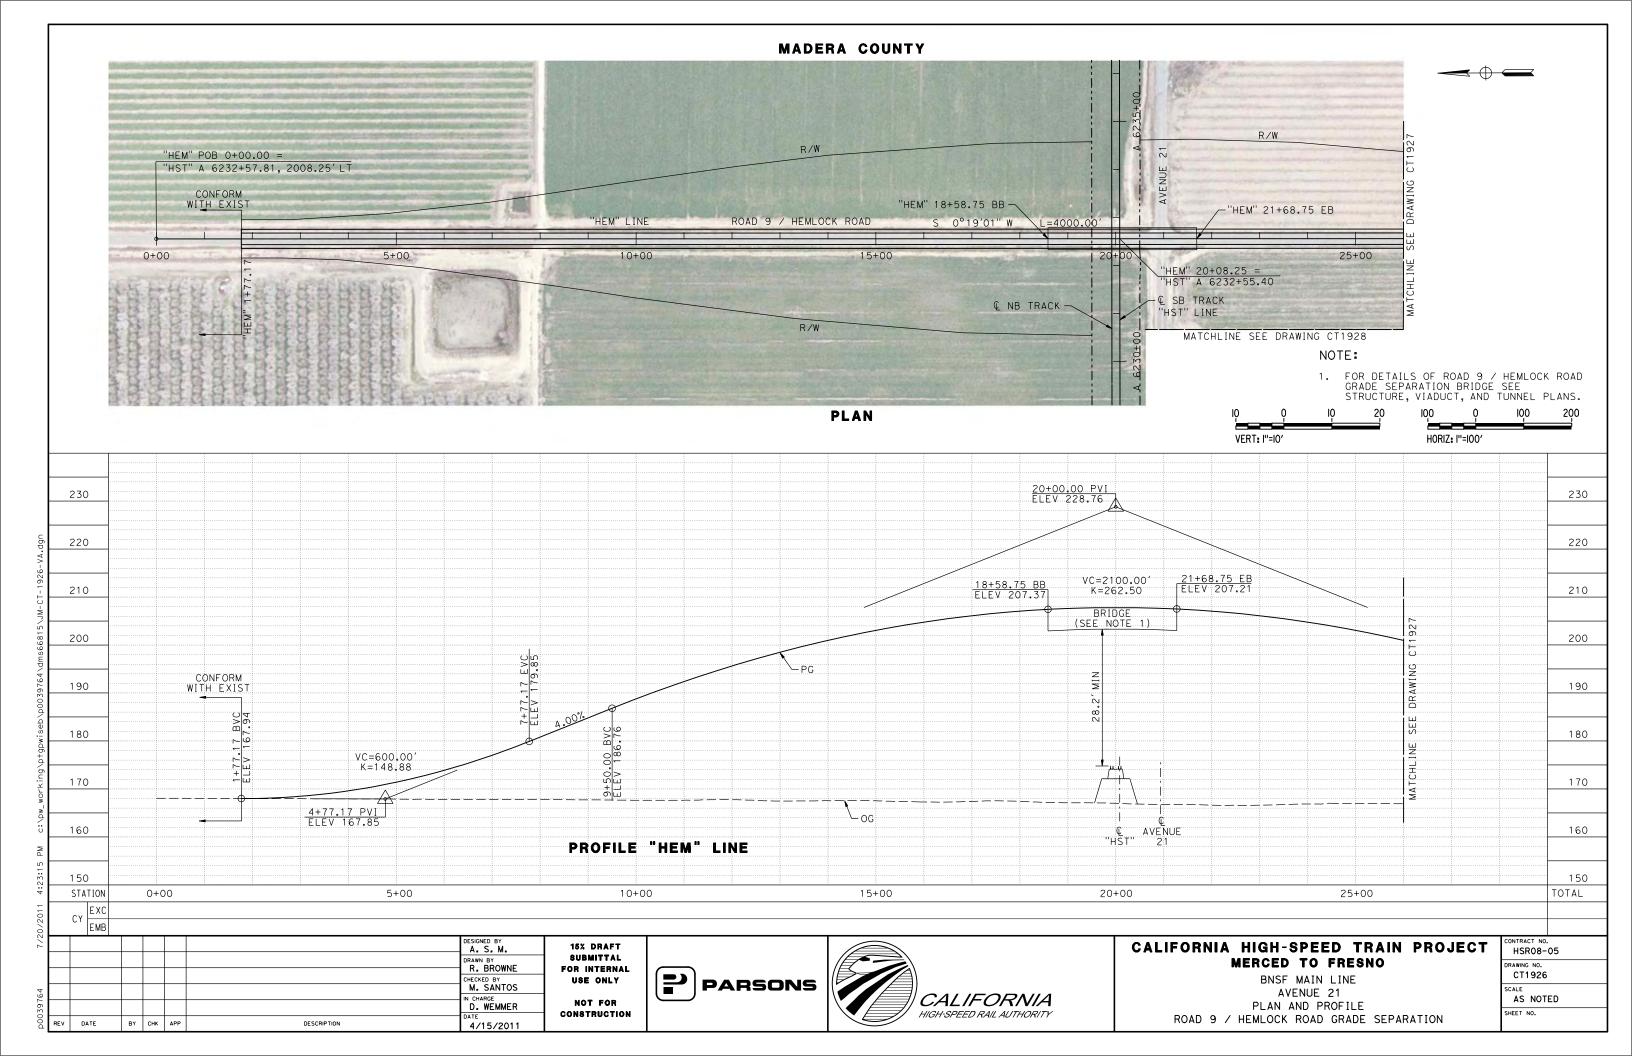


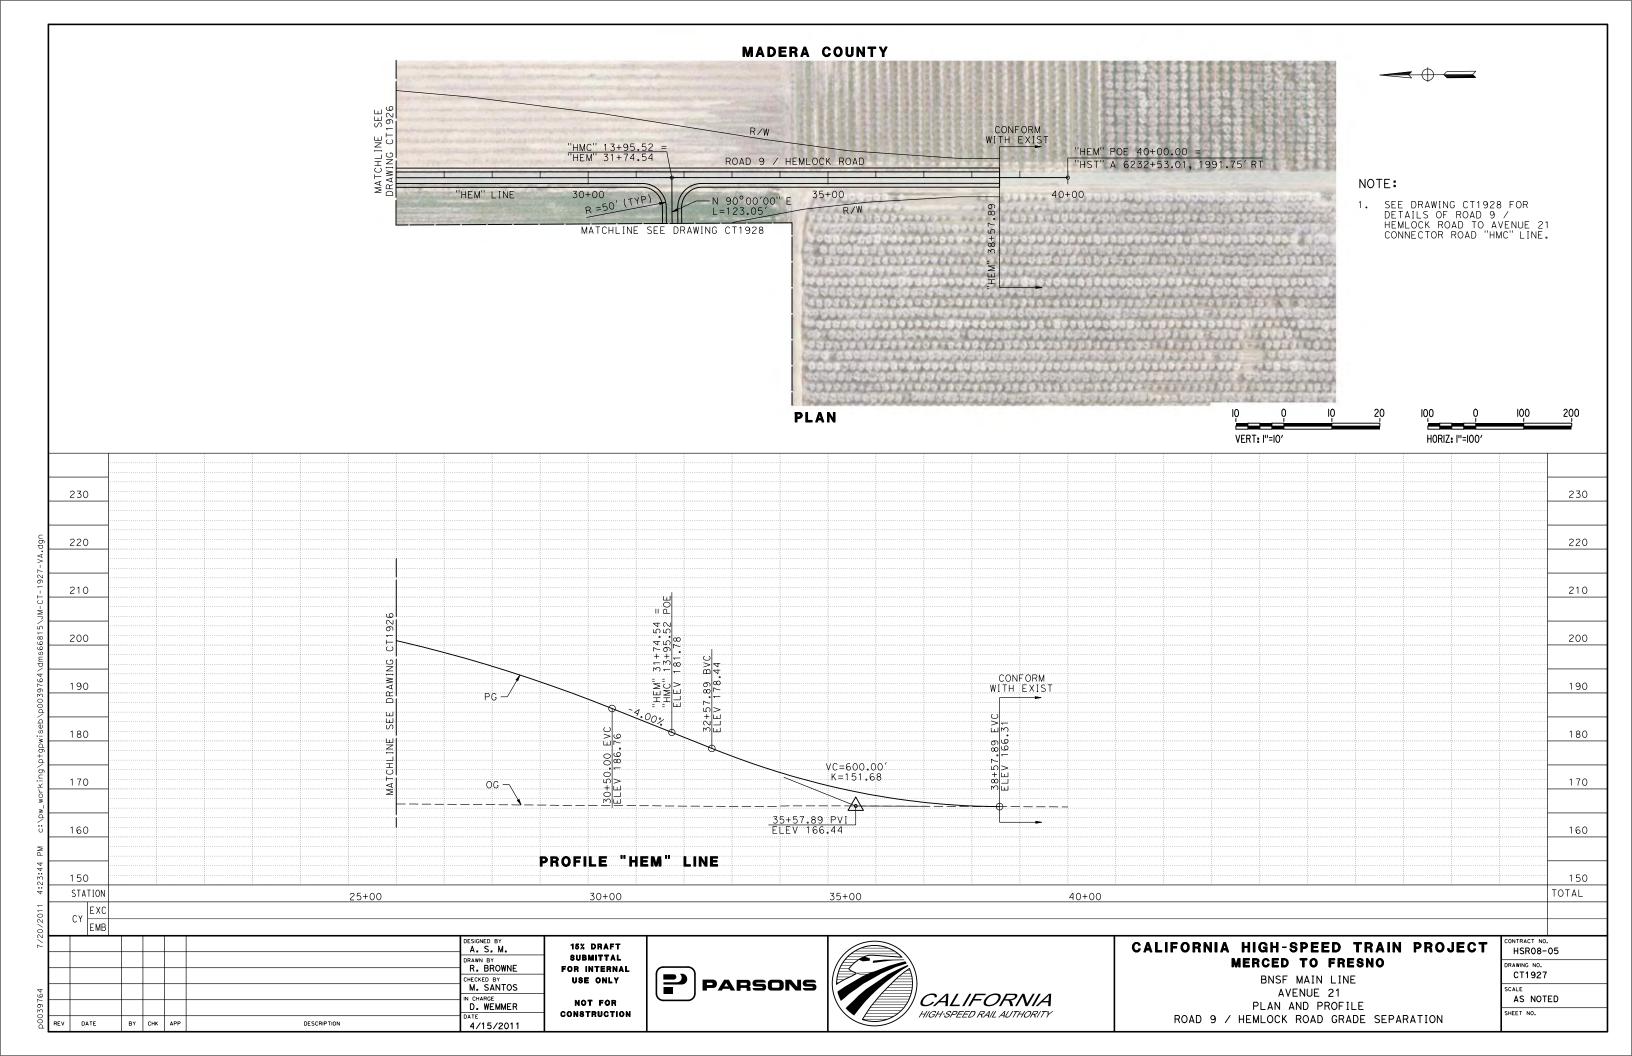


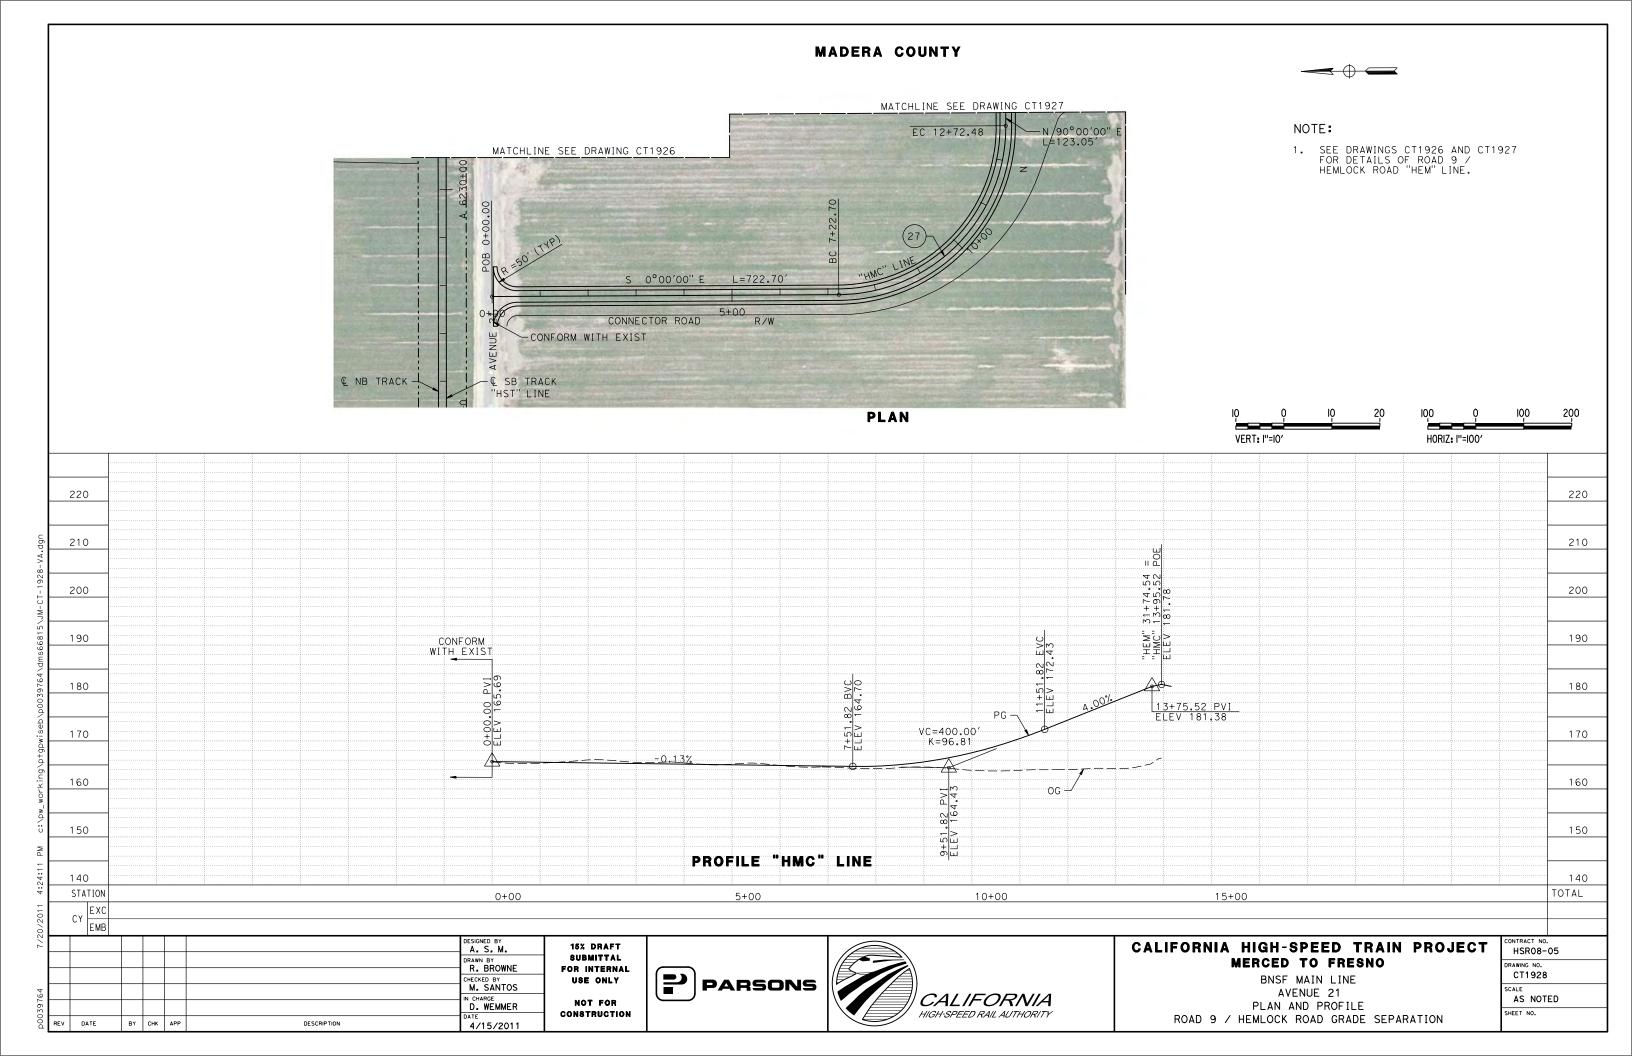


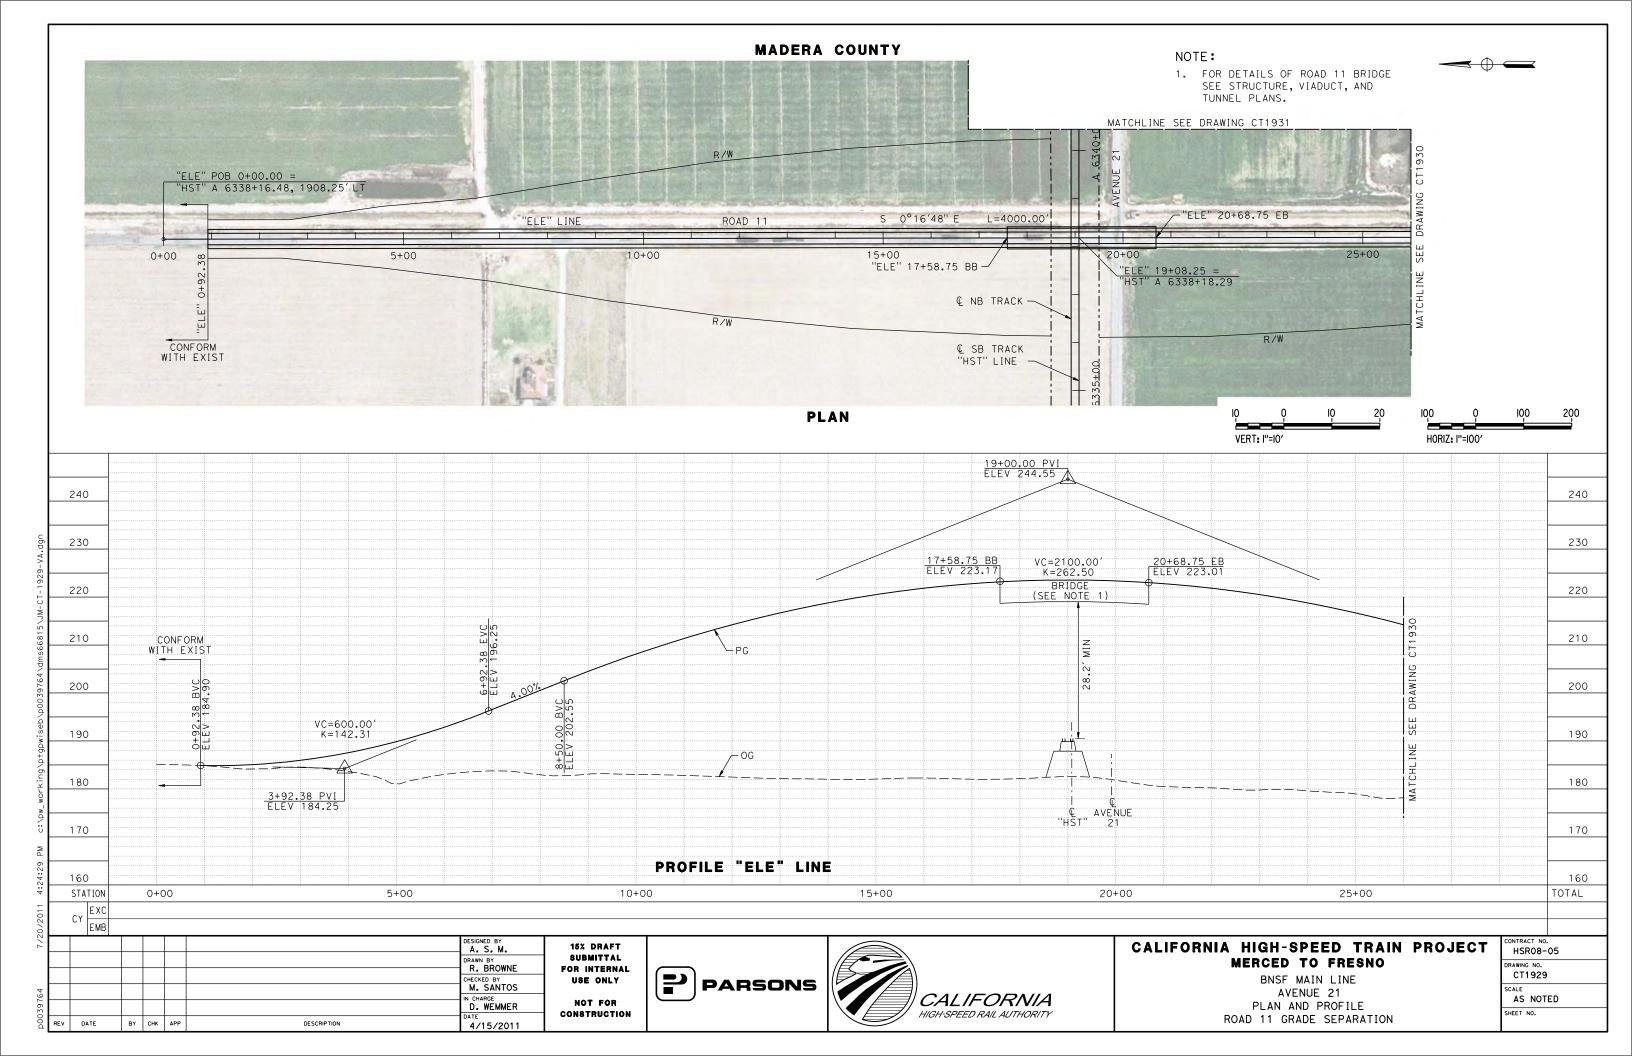


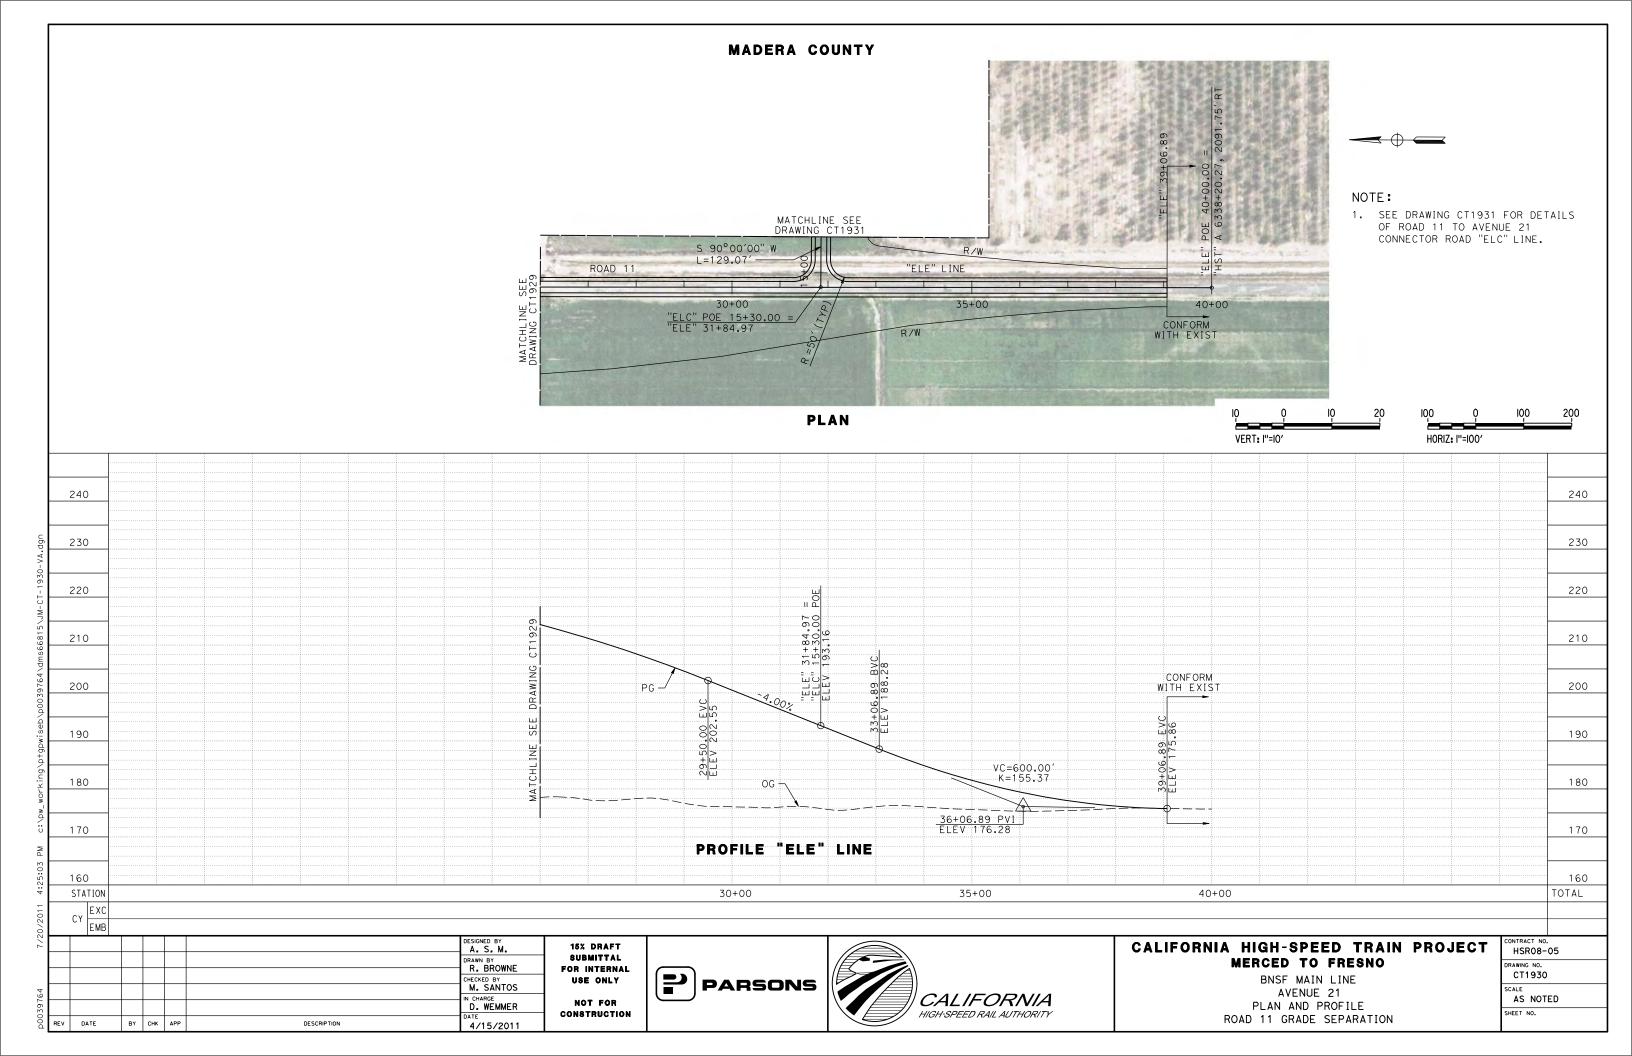


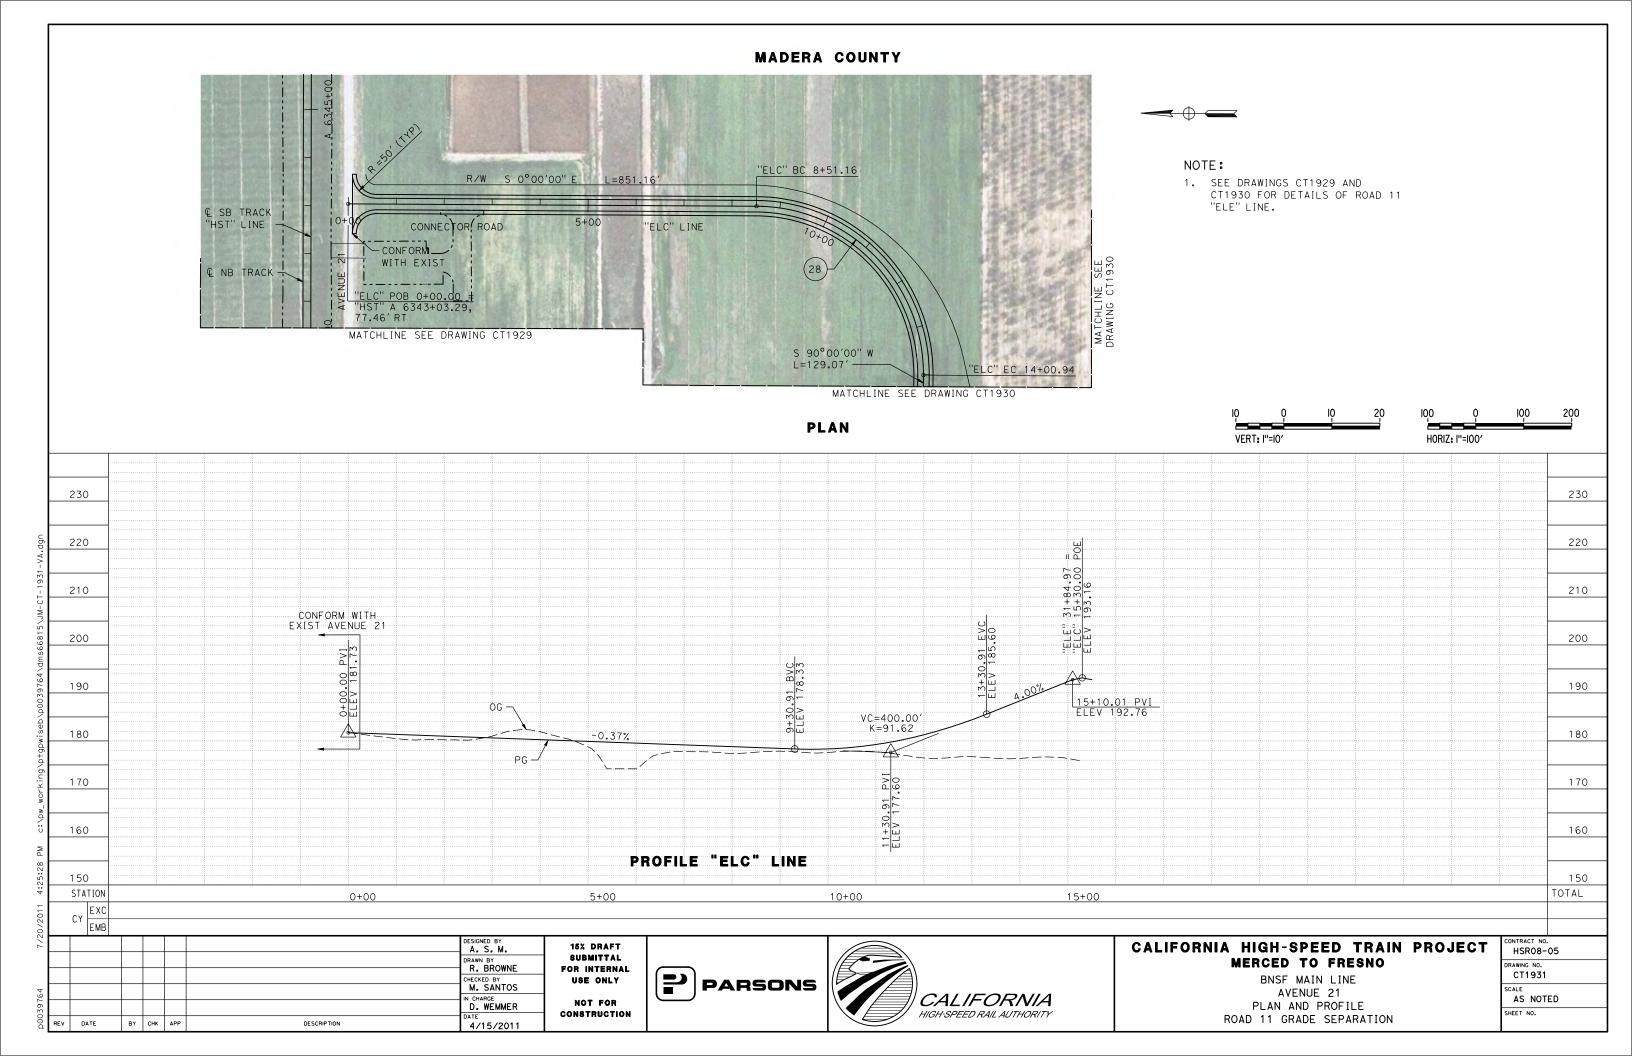


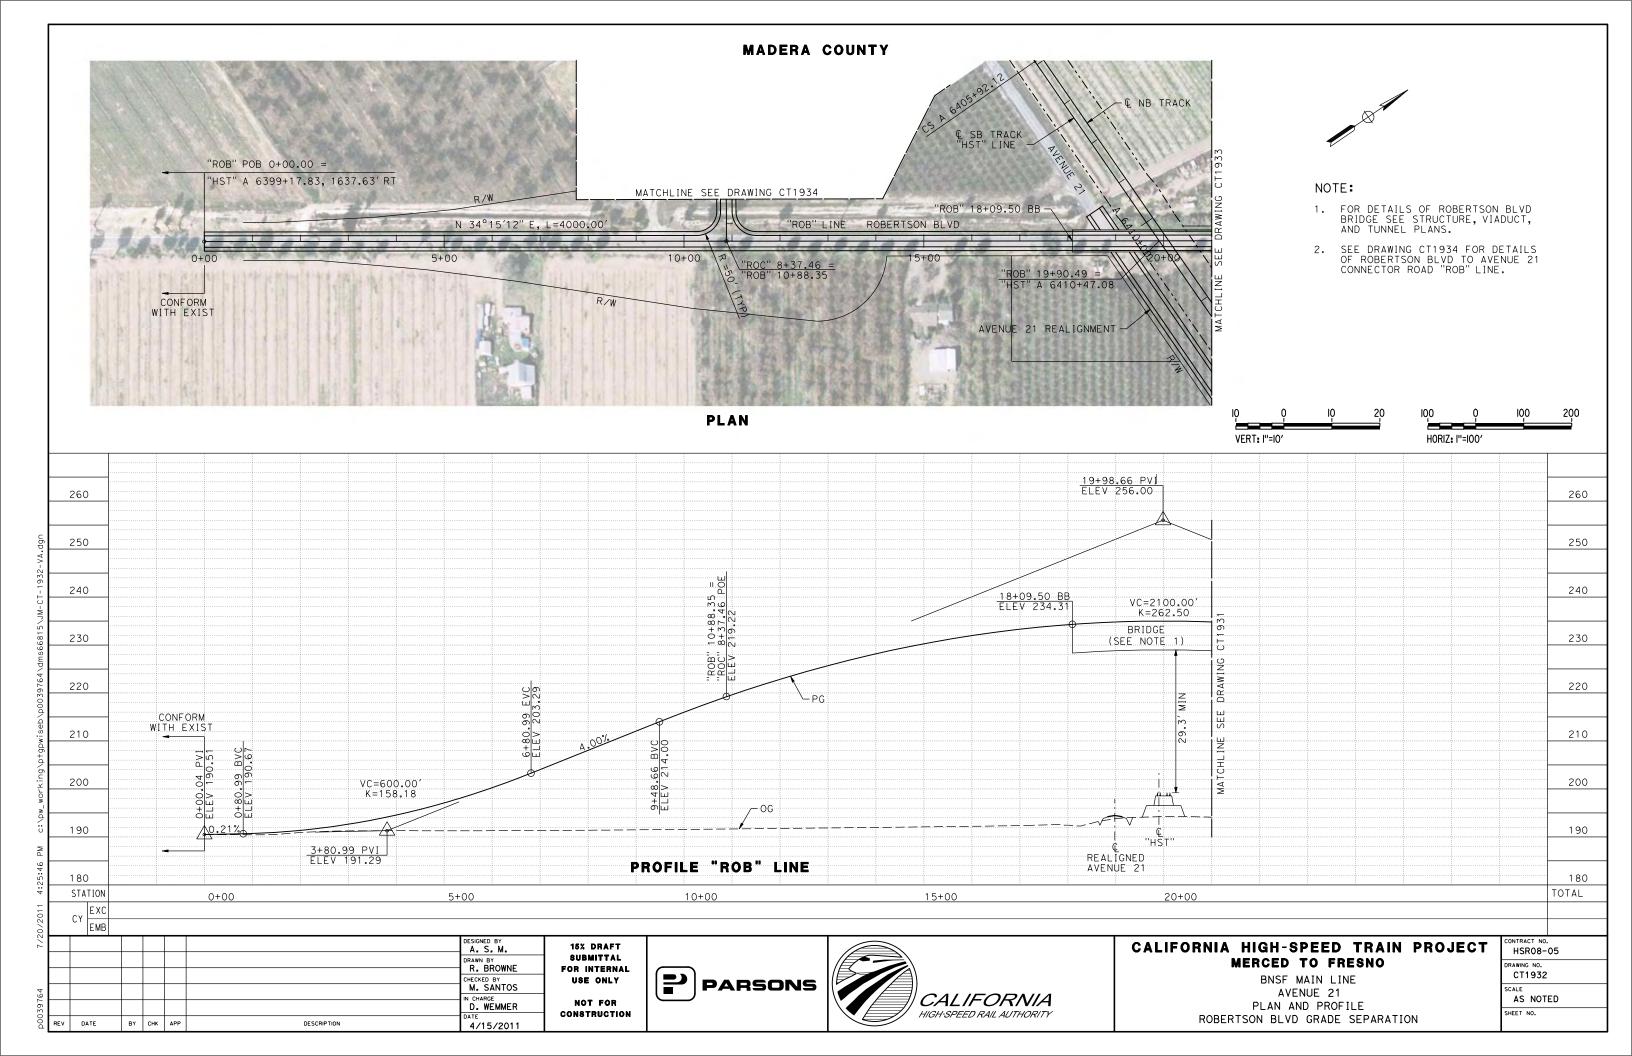


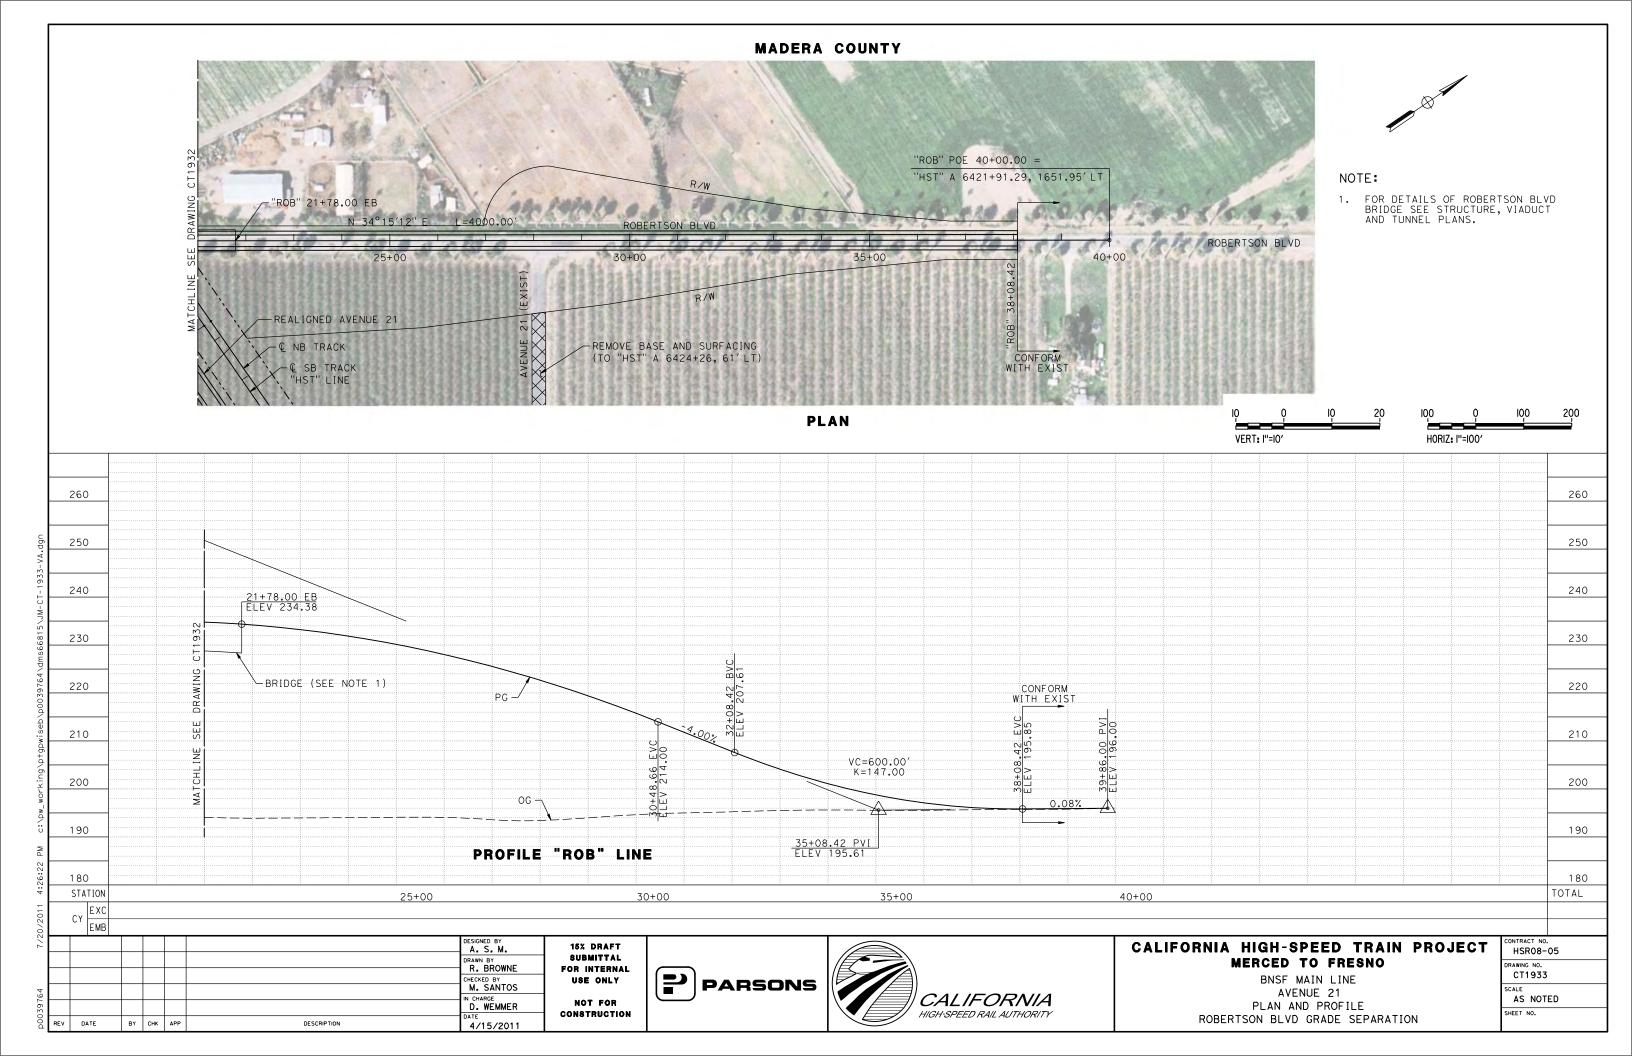

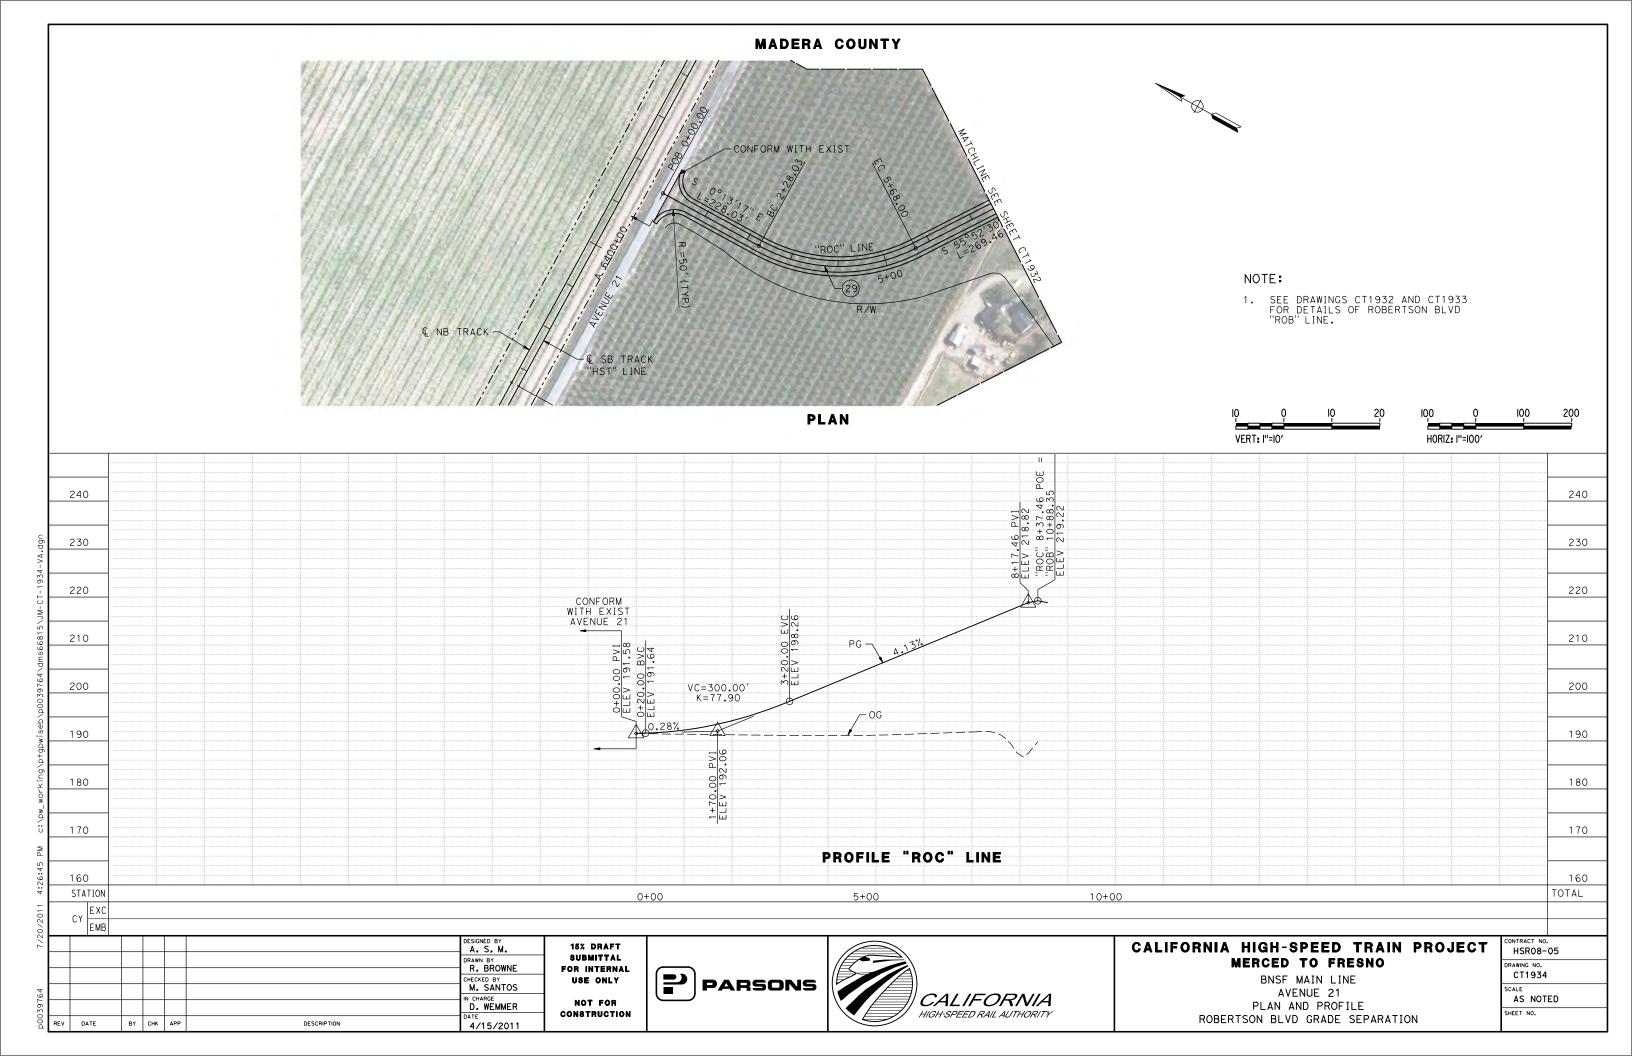

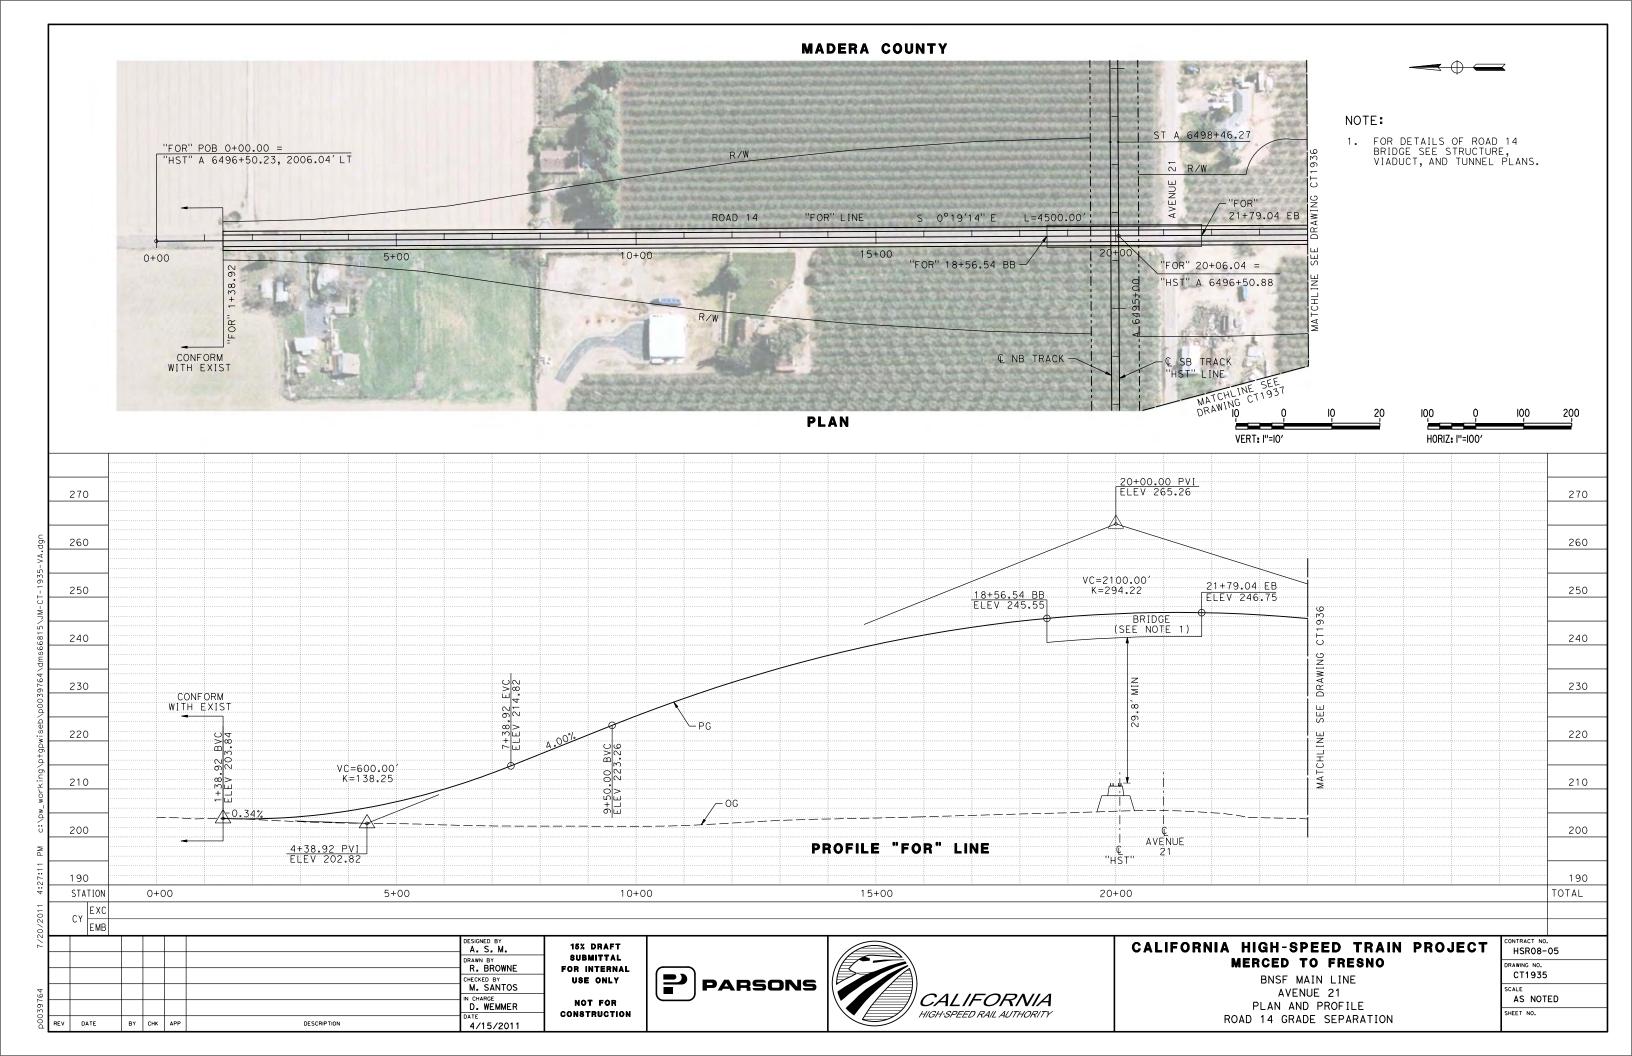

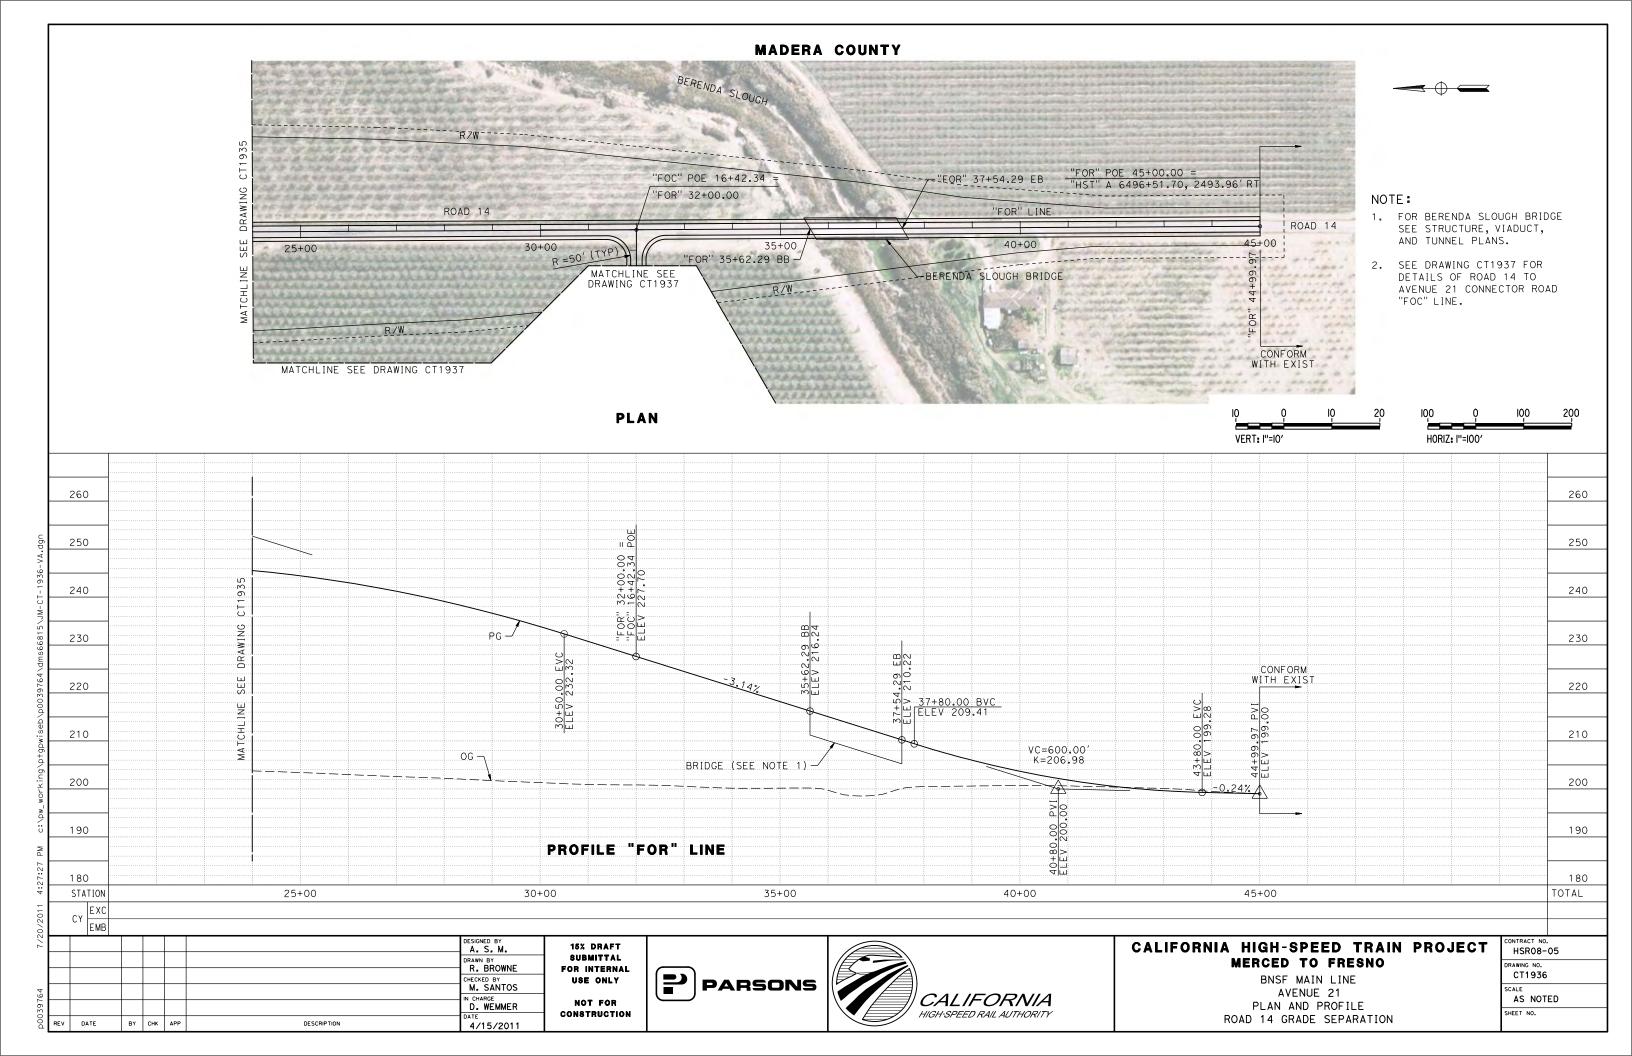

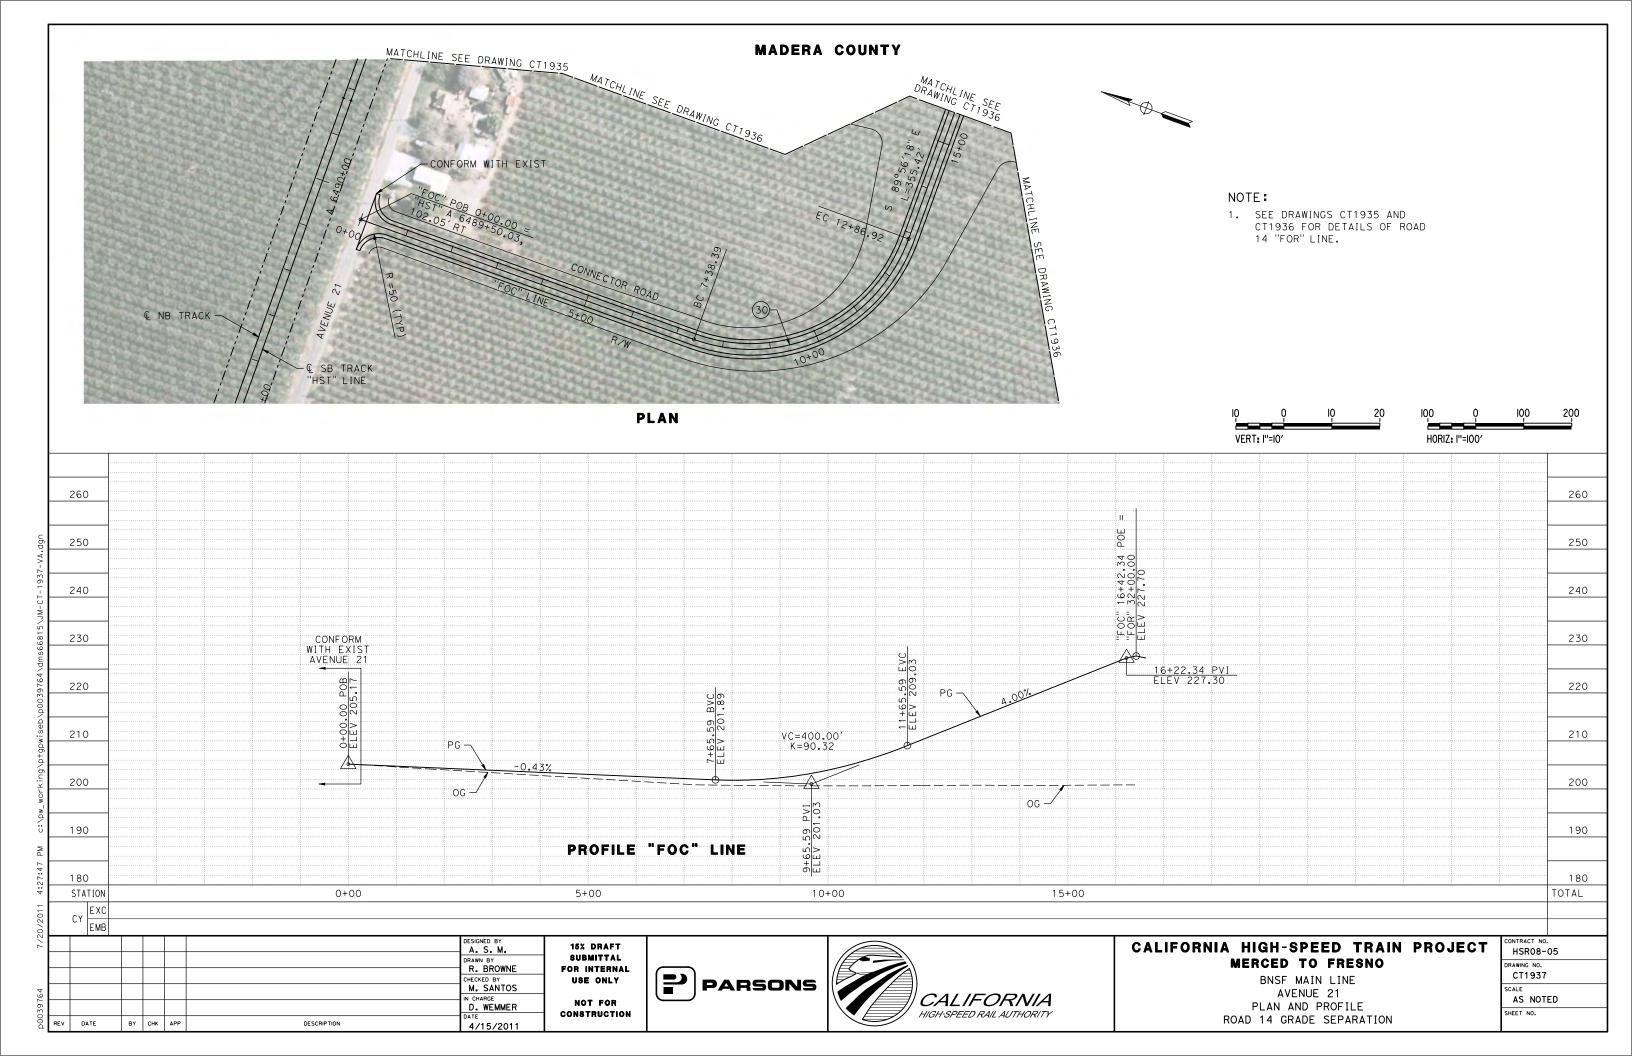

SHT DWG NO. NO. DRAWING TITLE LINE 3

	ROADWAY	BRIDGE	STRUCTURE PLAN	
	HYBRID	ALTERNA	FIVE/AVENUE 21	
		GEN	ERAL	
SB1501	HYBRID ALTERNATIVE	AVENUE 21	INDEX OF DRAWINGS	SHEET 1 OF 1
SB1502	HYBRID ALTERNATIVE	AVENUE 21	STRUCTURE INDEX MAP	SHEET 1 OF 1
		OVERHEAD	D BRIDGES	
ST1070	BNSF MAIN LINE - HYBRID	AVENUE 24	AVENUE 7 OVERHEAD	PLANNING STUDY
	BNSF MAIN LINE - HYBRID	AVENUE 24	AVENUE 9 OVERHEAD	PLANNING STUDY
	BNSF MAIN LINE - HYBRID	AVENUE 24	AVENUE 10 OVERHEAD	PLANNING STUDY
ST1003	BNSF MAIN LINE - HYBRID	AVENUE 24	AVENUE 11 OVERHEAD	PLANNING STUDY
ST1004	BNSF MAIN LINE - HYBRID	AVENUE 24	AVENUE 12 OVERHEAD	PLANNING STUDY
	BNSF MAIN LINE - HYBRID	AVENUE 24	AVENUE 13 OVERHEAD	PLANNING STUDY-SHEET 1 (
ST1005A	BNSF MAIN LINE - HYBRID	AVENUE 24	AVENUE 13 OVERHEAD	PLANNING STUDY-SHEET 2 C
	BNSF MAIN LINE - HYBRID	AVENUE 24	AVENUE 15 OVERHEAD	PLANNING STUDY
	BNSF MAIN LINE - HYBRID	AVENUE 24	AVENUE 151/2 OVERHEAD	PLANNING STUDY
	BNSF MAIN LINE - HYBRID	AVENUE 24	AVENUE 17 OVERHEAD	PLANNING STUDY
	BNSF MAIN LINE - HYBRID	AVENUE 24	ROAD 27 OVERHEAD	PLANNING STUDY
	HYBRID MAIN LINE	AVENUE 24	ROAD 26 OVERHEAD	PLANNING STUDY
	HYBRID MAIN LINE	AVENUE 21	AVENUE 20 OVERHEAD	PLANNING STUDY
	HYBRID MAIN LINE	AVENUE 21	AVENUE 201/20VERHEAD	PLANNING STUDY
	BNSF MAIN LINE - HYBRID	AVENUE 21	ROAD 22 OVERHEAD	PLANNING STUDY
	BNSF MAIN LINE - HYBRID	AVENUE 21	ROAD 20 OVERHEAD	PLANNING STUDY
	BNSF MAIN LINE - HYBRID	AVENUE 21	ROAD 181/2 OVERHEAD	PLANNING STUDY
	BNSF MAIN LINE - HYBRID	AVENUE 21	ROAD 171/2 OVERHEAD	PLANNING STUDY-SHEET 1 (
	BNSF MAIN LINE / UPRR/SR 99 WYE CONNECTION - HYBRID	AVENUE 21	ROAD 16 OVERHEAD G STREET OVERHEAD	PLANNING STUDY
	UPRR/SR 99 MERCED CONNECTION - HYBRID			PLANNING STUDY
	UPRR/SR 99 WYE CONNECTION - HYBRID UPRR/SR 99 WYE CONNECTION - HYBRID	AVENUE 21 AVENUE 21	AVENUE 22 OVERHEAD AVENUE 21½ OVERHEAD	PLANNING STUDY PLANNING STUDY
	UPRR/SR 99 WYE CONNECTION - HYBRID	AVENUE 21	ROAD 17½ OVERHEAD	PLANNING STUDY-SHEET 2 (
311103	OFFICE OF THE CONNECTION - HIBRID	AVENUE ZI	ROAD 1172 OVERHEAD	FLANNING STUDT-SHEET 2 C

DRAWING TITLE LINE 4 SHEET TITLE LINE 5 SHEET TITLE LINE 6

DSO _	2	02/24/12		-	AB		B. Dolan CHECKED BY J. Renteria IN CHARGE	1
ב ה י	1 REV	12/28/11 DATE	HL BY	E C снк	AB APP	DESCRIPTION	A. Boone DATE 07/27/2011	٩ ا

RECORD SET
15% DESIGN
SUBMITTAL
NOT FOR
CONSTRUCTION





CALIFORNIA HIGH-SPEED TRAIN PROJECT MERCED TO FRESNO


HYBRID ALTERNATIVE AVENUE 21 INDEX OF DRAWINGS SHEET 1 OF 1


CONTRA	ACT NO	•	
	HSR	06-007	
DRAWIN	G NO.		
	S	B1501	
SCALE			
	No	scale	


SHEET NO.

LOCATION NO.	SHEET TITLE	STRUCTURE DWG NO.	ROADWAY DWG NO.
1	GRADE SEPARATION - AVENUE 9	ST1001	CT0001-A - CT0003-A
2	GRADE SEPARATION - AVENUE 10	ST1002	CT0004-A - CT0006-A
3	GRADE SEPARATION - AVENUE 11	ST1003	CT0007-A - CT0009-A
4	GRADE SEPARATION - AVENUE 12	ST1004	CT0010-A - CT0012-A
5	GRADE SEPARATION - AVENUE 13	ST1005 & ST1005A	CT0013-A - CT0016-A
6	GRADE SEPARATION - AVENUE 15	ST1006	CT0017-A - CT0019-A
7	GRADE SEPARATION - AVENUE 151/2	ST1007	CT0020-A - CT0022-A
8	GRADE SEPARATION - RAYMOND RD	ST1008	CT0023-A - CT0025-A
9	GRADE SEPARATION - AVENUE 17	ST1009	CT0026-A - CT0028-A
10	GRADE SEPARATION - ROAD 27	ST1010	CT0029-A - CT0031-A
11	GRADE SEPARATION - ROAD 26	ST1011	CT0032-A - CT0034-A
12	GRADE SEPARATION - ROAD 16	ST1101	CT5000-B - CT5003-B
13	GRADE SEPARATION - ROAD 171/2	ST1102 - ST1103	CT5004-B - CT5007-B
14	GRADE SEPARATION - AVENUE 22	ST1106	CT5016-B - CT5018-B
15	GRADE SEPARATION - AVENUE 211/2	ST1115	CT5019-B - CT5022-B
2 5	GRADE SEPARATION - ROAD 20	ST1026	CT0076-A - CT0078-A
26	GRADE SEPARATION - ROAD 181/2	ST1027	CT0079-A - CT0081-A
64	GRADE SEPARATION - G STREET	ST1180	CT0149-A

LOCATION NO.	SHEET TITLE	STRUCTURE DWG NO.	ROADWAY DWG NO.
65	GRADE SEPARATION - AVENUE 7	ST1070	CT0146-A - CT0148-A
90	GRADE SEPARATION - AVENUE 20	ST1090	CT0066-A - CT0068-A
91	GRADE SEPARATION - AVENUE 201/2	ST1091	CT0069-A - CT0071-A
92	GRADE SEPARATION - ROAD 22	ST1092	CT0073-A - CT0075-A
18	GRADE SEPARATION -	ST1113	CT7034-B - CT7036-B
	SANDY MUSH RD INTERCHANGE		
19	GRADE SEPARATION -	ST1114	CT7037-B - CT7043-B
	LE GRAND RD INTERCHANGE		
43	CALTRANS - AVENUE 8	ST1000	CT2000-A - CT2003-A
6 7	CALTRANS - SR 99	ST1181	

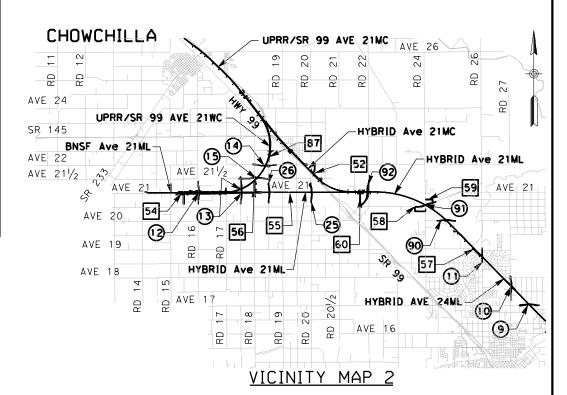

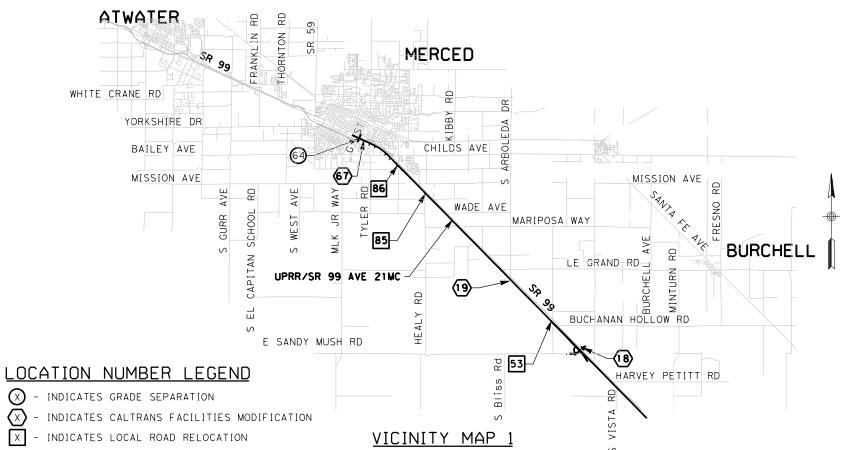

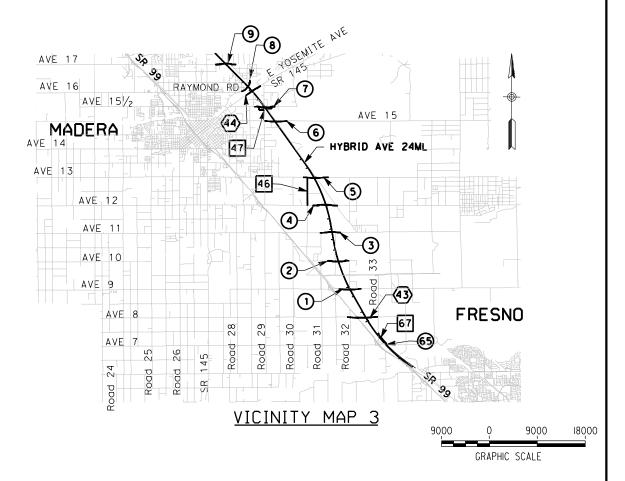

L						<u> </u>
						DESIGNED BY H. Lee DRAWN BY
2	02/24/12	HL	EC	AB		B. Dolan checked by D. Ayele
1	12/28/11		EC	AB		in charge A. Boone
REV	DATE	ВҮ	СНК	APP	DESCRIPTION	DATE 07/27/2011

RECORD SET
15% DESIGN
SUBMITTAL
NOT FOR
CONSTRUCTION

AECOM Technical Services, Inc. 2020 L Street, Suite 300 Sacramento, CA 958II CH2MHILL




CALIFORNIA HIGH-SPEED TRAIN PROJECT MERCED TO FRESNO


MERCED TO FRESNO
HYBRID ALTERNATIVE
AVENUE 21
STRUCTURE INDEX MAP
SHEET 1 OF 1

CONTRACT NO.
HSR06-007
DRAWING NO.
SB1502
SCALE
As shown
SHEET NO.

OF

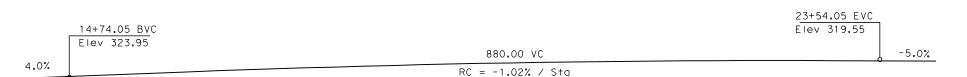


PROFILE GRADE

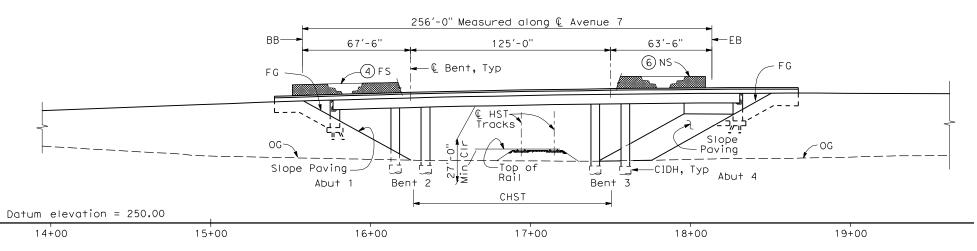

<u>ELEVATION</u> 1" = 30'-0"



PLAN 1" = 30'-0"

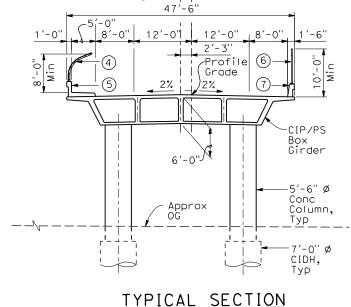

© Bridge → F Avenue 7

TIFICAL SECTI

1"=10'-0"

NOTES:

- 1 Paint "Bridge No. XX-XX"
- 2) Paint "Avenue 7 OH"
- (3) Structure Approach Slab Type N (30S)
- (4) Chain Link Railing Type 3
- (5) Concrete Barrier Type 26 (Mod)
- 6) Chain Link Railing Type 7 (Mod)
- 7) Concrete Barrier Type 732
- 8. Bearing of Avenue 7 to be determined.
- Existing underground and overhead utilities to be determined.

LEGEND:

Direction of traffic

Point of minimum vertical clearance

DATE OF ESTIMATE

BRIDGE REMOVAL =

STRUCTURE DEPTH = 6'-0"

LENGTH = 256'-0"

WIDTH = 47'-6"

AREA = 12,160 f+2

COST/ DFT INCLUDING
10% MOBILIZATION &
25% CONTINGENCY =

TOTAL COST =

LOCATION 65



						DESIGNED BY H. LEE DRAWN BY J. HODELL CHECKED BY	F 1
						L. LEUNG IN CHARGE A. BOONE	C
REV	DATE	BY	СНК	APP	DESCRIPTION	DATE 07/27/2011	

BB 15+59.00

Elev 326.98

RECORD SET
15% DESIGN
SUBMITTAL
NOT FOR
CONSTRUCTION

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2020 L. Street, Suite 300
Sacramento, CA 958II
CH2MHILL



19+00


slope, Typ


CALIFORNIA HIGH-SPEED TRAIN PROJECT MERCED TO FRESNO

BNSF MAIN LINE - HYBRID AVENUE 24 AVENUE 7 OVERHEAD PLANNING STUDY

CONTRACT NO. HSRO6-007
drawing no. ST1070
scale As shown
SHEET NO

OF

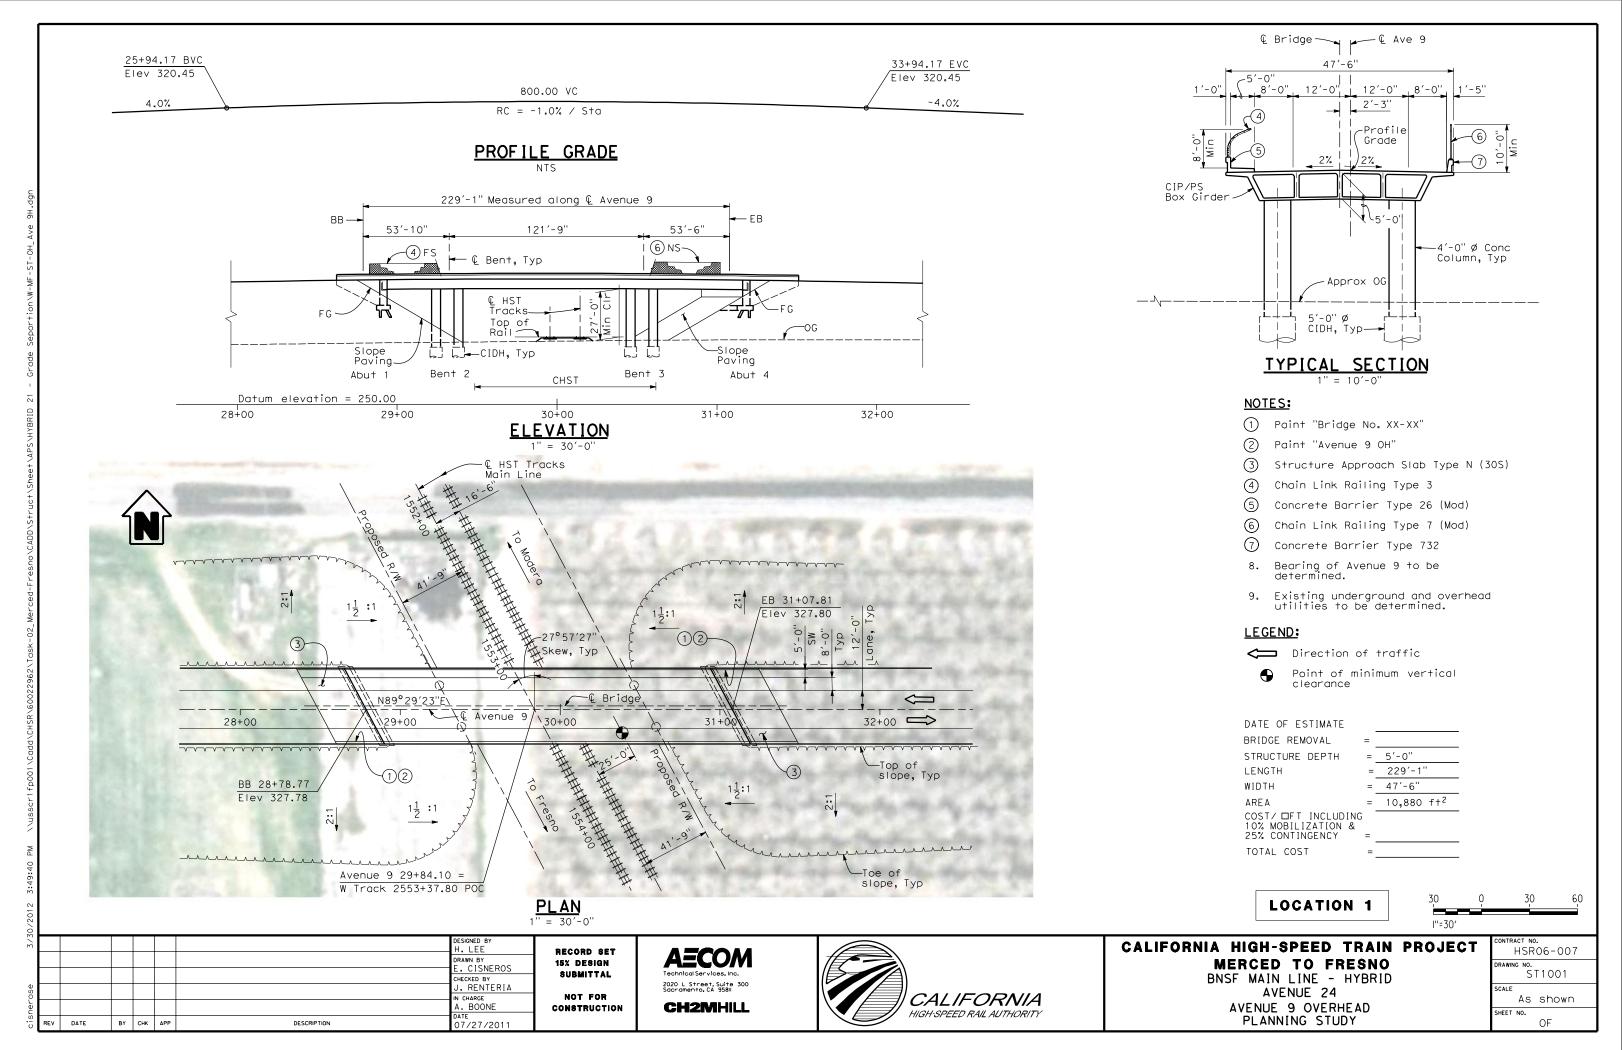

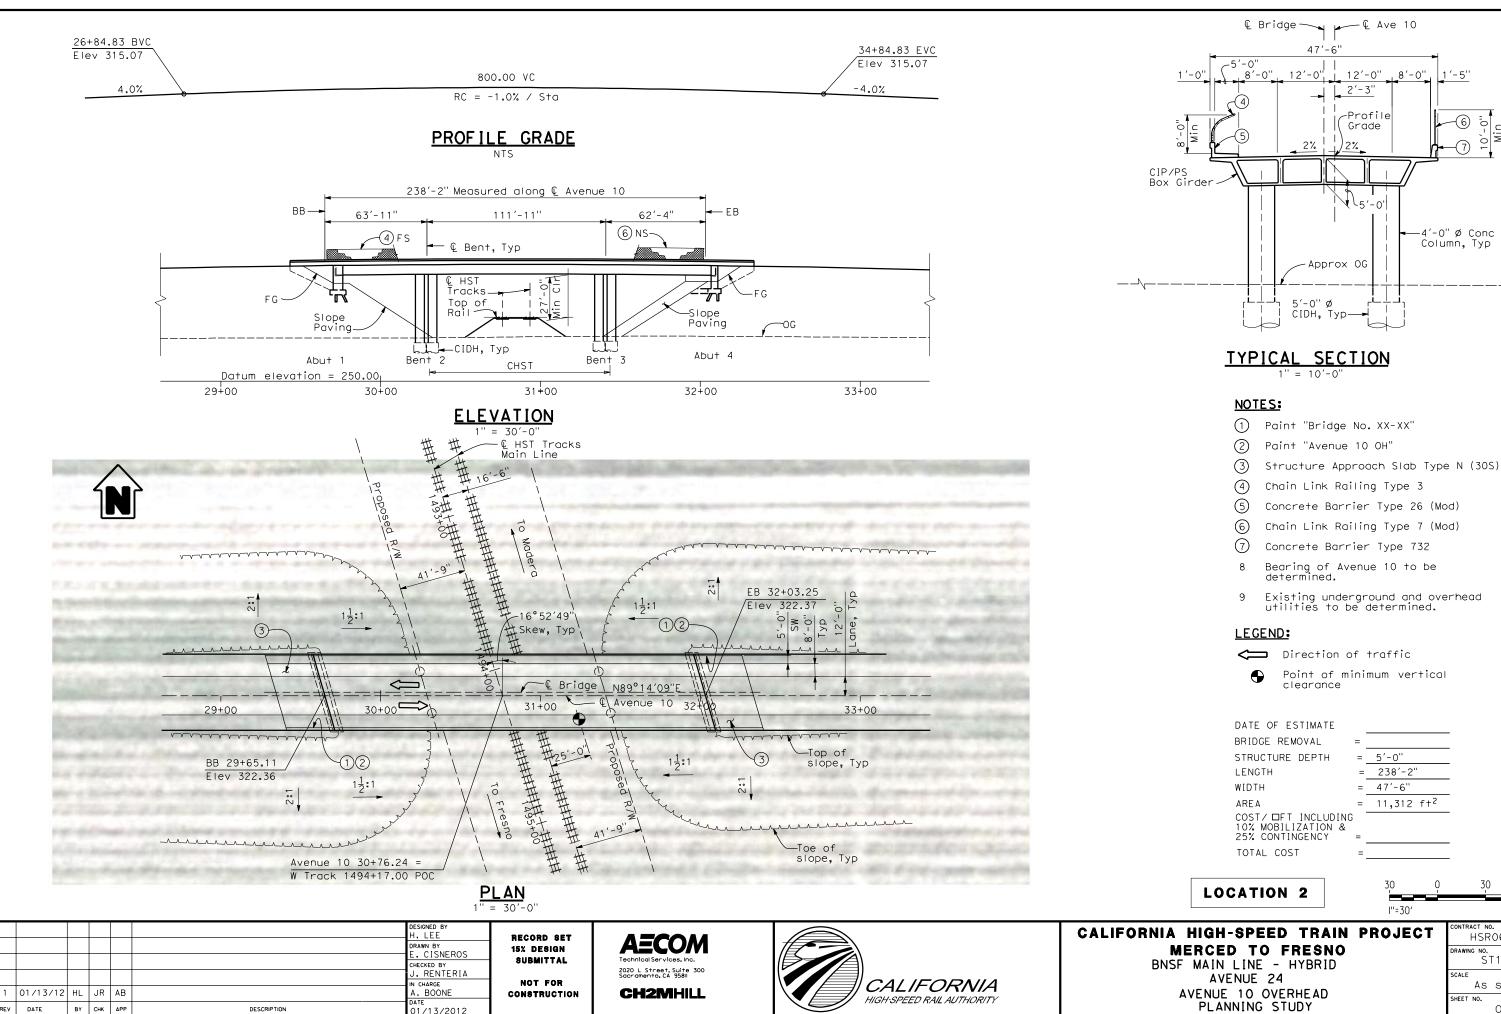

I''=30' HSR06-007


SHEET NO.

ST1002


As shown


-4'-0" Ø Conc Column, Typ

PROFILE GRADE

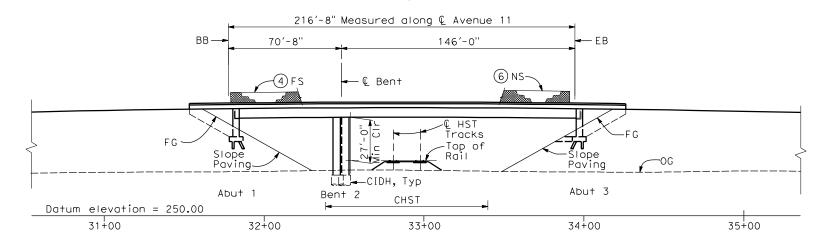

ELEVATION

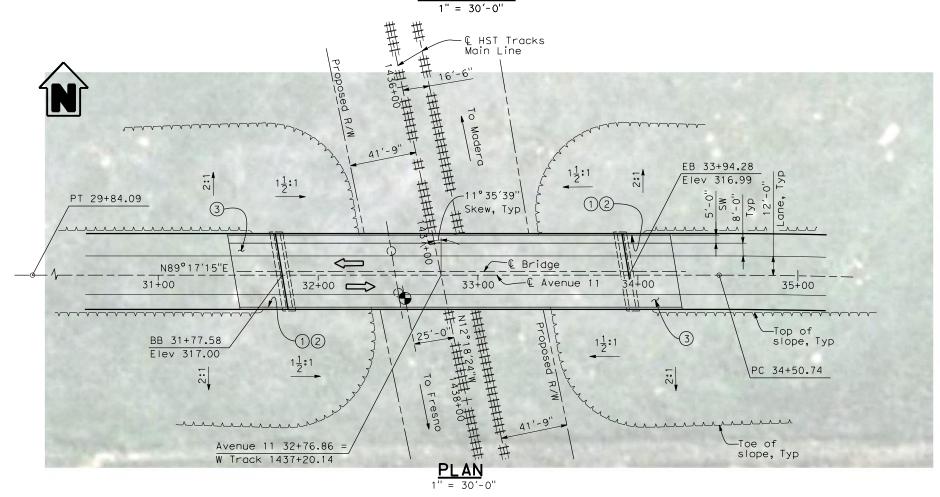

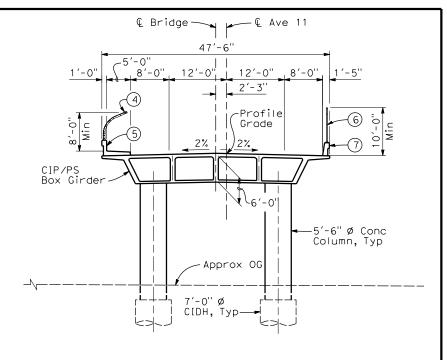

TYPICAL SECTION


NOTES:

- 1) Paint "Bridge No. XX-XX"
- (2) Paint "Avenue 11 OH"
- 3) Structure Approach Slab Type N (30S)
- 4) Chain Link Railing Type 3
- (5) Concrete Barrier Type 26 (Mod)
- 6) Chain Link Railing Type 7 (Mod)
- 7) Concrete Barrier Type 732
- 8 Bearing of Avenue 11 to be determined.
- Existing underground and overhead utilities to be determined.

LEGEND:

Direction of traffic

Point of minimum vertical clearance

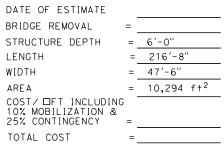

LOCATION 3



						DESIGNED BY H. LEE	
						DRAWN BY E. CISNEROS	1
						CHECKED BY J. RENTERIA	İ
1	01/13/12	HL	JR	AB		IN CHARGE A. BOONE	,
REV	DATE	ВҮ	СНК	APP	DESCRIPTION	DATE 01/13/2012	

RECORD SET
15% DESIGN
SUBMITTAL
NOT FOR
CONSTRUCTION

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Sacramento, CA 95811
CH2MHILL




CALIFORNIA HIGH-SPEED TRAIN PROJECT MERCED TO FRESNO BNSF MAIN LINE - HYBRID

BNSF MAIN LINE - HYBRID AVENUE 24 AVENUE 11 OVERHEAD PLANNING STUDY


CONTRACT NO. HSRO6-007					
DRAWIN	DRAWING NO.				
	ST1003				
SCALE					
	As	shown			
SHEET	NΩ				


OF

PROFILE GRADE

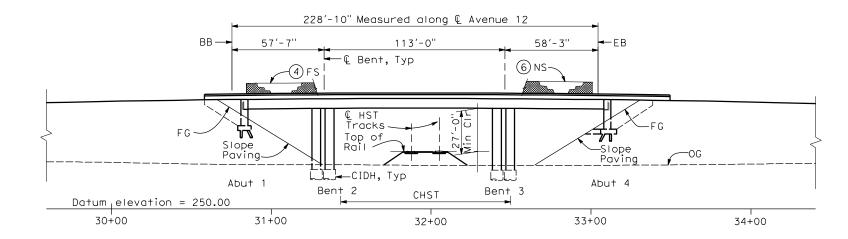

ELEVATION

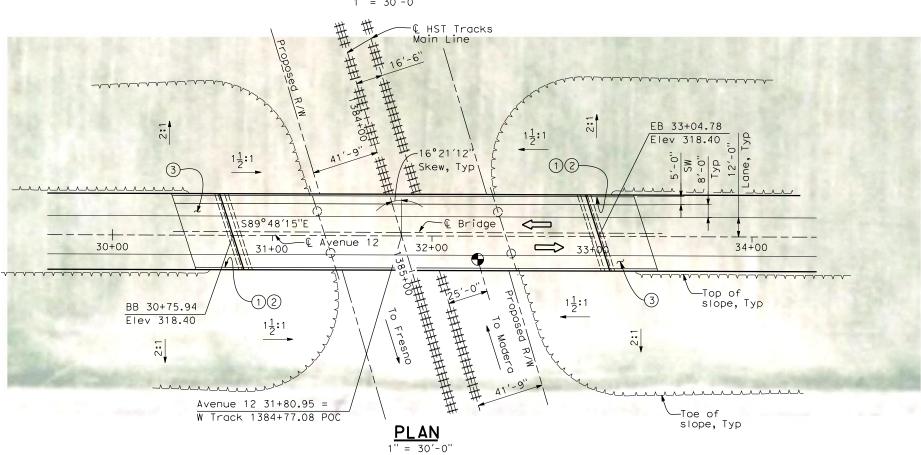

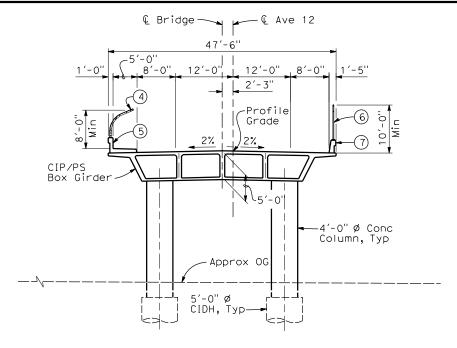

TYPICAL SECTION

NOTES:

- 1) Paint "Bridge No. XX-XX"
- (2) Paint "Avenue 12 OH"
- 3) Structure Approach Slab Type N (30S)
- 4) Chain Link Railing Type 3
- (5) Concrete Barrier Type 26 (Mod)
- 6) Chain Link Railing Type 7 (Mod)
- 7) Concrete Barrier Type 732
- 8 Bearing of Avenue 12 to be determined.
- Existing underground and overhead utilities to be determined.

LEGEND:

Direction of traffic

Point of minimum vertical clearance

DATE OF ESTIMATE

BRIDGE REMOVAL =

STRUCTURE DEPTH = 5'-0"

LENGTH = 228'-10"


WIDTH = 47'-6"

AREA = 10,870 f+2

COST/ □FT INCLUDING
10% MOBILIZATION &
25% CONTINGENCY =

TOTAL COST =

LOCATION 4

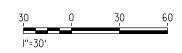

						DESIGNED BY H, LEE	
						DRAWN BY	
						CHECKED BY J. RENTERIA	İ
1	01/13/12	ш	JR	AB		IN CHARGE A. BOONE	١.
REV	DATE	BY	СНК	APP	DESCRIPTION	DATE 01/13/2012	l c

RECORD SET
15% DESIGN
SUBMITTAL
NOT FOR
CONSTRUCTION


AECOM
Technical Services, inc.
2020 L Street, Suite 300
Sacramento, CA 958II
CH2MHILL




CALIFORNIA HIGH-SPEED TRAIN PROJECT MERCED TO FRESNO BNSF MAIN LINE - HYBRID

NSF MAIN LINE - HYBRID AVENUE 24 AVENUE 12 OVERHEAD PLANNING STUDY

CONTR	ACI NU	/ <u>.</u>
	HSR	06-007
DRAWIN	G NO.	
	S	Г1004
SCALE		
	Αs	shown
SHEET	NO	
JHEET	140.	
		OE.

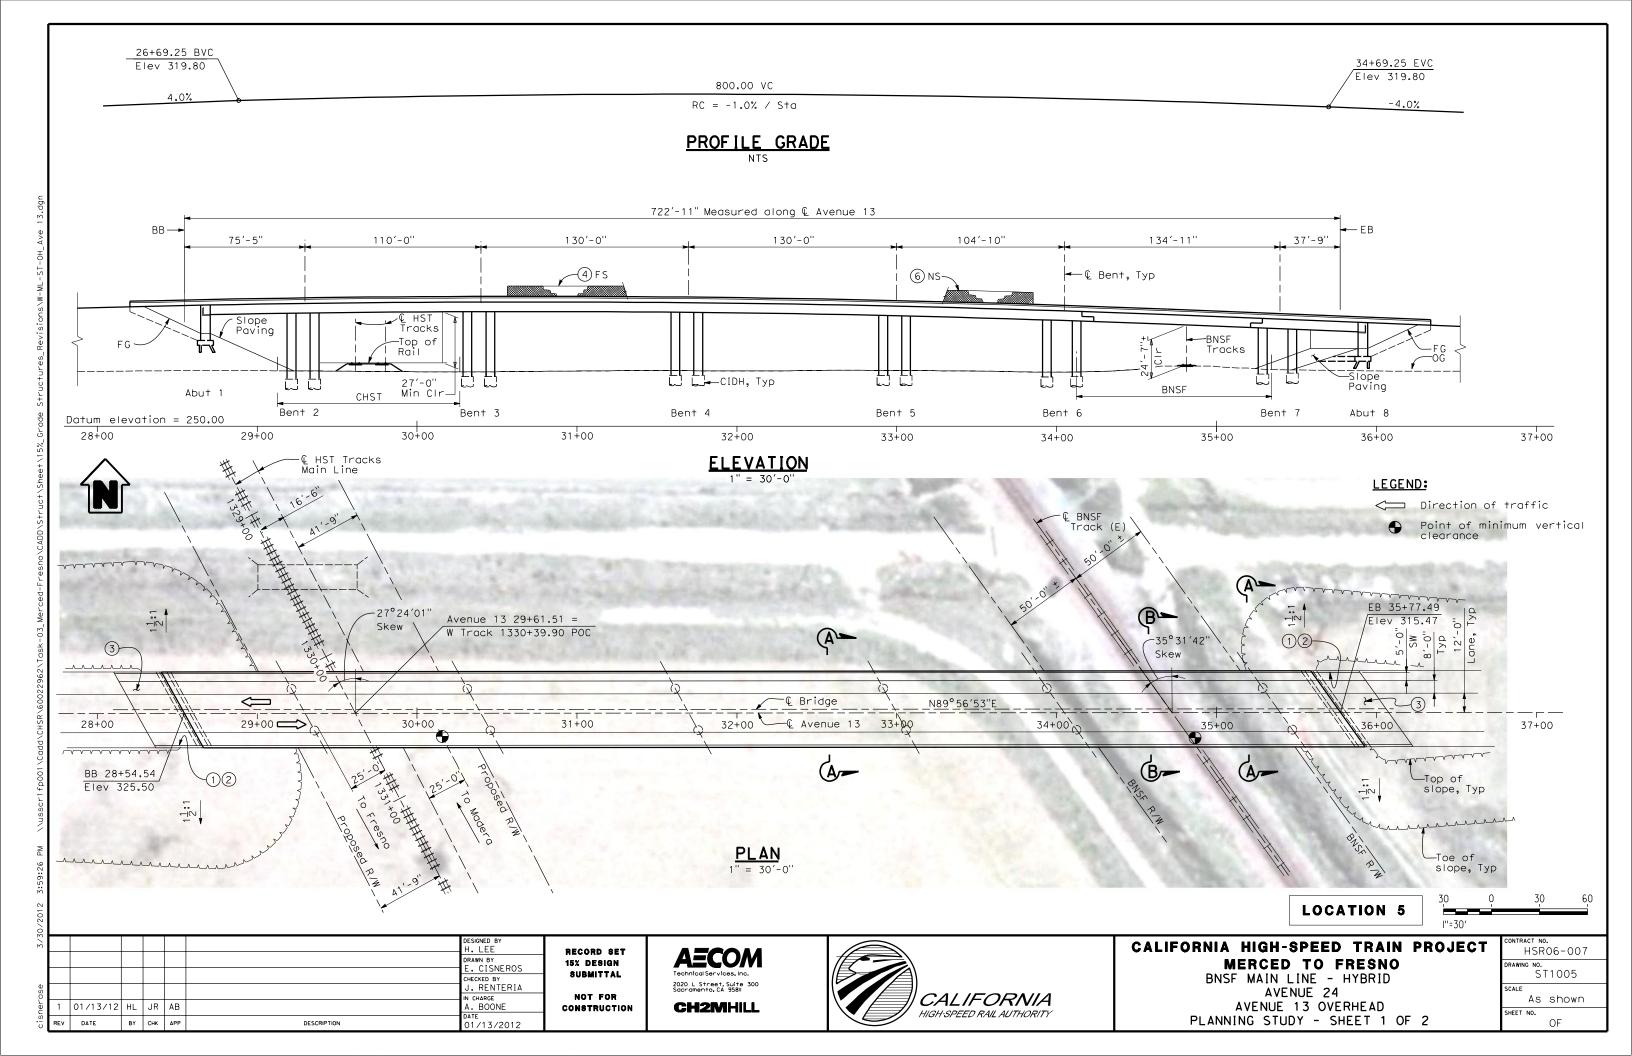

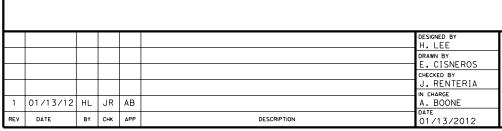

© Bridge Ave 13

12'-0"

-Profile

Grade

6'-0"

Approx OG

7'-0" Ø CIDH, Typ—

SECTION A-A

1"=10'-0"

−5′-6" Ø Conc Column, Typ

2'-3"


47'-6"

CIP/PS Box Girder







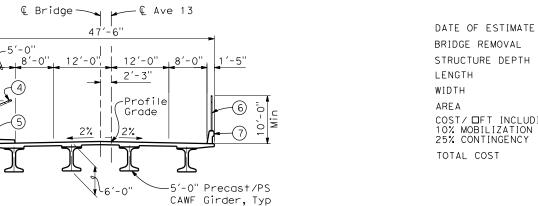

SECTION B-B 1"=10'-0"

= 6'-0" STRUCTURE DEPTH 722′-11" = 47'-6" = 34,340 f+2 COST/ □FT INCLUDING 10% MOBILIZATION & 25% CONTINGENCY

NOTES:

- (1) Paint "Bridge No. XX-XX"
- (2) Paint "Avenue 13 OH"
- 3 Structure Approach Slab Type N (30S)
- Chain Link Railing Type 3
- Concrete Barrier Type 26 (Mod)
- Chain Link Railing Type 7 (Mod)
- Concrete Barrier Type 732
- Bearing of Avenue 13 to be determined.
- 9. Existing underground and overhead utilities to be determined.





CALIFORNIA HIGH-SPEED TRAIN PROJECT MERCED TO FRESNO BNSF MAIN LINE - HYBRID


AVENUE 24 AVENUE 13 OVERHEAD PLANNING STUDY - SHEET 2 OF 2


CONTRACT NO. HSRO6-007
DRAWING NO. ST1005A
scale As shown
SHEET NO.


OF

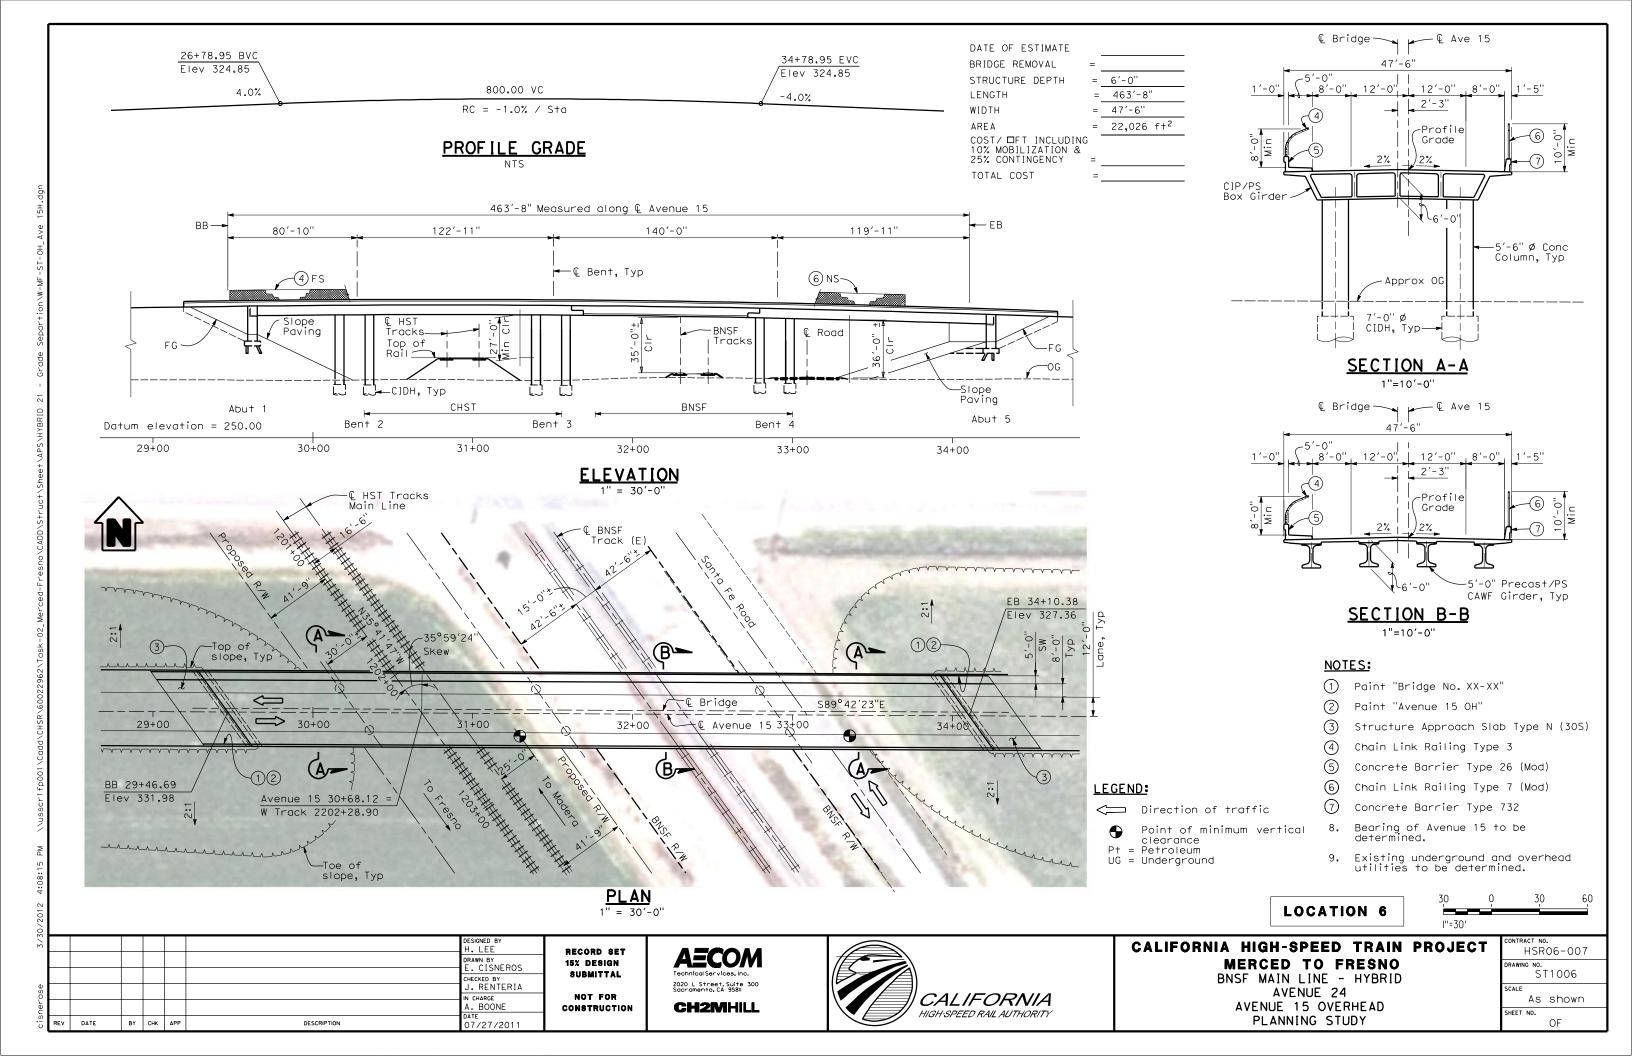


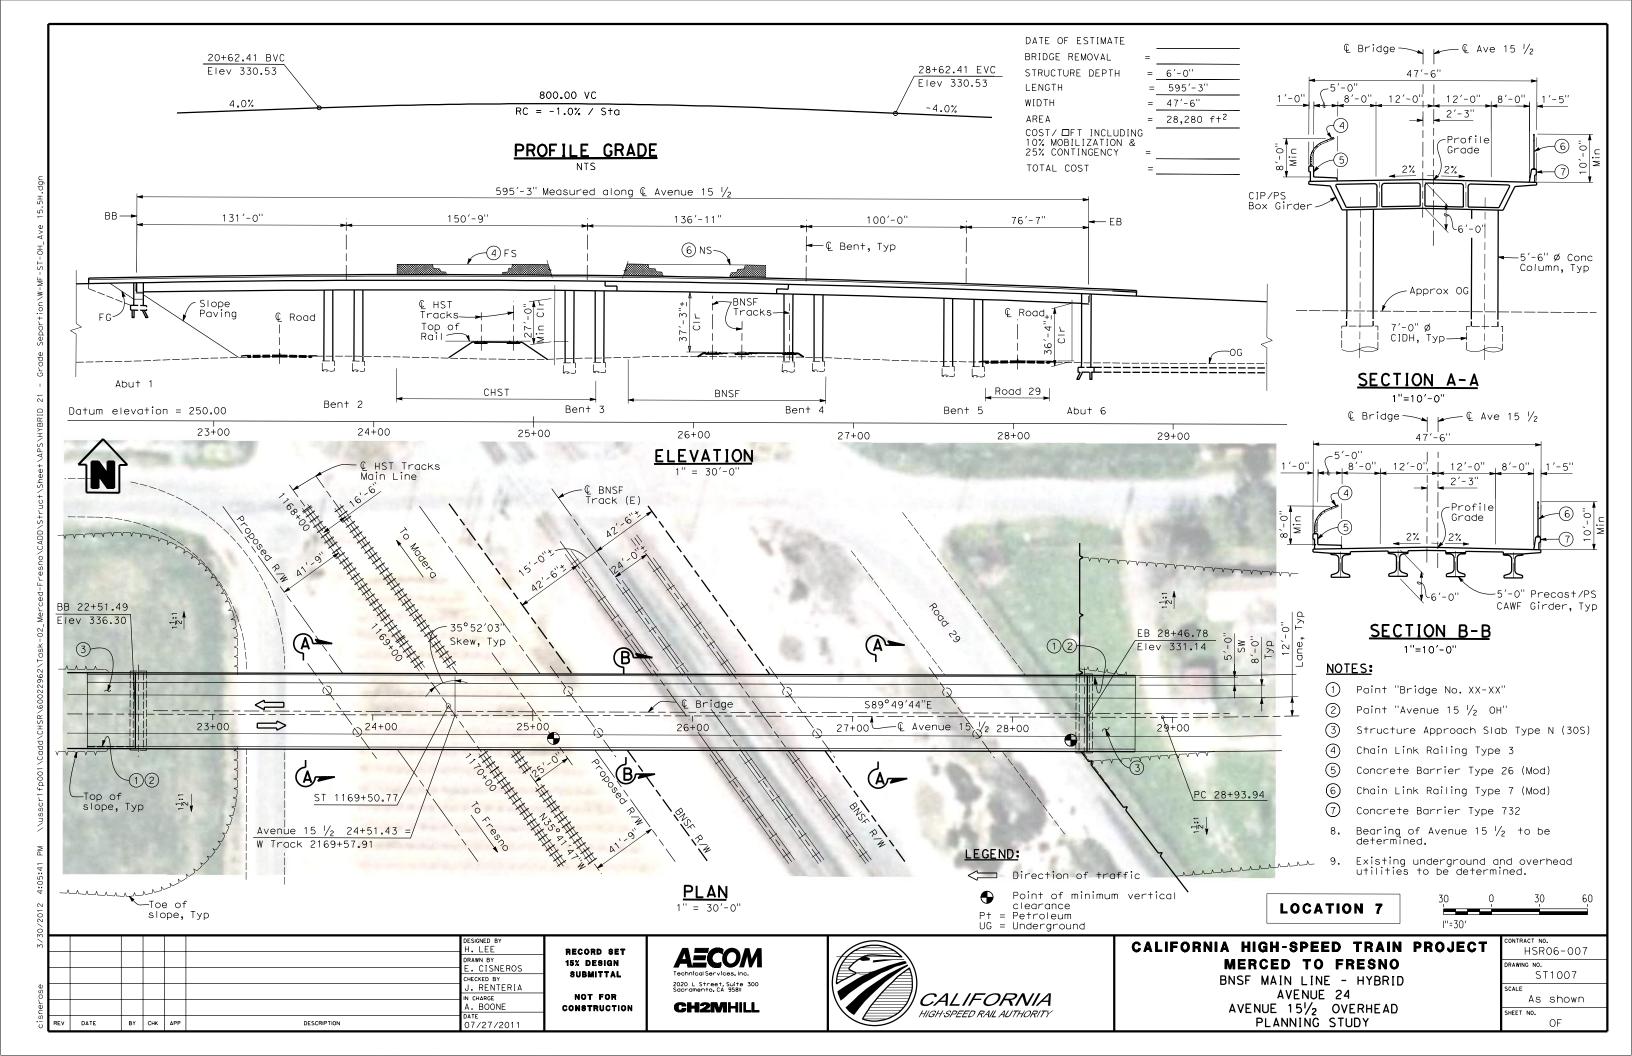


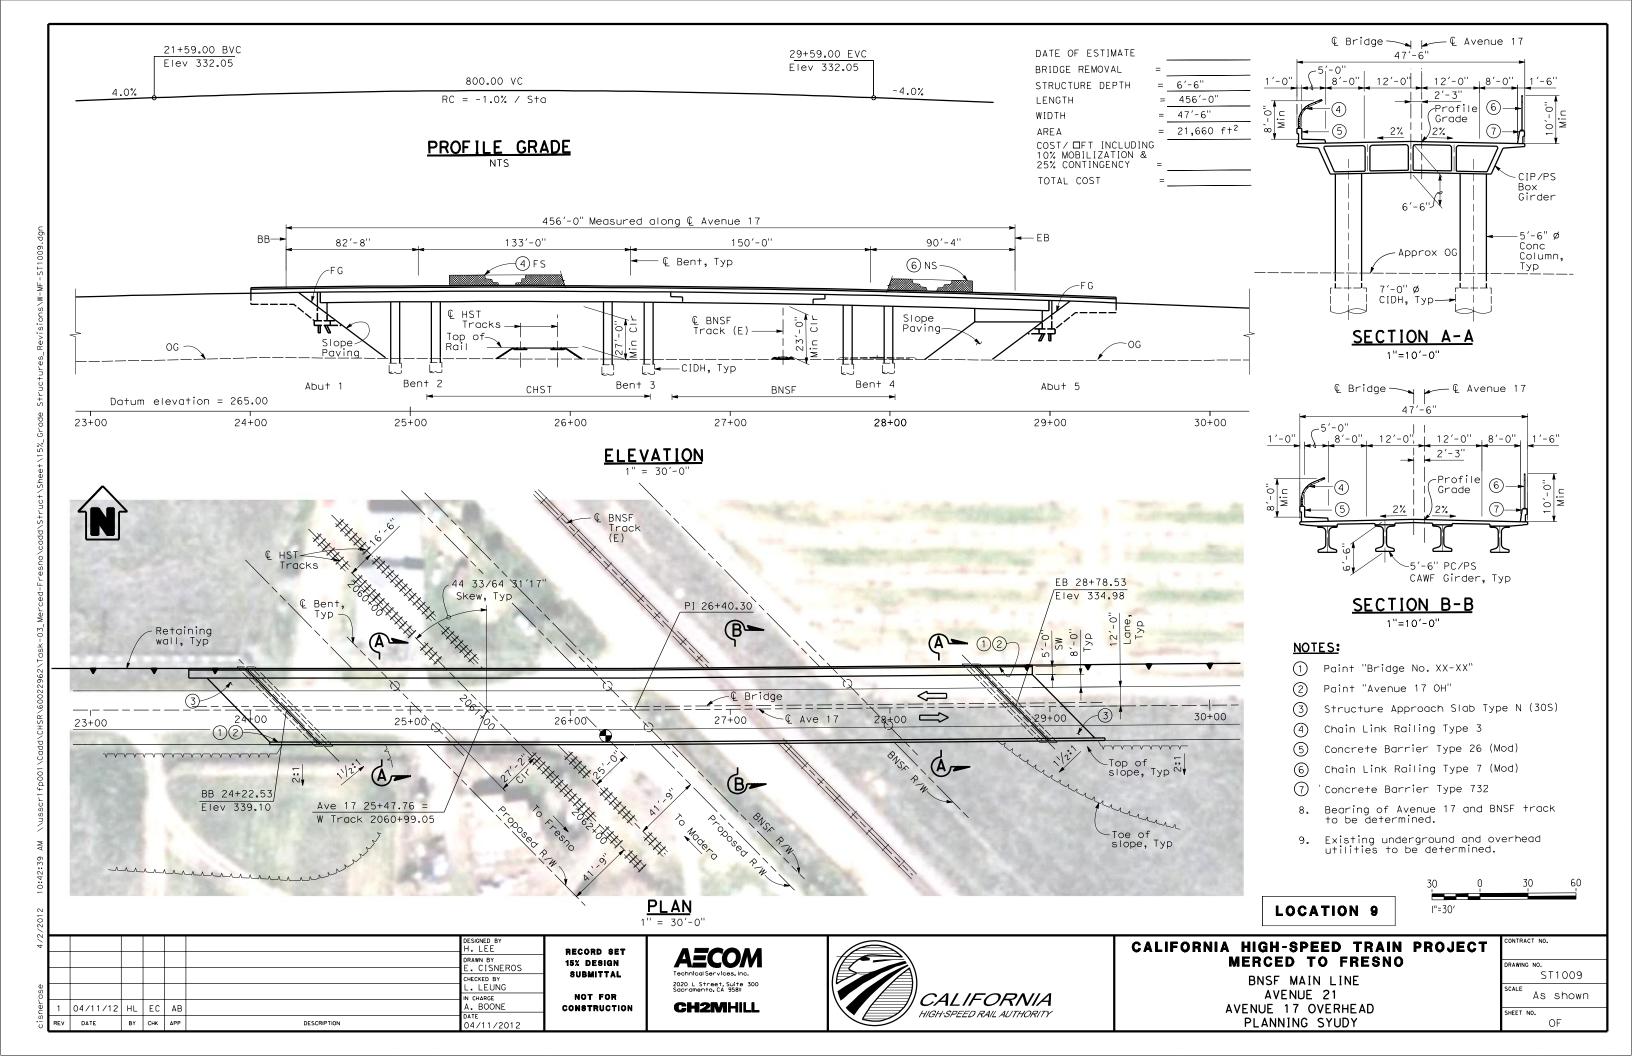


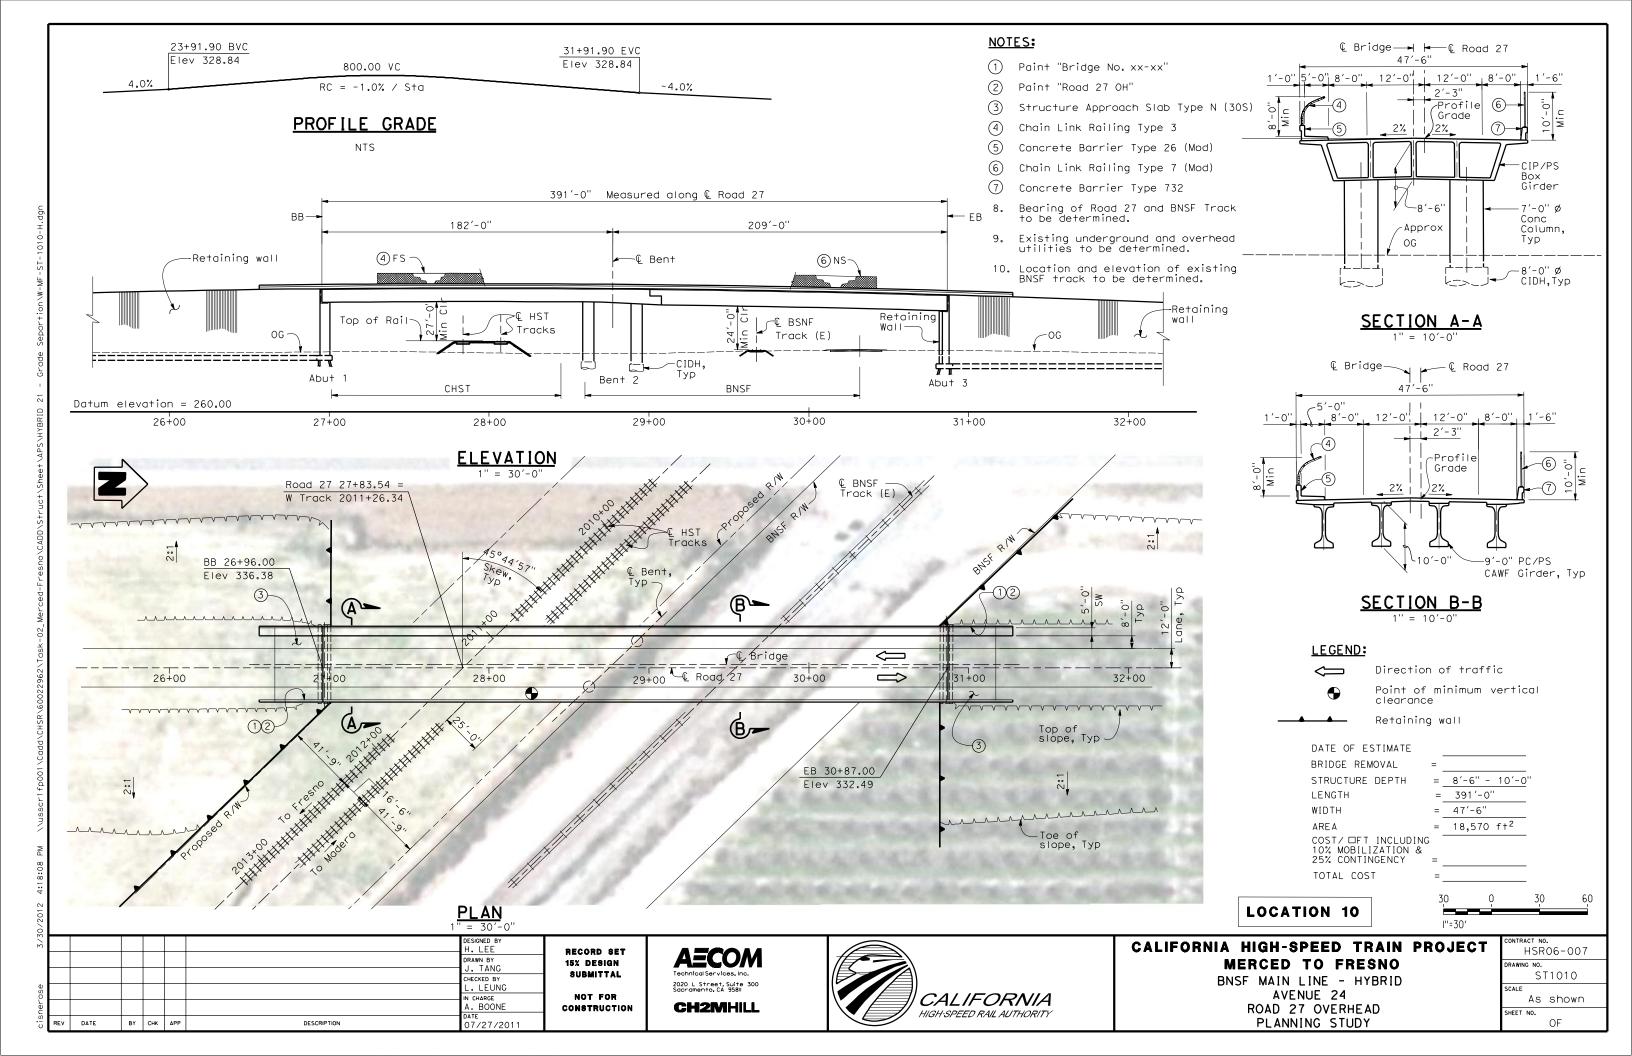


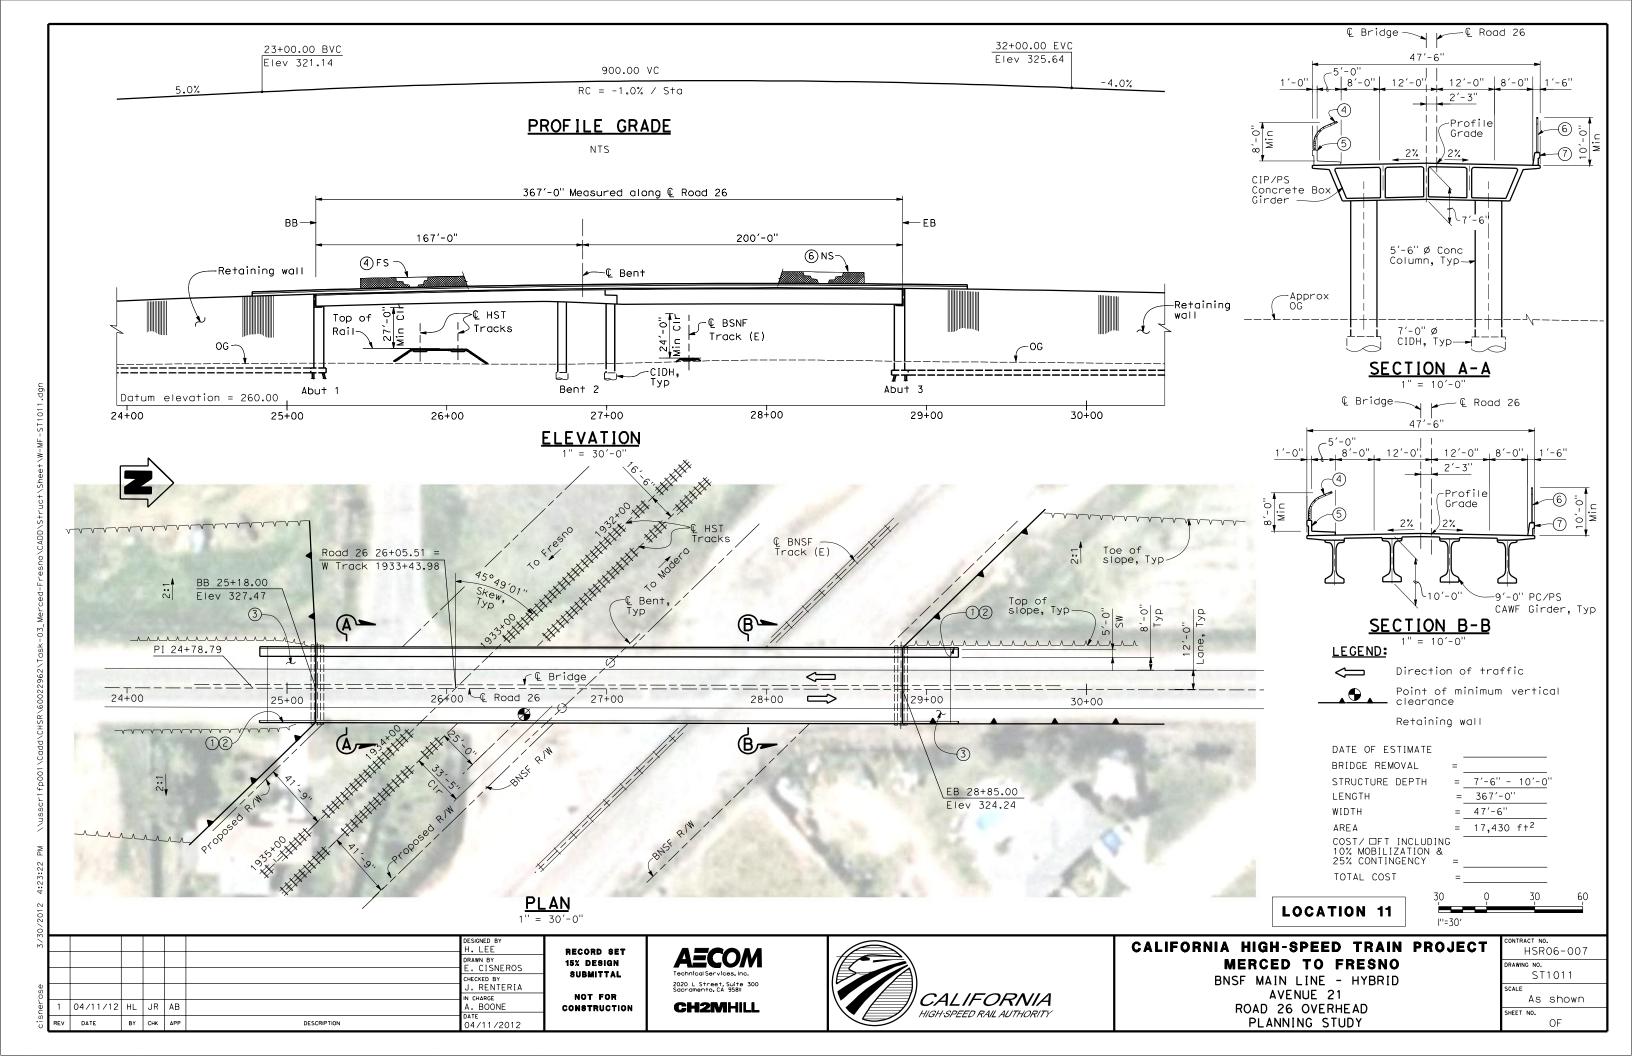


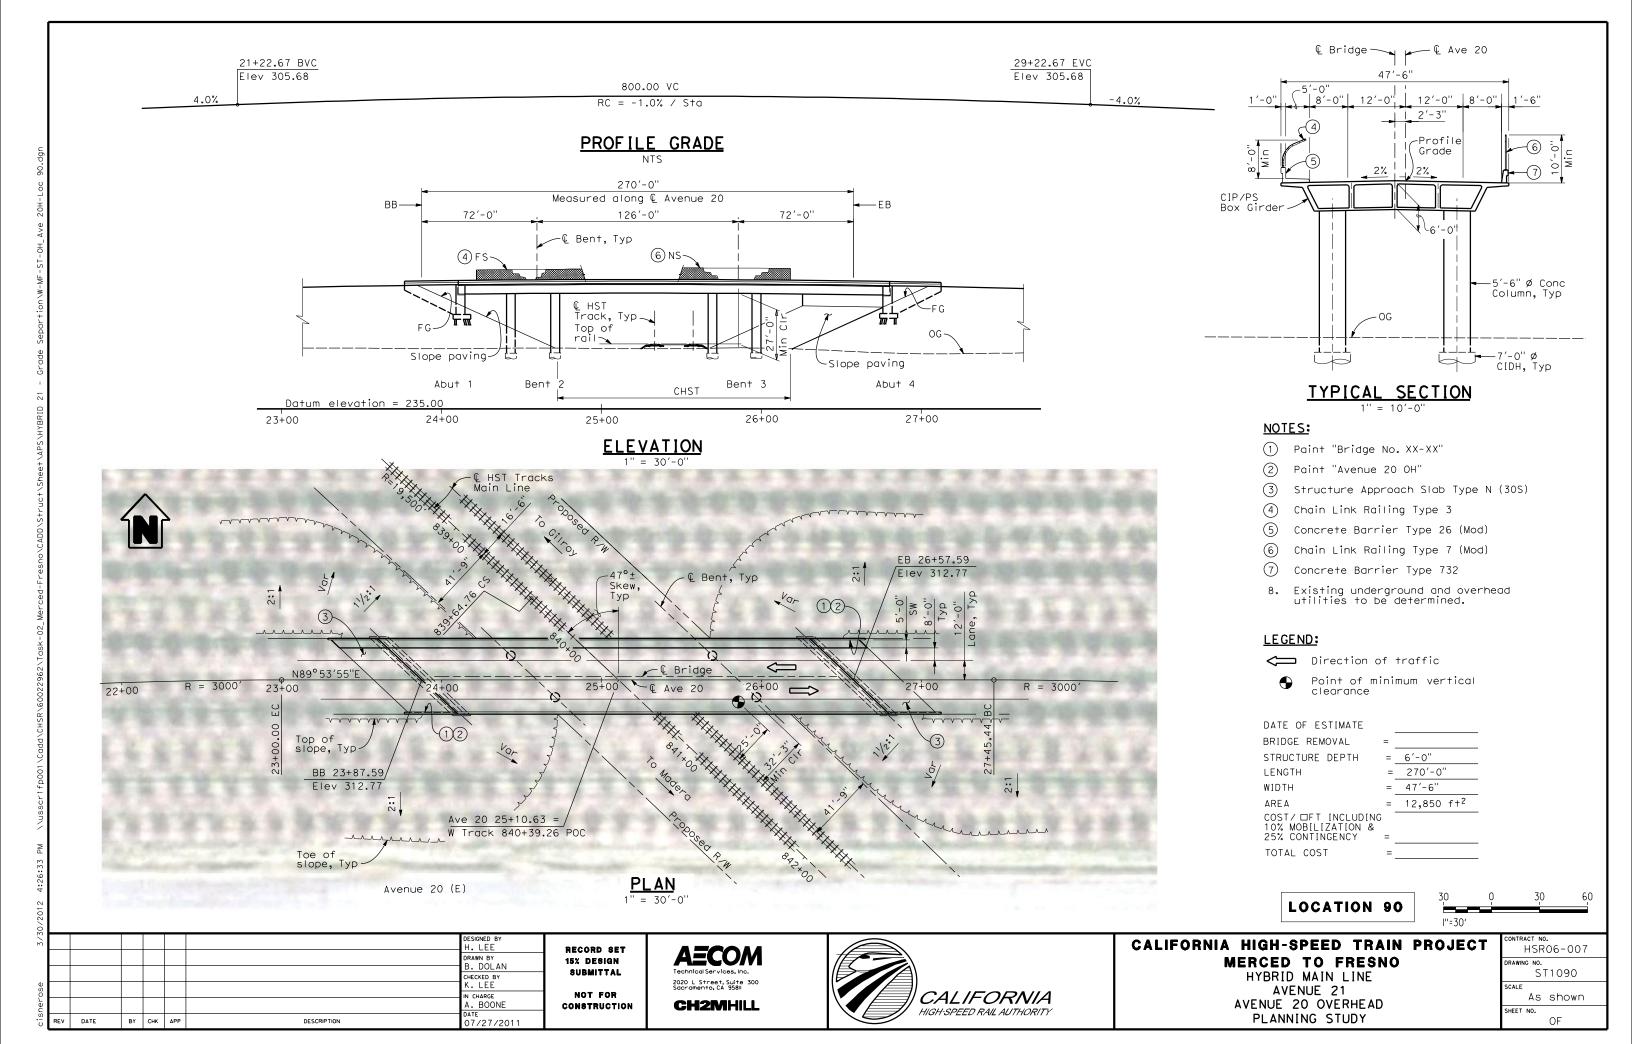


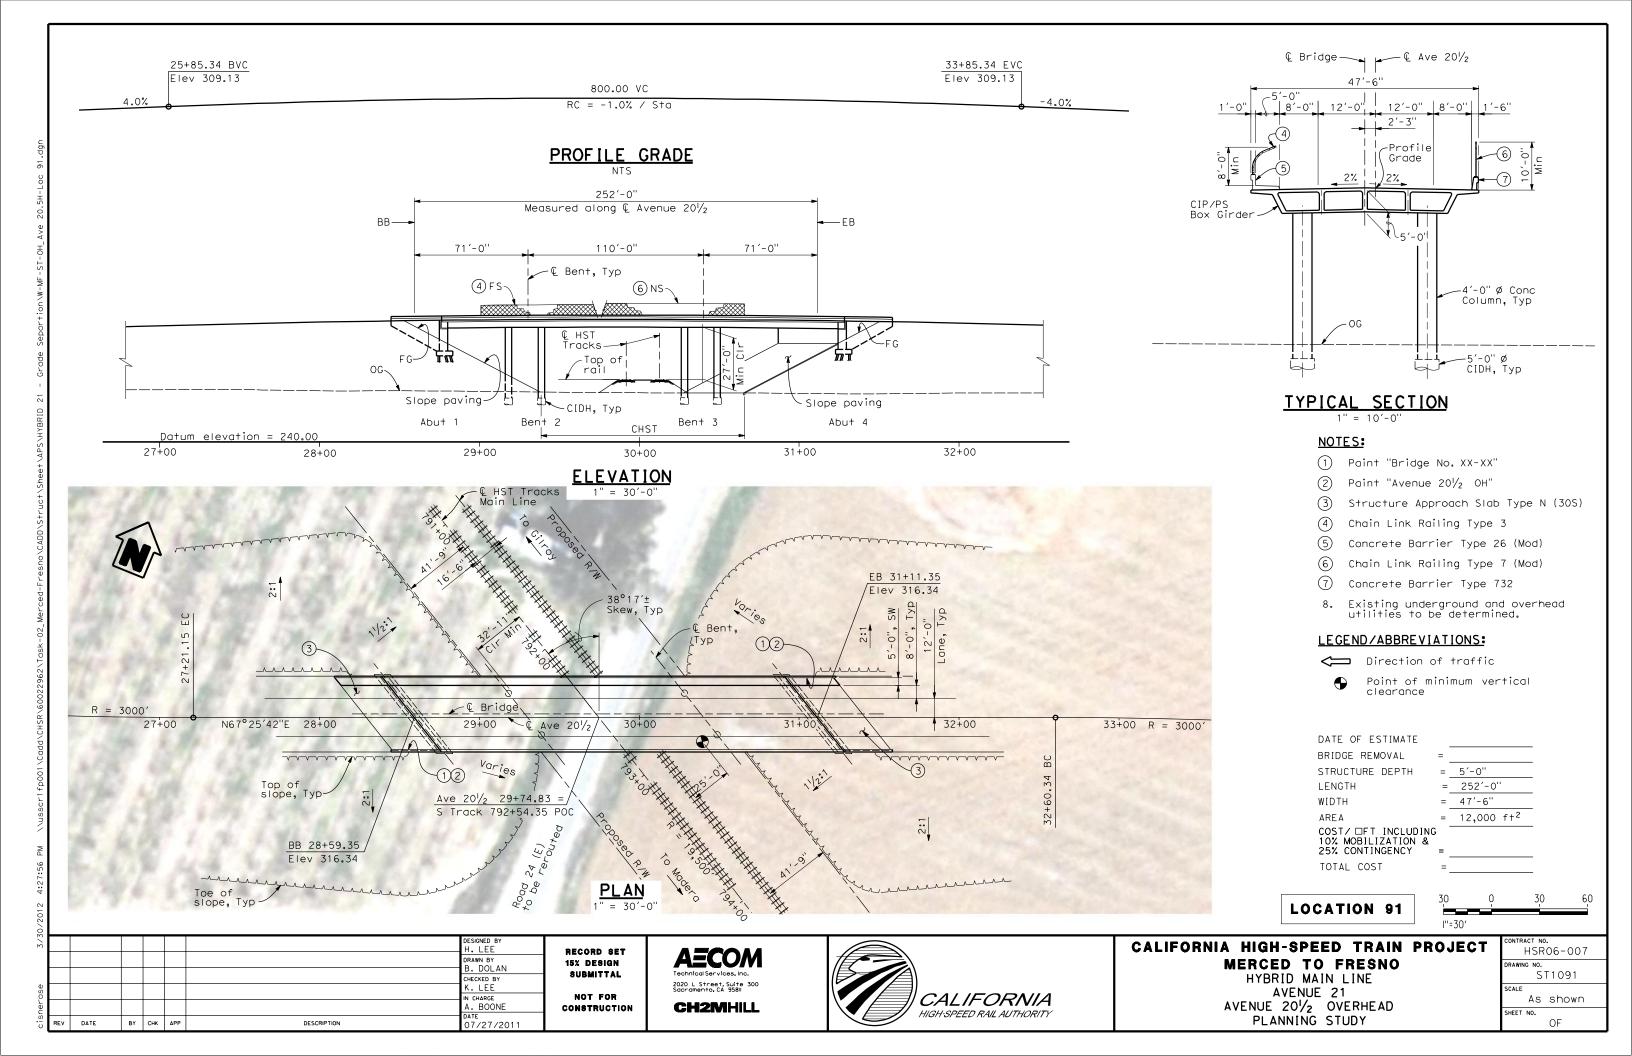


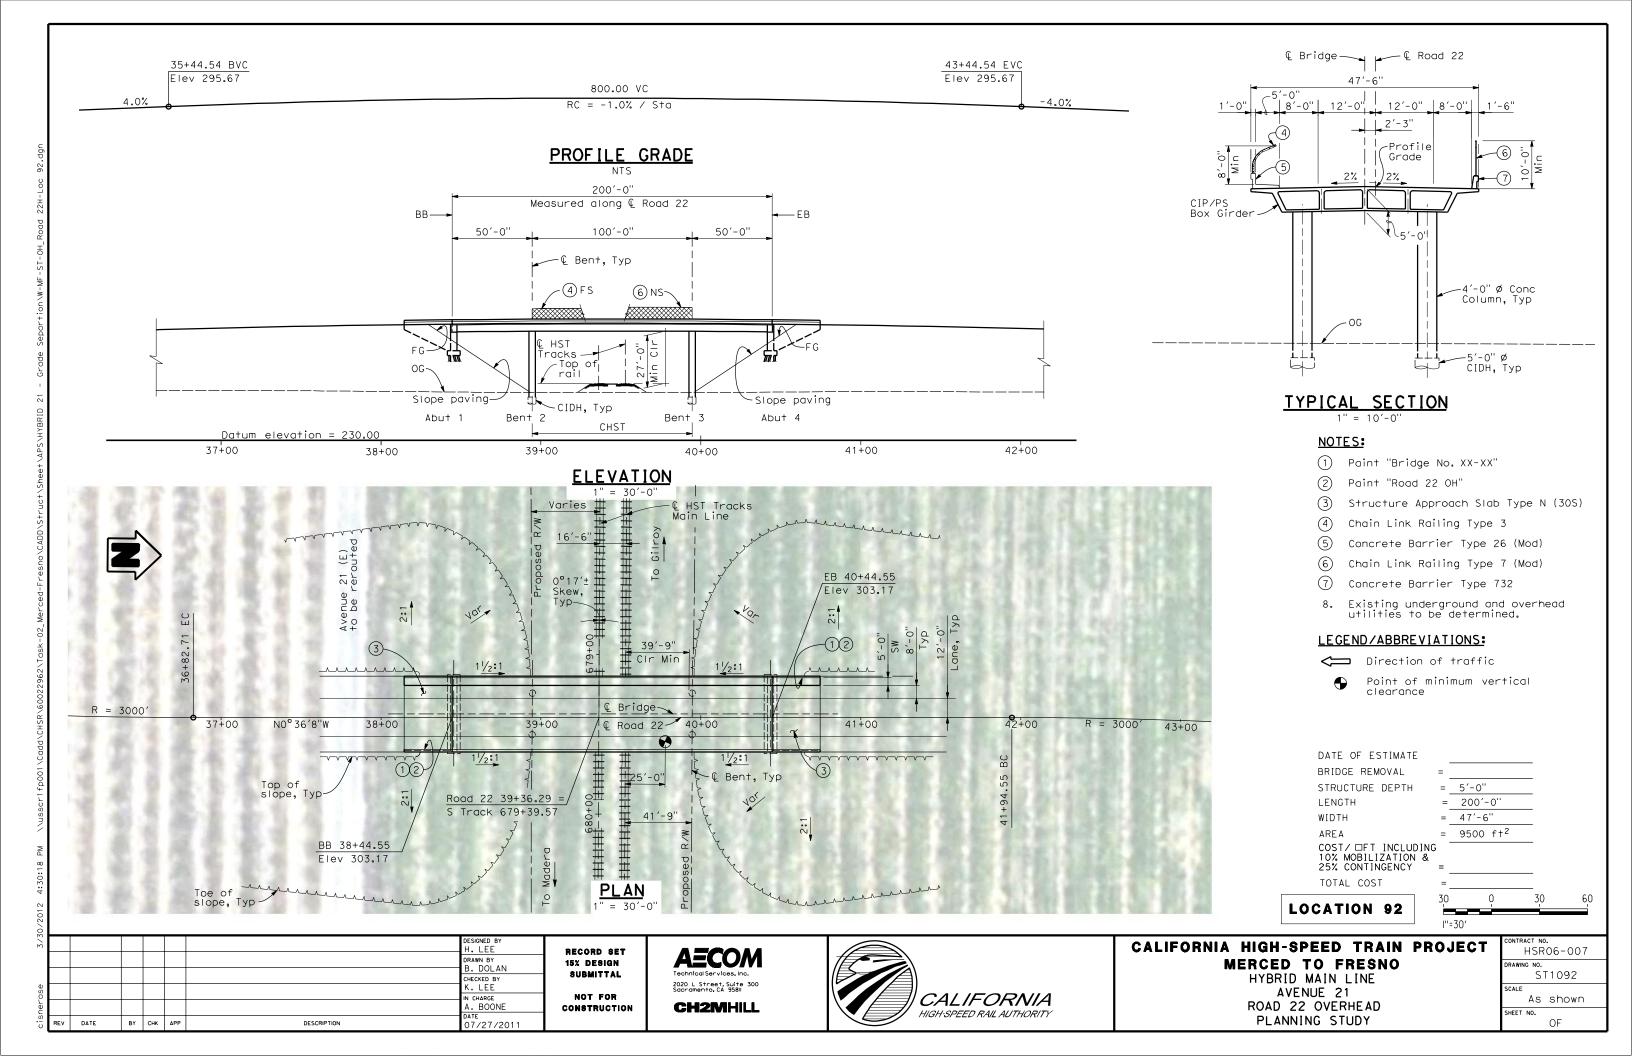


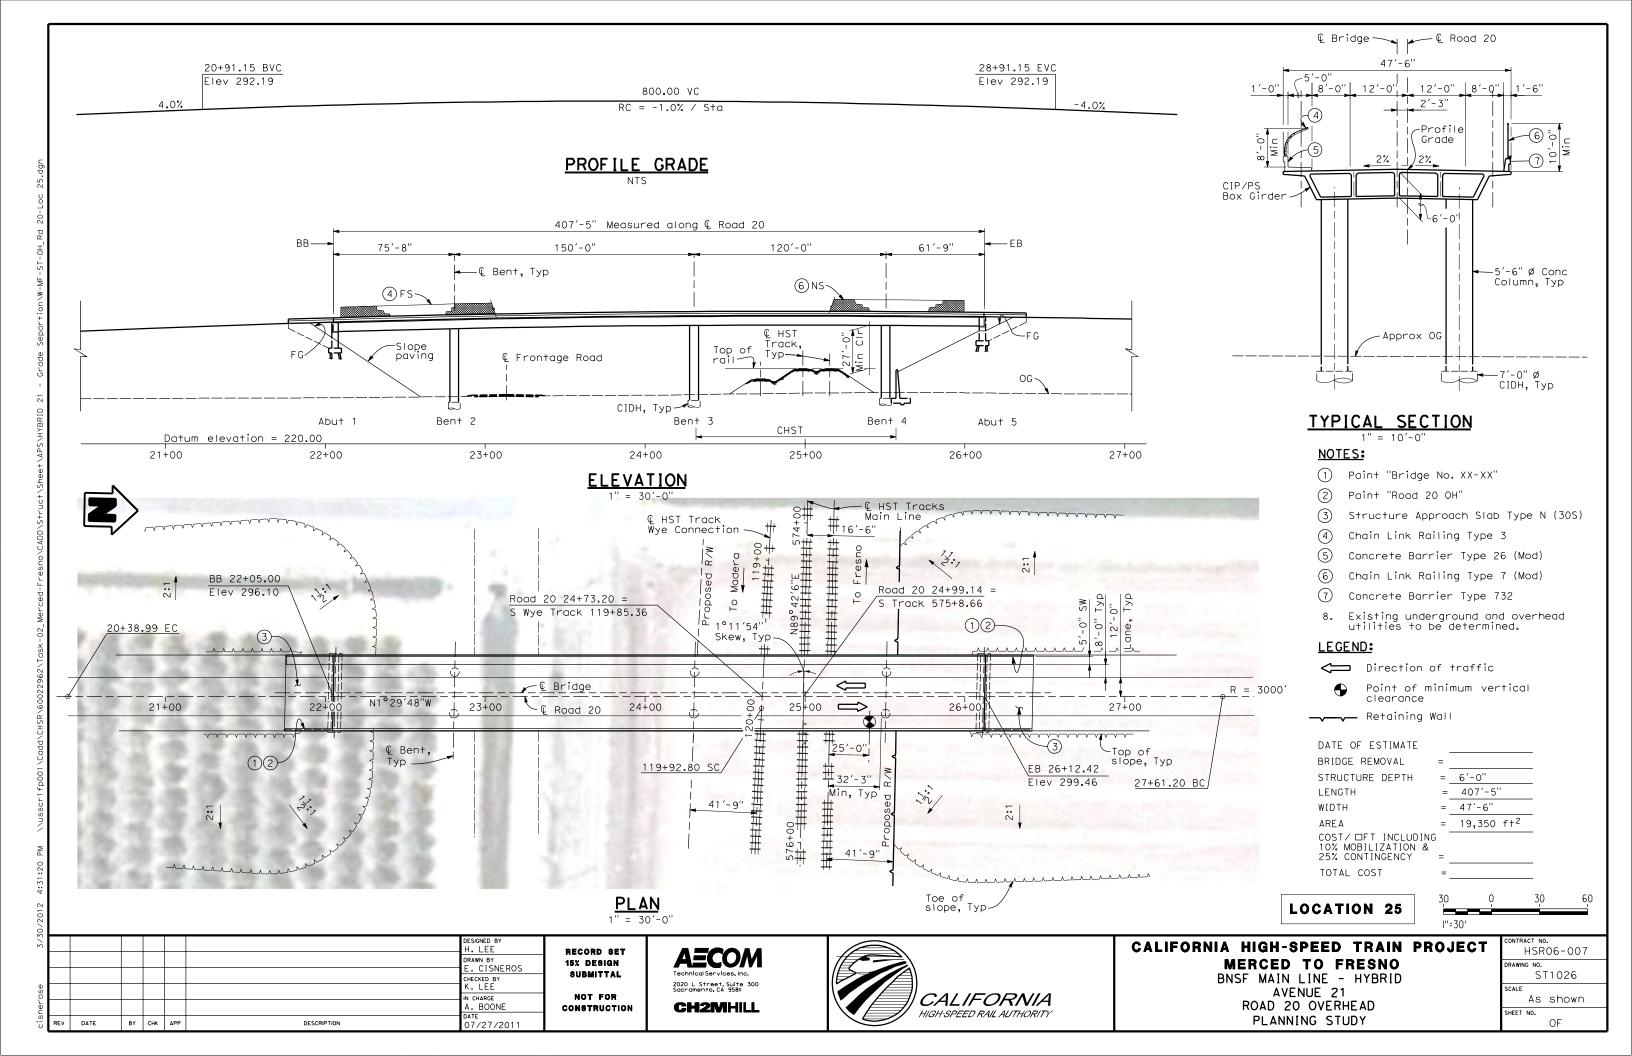


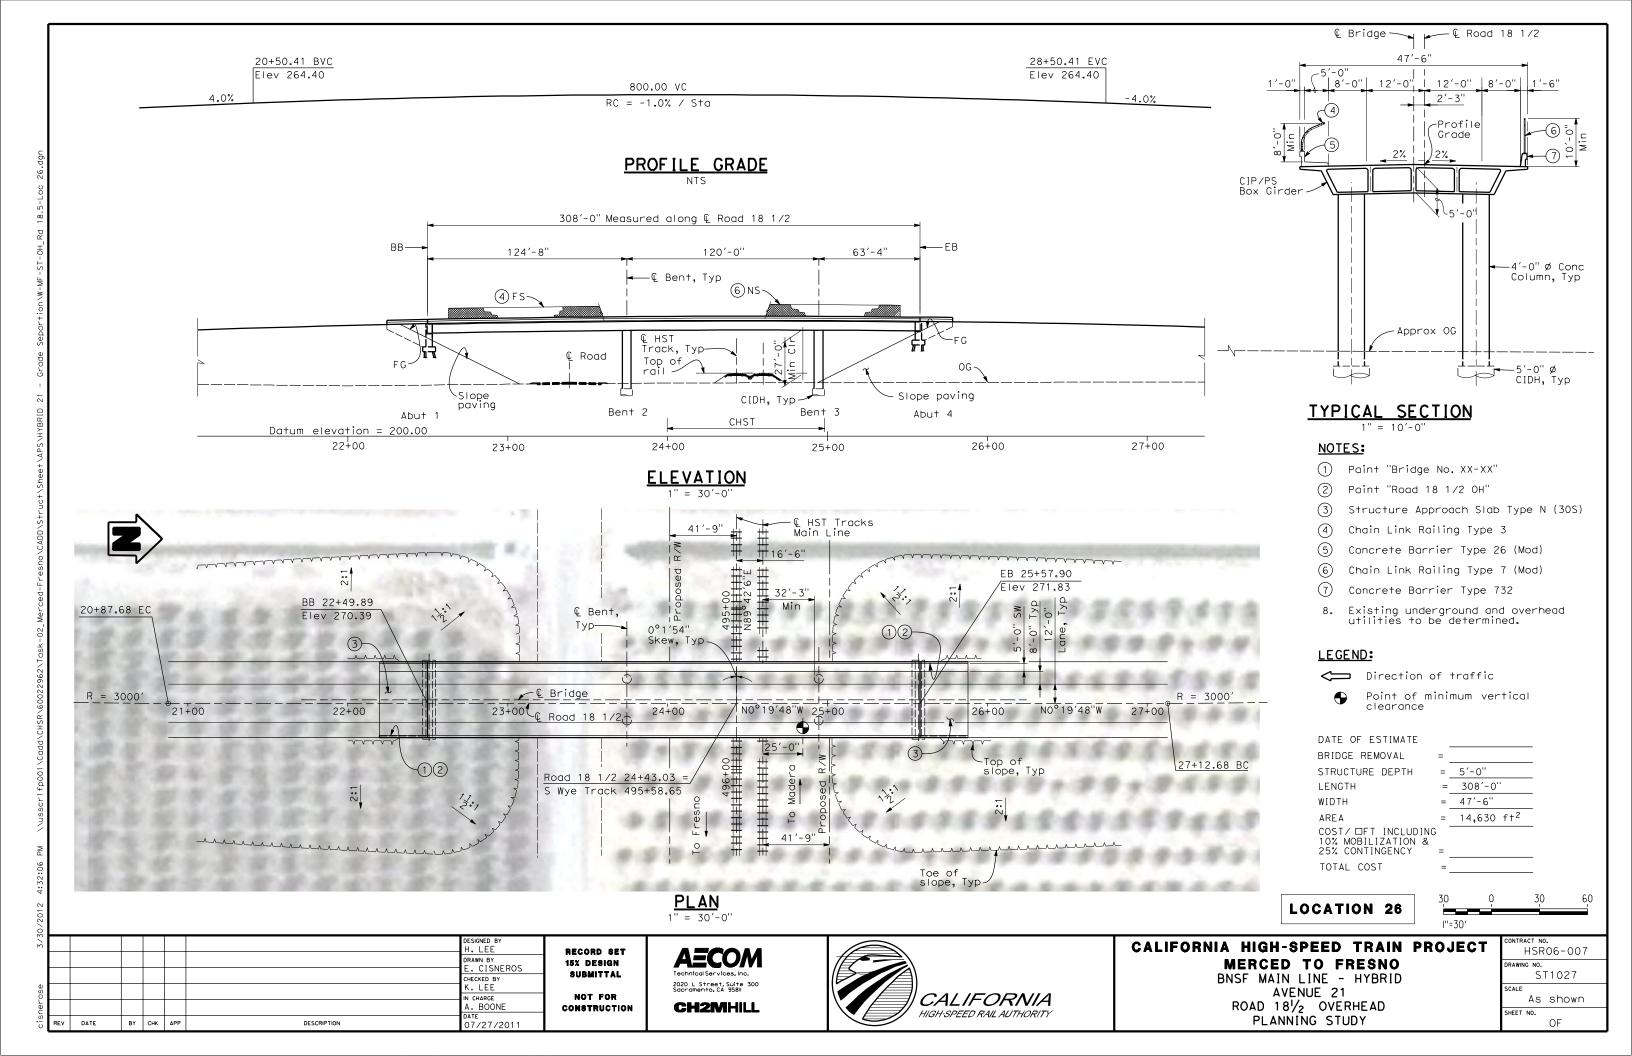


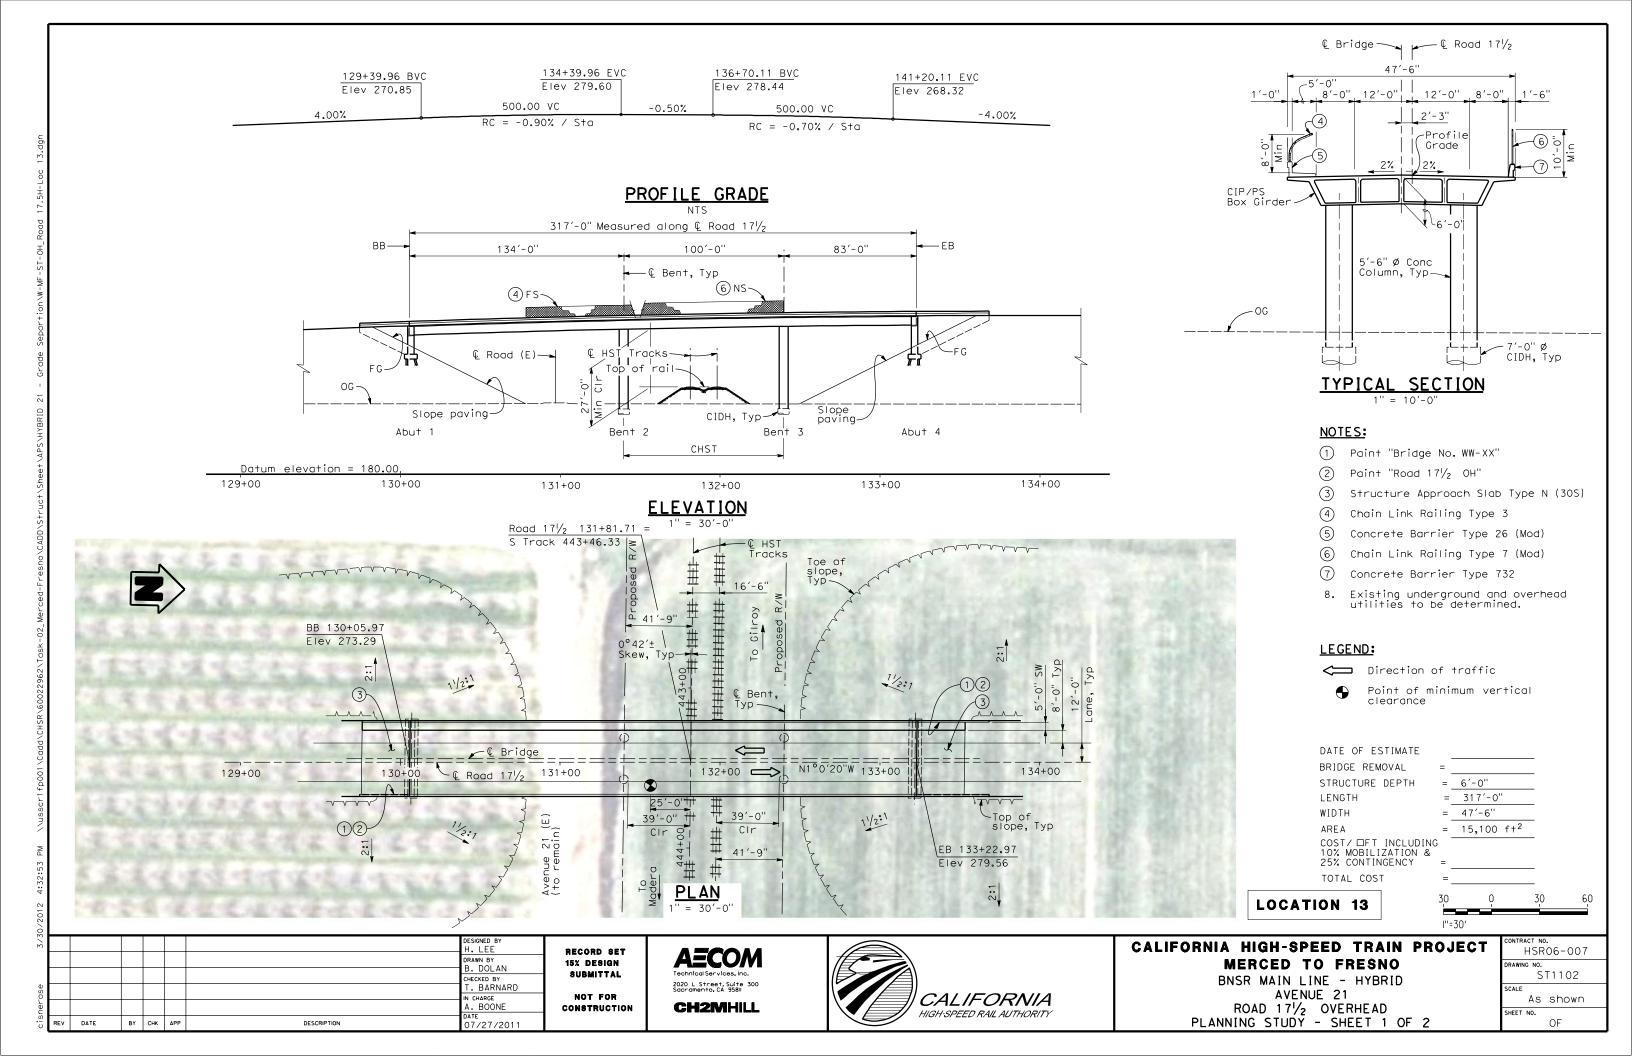


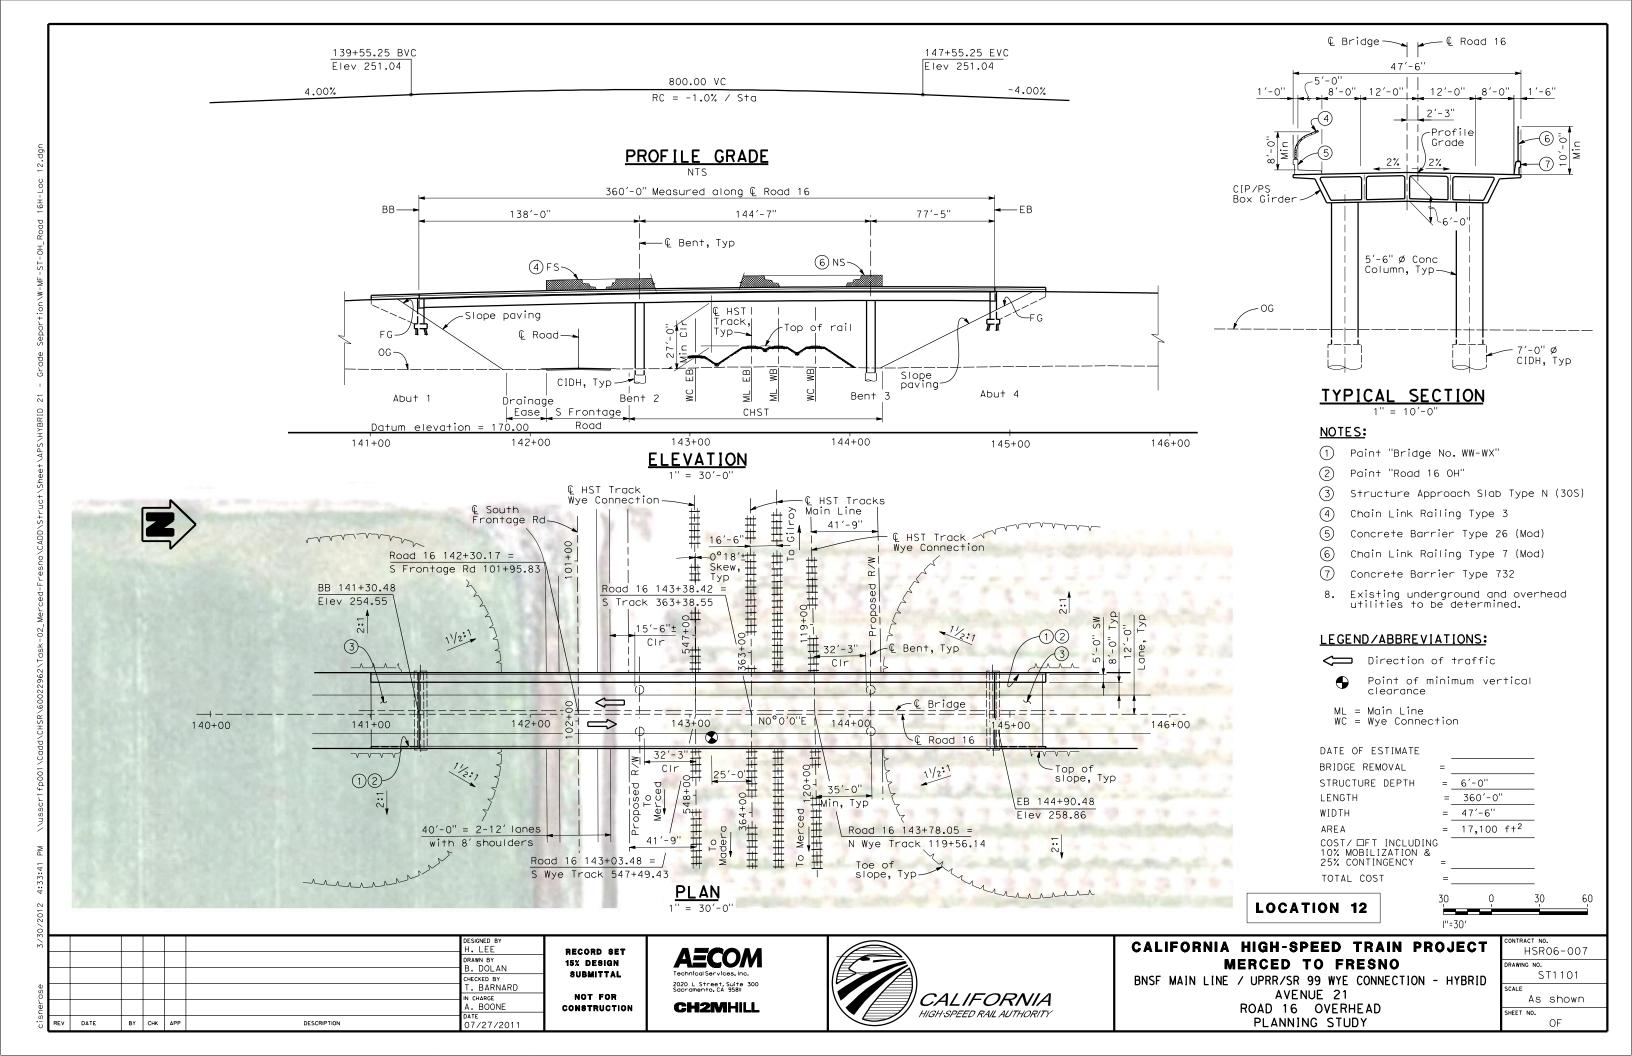

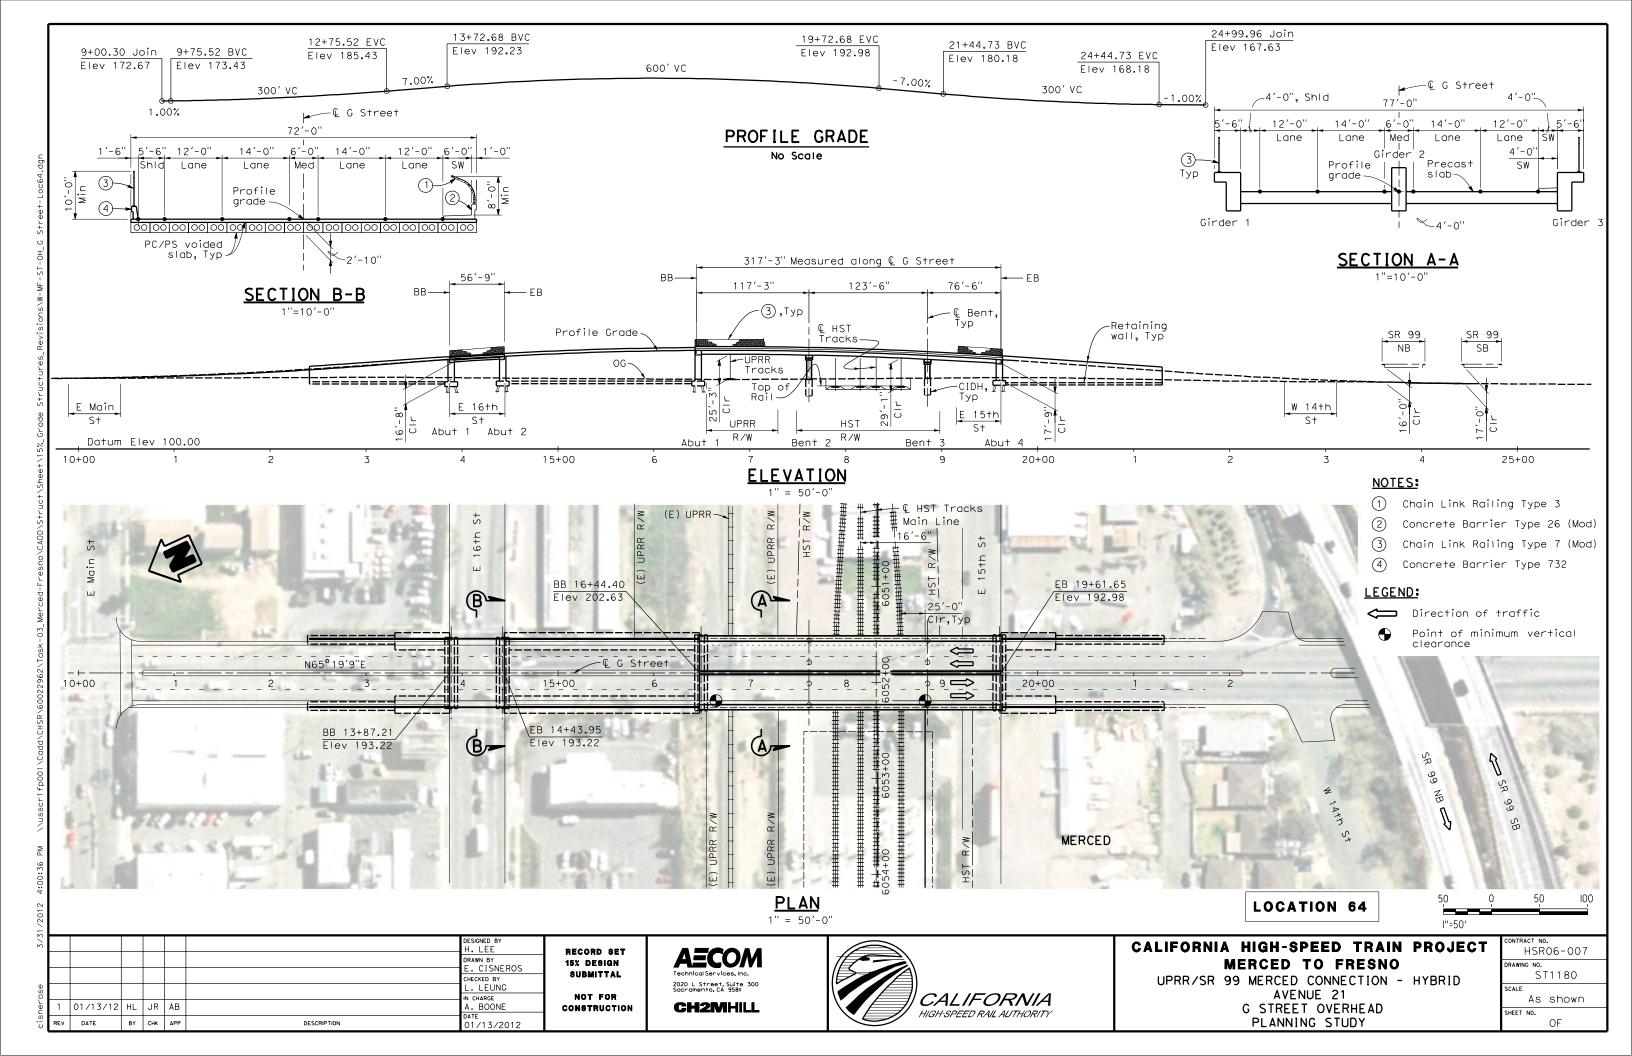

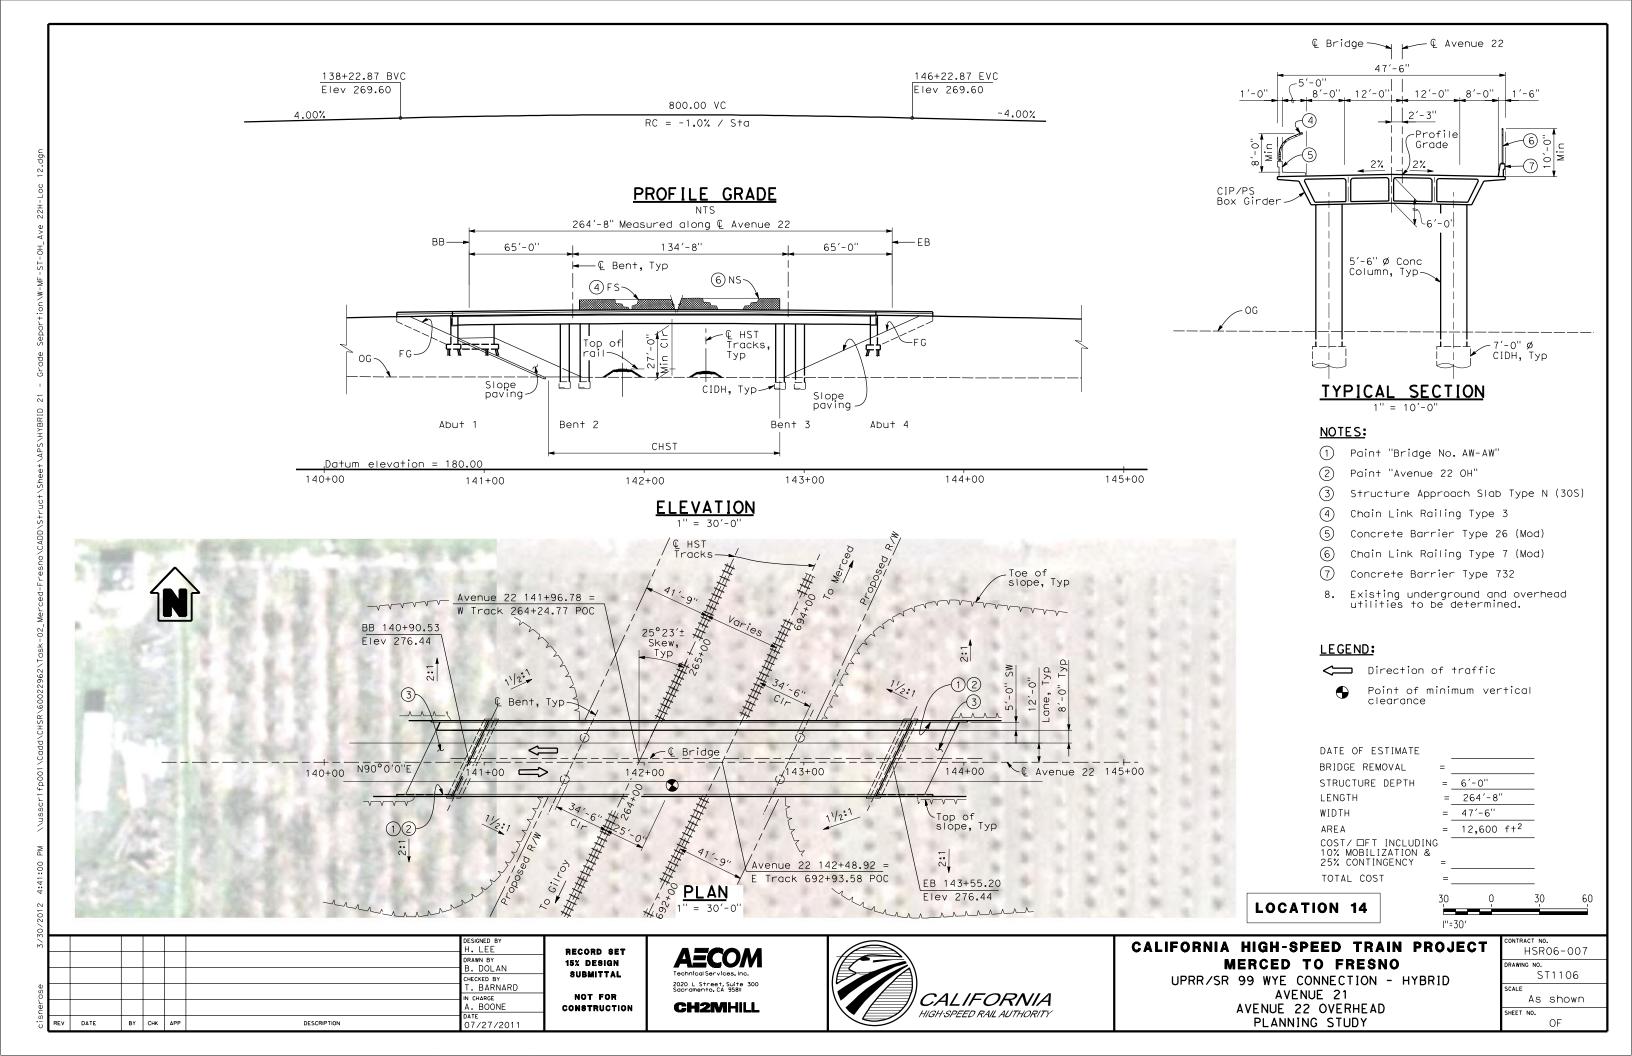

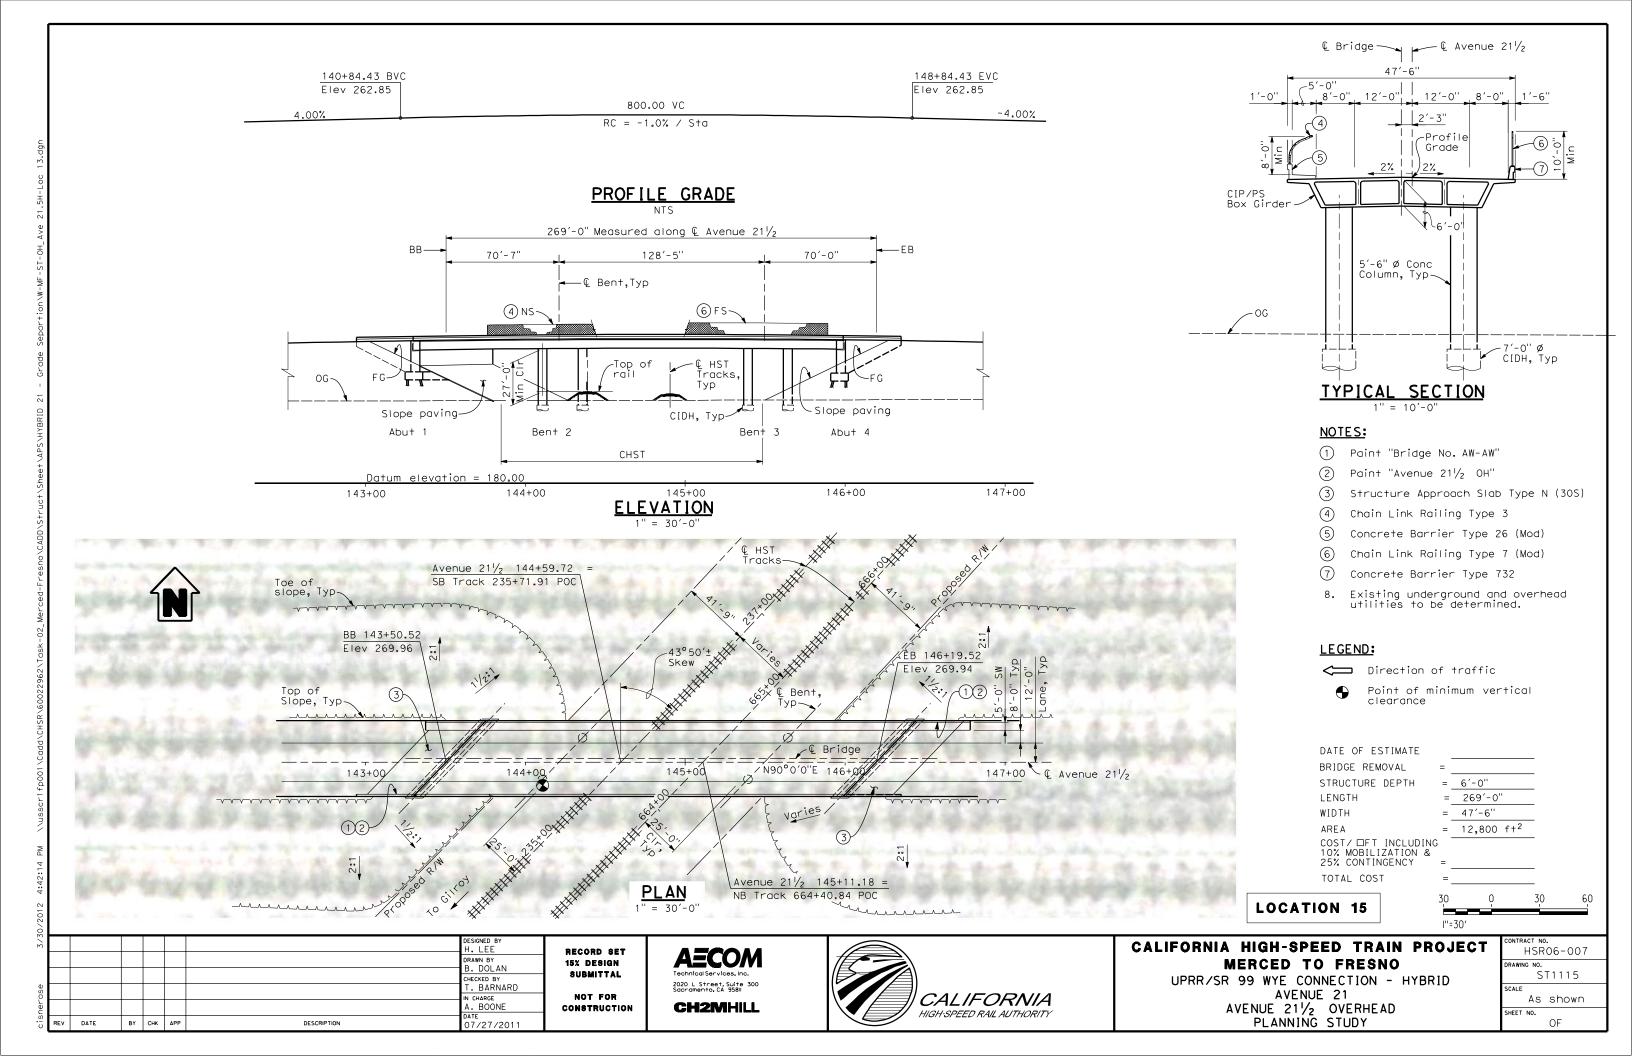

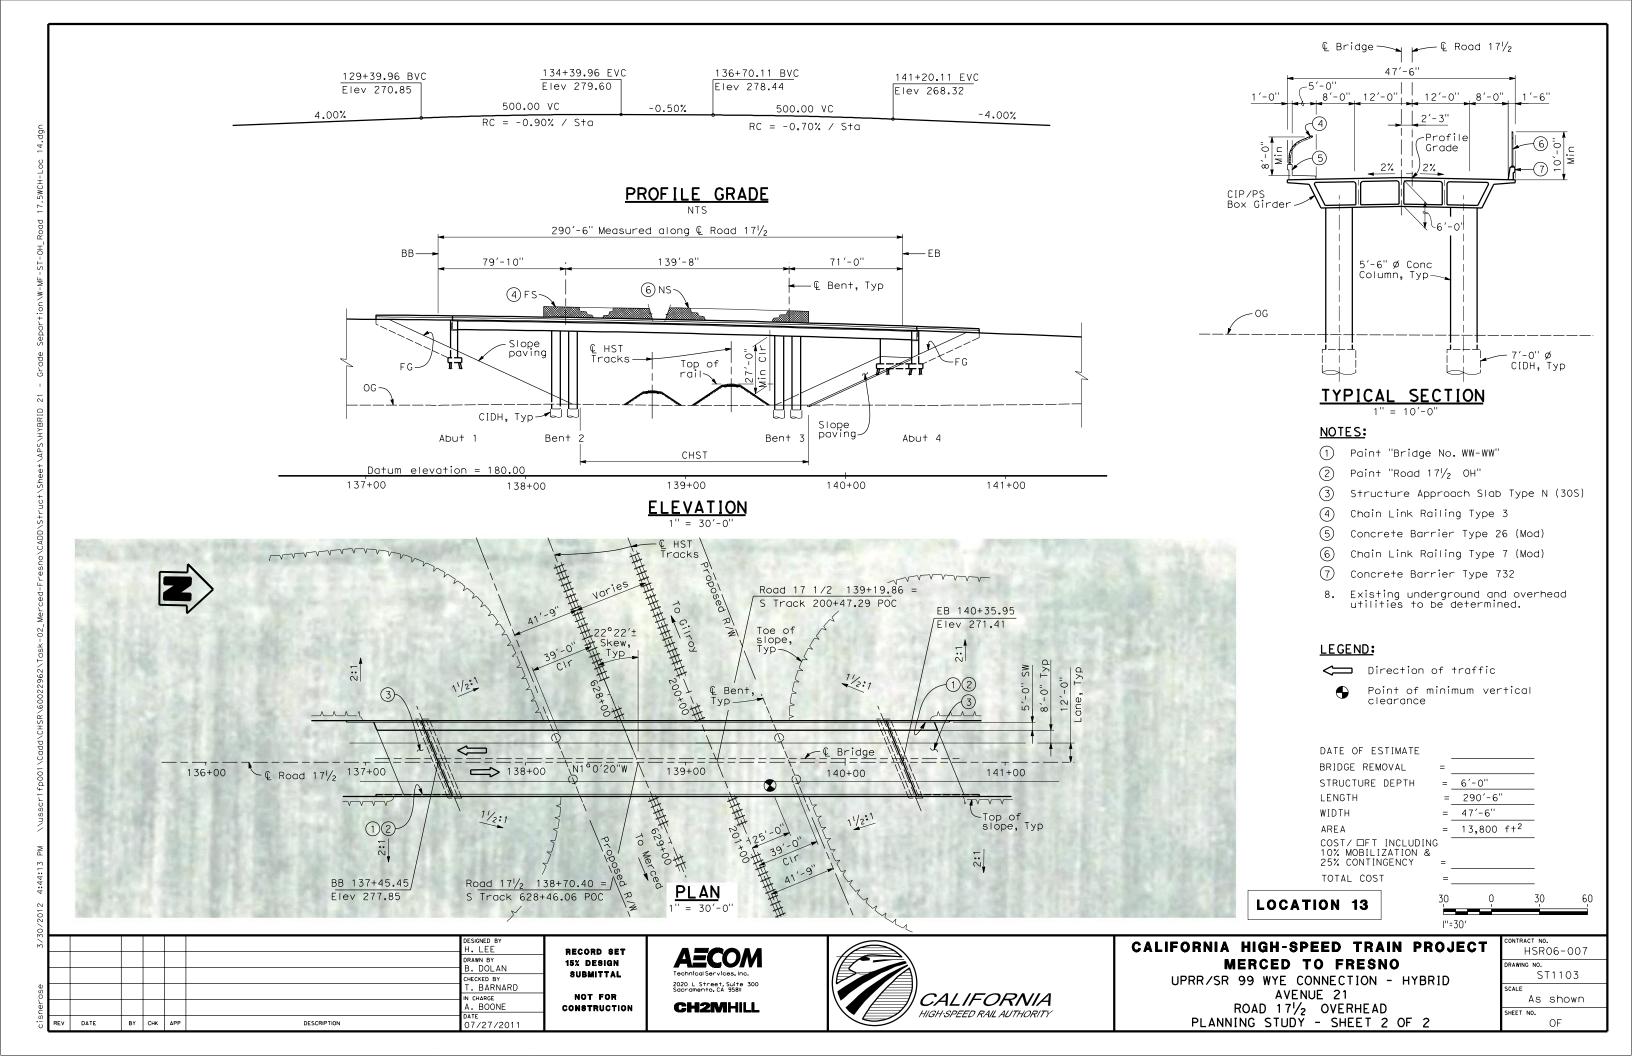

						DESIGNED BY R. LI
						DRAWN BY A. TRINH
						CHECKED BY
2	02/24/12	RG				A. SILVER
1	12/28/11	RG				A. BOONE
REV	DATE	BY	СНК	APP	DESCRIPTION	O7/27/2011

LOCATION SHT DWG

43

43

18

18

19

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NO. NO. NO.

B6990-B AVE 21 HYBRID

B6992-B AVE 21 HYBRID

B7000-B AVE 21 HYBRID

B7001-B AVE 21 HYBRID

CT6990-B AVE 21 HYBRID

CT6992-B | AVE 21 HYBRIC

CT6993-B AVE 21 HYBRID

CB7005-B UPRR/SR99 MERCED - (AVE 21 HYBRID)

CB7006-B UPRR/SR99 MERCED - (AVE 21 HYBRID

CT2001-A BNSF MAIN LINE - (AVE 21 HYBRID

T2002-A | BNSF MAIN LINE - (AVE 21 HYBRIC

CT2003-A BNSF MAIN LINE - (AVE 21 HYBRID)

T7034-B UPRR/SR99 MERCED - (AVE 21 HYBRID

CT7035-B UPRR/SR99 MERCED - (AVE 21 HYBRID)

CT7036-B | UPRR/SR99 MERCED - (AVE 21 HYBRID)

CT7037-B UPRR/SR99 MERCED - (AVE 21 HYBRID

CT7038-B UPRR/SR99 MERCED - (AVE 21 HYBRID

CT7039-B UPRR/SR99 MERCED - (AVE 21 HYBRID CT7040-B UPRR/SR99 MERCED - (AVE 21 HYBRID

CT7041-B UPRR/SR99 MERCED - (AVE 21 HYBRID)

CT7043-B | UPRR/SR99 MERCED - (AVE 21 HYBRID)

CT3001-A BNSF MAINLINE - (AVE 21 HYBRID)

CT3002-A BNSF MAINLINE - (AVE 21 HYBRID)

CT3003-A BNSF MAINLINE - (AVE 21 HYBRID)

T8045-B | UPRR/SR99 MERCED - (AVE 21 HYBRID

T8046-B UPRR/SR99 MERCED - (AVE 21 HYBRID)

CT8047-B UPRR/SR99 MERCED - (AVE 21 HYBRID

CT8048-B | UPRR/SR99 MERCED - (AVE 21 HYBRID)

T8049-B UPRR/SR99 MERCED - (AVE 21 HYBRIC

CT8050-B UPRR/SR99 MERCED - (AVE 21 HYBRID)

CT8051-B UPRR/SR99 MERCED - (AVE 21 HYBRID)

T8052-B UPRR/SR99 MERCED - (AVE 21 HYBRID

T8054-B UPRR/SR99 MERCED - (AVE 21 HYBRID

CT8055-B UPRR/SR99 MERCED - (AVE 21 HYBRID)

CT8056-B UPRR/SR99 MERCED - (AVE 21 HYBRID)

CT8053-B UPRR/SR99 MERCED - (AVE 21 HYBRID

T7042-B UPRR/SR99 MERCED - (AVE 21 HYBRID

DRAWING TITLE

LINE 3

DRAWING TITLE

LINE 4

GENERAL

GRADE SEPARATION - SANDY MUSH RD INTERCHANGE

CRADE SEPARATION - SANDY MUSH RD INTERCHANGE

GRADE SEPARATION - SANDY MUSH RD INTERCHANGE

GRADE SEPARATION - SANDY MUSH RD INTERCHANGE

GRADE SEPARATION - LE GRAND RD INTERCHANGE

GRADE SEPARATION - LE GRAND RD INTERCHANGE

GRADE SEPARATION - LE GRAND RD INTERCHANGE GRADE SEPARATION - LE GRAND RD INTERCHANGE

GRADE SEPARATION - LE GRAND RD INTERCHANGE

GRADE SEPARATION - SANDY MUSH RD INTERCHANGE

GRADE SEPARATION - SANDY MUSH RD INTERCHANGE

GRADE SEPARATION - SANDY MUSH RD INTERCHANGE

GRADE SEPARATION - LE GRAND RD INTERCHANGE

GRADE SEPARATION - LE GRAND RD INTERCHANGE GRADE SEPARATION - LE GRAND RD INTERCHANGE

GRADE SEPARATION - LE GRAND RD INTERCHANGE GRADE SEPARATION - LE GRAND RD INTERCHANGE

GRADE SEPARATION-LE GRAND RD IC SR99 SB ON-RAMP

GRADE SEPARATION-LE GRAND RD IC SR99 SB ON-RAMP

GRADE SEPARATION-LE GRAND RD IC SR99 SB OFF-RAMP

GRADE SEPARATION-LE GRAND RD IC SR99 SB OFF-RAMP PROFIL

AVE 21 HYBRID (PROFILE) GRADE SEPARATION - AVENUE 8

GRADE SEPARATION - AVENUE 8

GRADE SEPARATION - AVENUE 8

GRADE SEPARATION - LE GRAND RD IC SR99 SB ON-RAMP LAYOUT GRADE SEPARATION - LE GRAND RD IC SR99 SB OFF-RAMP LAYOUT

GRADE SEPARATION - LE GRAND RD INTERCHANGE

AVE 21 HYBRID (LAYOUT)

GRADE SEPARATION - AVENUE 8

GRADE SEPARATION - AVENUE 8

GRADE SEPARATION - AVENUE 8

GENERAL

GENERAL

DRAWING TITLE

LINE 5

GENERAL STAGE CONSTRUCTION AND TRAFFIC PLAN SHEET 1 OF 2

GENERAL STAGE CONSTRUCTION AND TRAFFIC PLAN SHEET 2 OF 2

INDEX OF DRAWINGS

TYPICAL CROSS SECTIONS

INDEX MAP

INDEX MAP

KEY MAP

KEY MAP

LAYOUT

LAYOUT

LAYOUT

LAYOUT

LAYOUT

LAYOUT

LAYOUT

LAYOUT

li ayout LAYOUT

LAYOUT

PROF 1L

PROF ILE

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PROF IL

PROF IL PROF IL

PROF 1L

PROF IL

PROF IL

PROF 1 PROF II

PROF IL

ABBREVIATIONS, SYMBOLS AND NOTES

DRAWING TITLE

LINE 6

SHEET 1 OF 1

SHEET 1 OF 1

SHEET 1 OF 2

SHEET 2 OF 2

SHEET 1 OF 1

SHEET 1 OF 1

SHEET 1 OF 1

SHEET 1 OF 3

SHEET 3 OF 3

SHEET 2 OF 3

SHEET 3 OF 3

SHEET 1 OF

SHEET 2 OF 5

SHEET 3 OF 5 SHEET 4 OF 5

SHEET 5 OF 5

SHEET 1 OF : SHEET 2 OF 2

SHEET 1 OF 3

SHEET 2 OF 3

SHEET 3 OF 3

SHEET 1 OF 3 SHEET 2 OF 3 SHEET 3 OF 3

SHEET 1 OF 5

SHEET 2 OF 5 SHEET 3 OF 5

SHEET 4 OF 5 SHEET 5 OF 5

SHEET 1 OF 4 SHEET 2 OF 4 SHEET 3 OF 4

SHEET 4 OF 4

RECORD SET 15% DESIGN SUBMITTAL NOT FOR CONSTRUCTION





CALIFORNIA HIGH-SPEED TRAIN PROJECT MERCED TO FRESNO

AVE 21 HYBRID GENERAL INDEX OF DRAWINGS SHEET 1 OF 1

CONTRACT NO.
HSR06-007
DRAWING NO.
B6990-B
SCALE
NONE
SHEET NO.

OF

	-
AECOM	
Technical Services, Inc.	
2020 L Street, Suite 300 Sacramento, CA 95811	
011011111	

MISCELLANEOUS

TOR ΤK TYP TBD TF UPRR VAR V VERT

ALIGN	MENT
	HORIZONTAL
BC EC PC PCC PI POB POC POE POT PRC PT R V, DS	BEGINNING OF CURVE END OF CURVE POINT OF CURVE POINT OF COMPOUNT CURVES POINT OF INTERSECTION OF TWO TANGENTS POINT OF BEGINNING POINT ON CURVE POINT OF ENDING POINT ON TANGENT POINT OF REVERSE CURVES POINT OF TANGENCY RADIUS OF CURVATURE IN FEET DESIGN VELOCITY IN MILES PER HOUR
BVC EVC PVC PVI PVT VC	VERTICAL BEGIN OF VERTICAL CURVE END OF VERTICAL CURVE POINT OF VERTICAL CURVE (BEGINNING OF CURVE) POINT OF VERTICAL INTERSECTION (OF TANGENTS) POINT OF VERTICAL TANGENCY (ENDING OF CURVE) VERTICAL CURVE

	MISCELLANEOUS
ALT	ALTERNATIVE
AVE	AVENUE
BB	BEGIN BRIDGE
BEG	BEGIN
BLVD	BOULEVARD
¢	CENTER LINE
CL	CENTERLINE, CLASS
CLR	CLEAR
COL	COLUMN
DWG	DRAWING
EB	END BRIDGE
ELEV	ELEVATION
EQ	EQUATION
ES	EDGE OF SIDEWALK
ETW	EDGE OF TRAVELED WAY
EXIST(E)	EXISTING
FL	FLOW LINE
HORIZ	HORIZONTAL
HP	HINGE POINT
HST	HIGH SPEED TRAIN
HWY	HIGHWAY
IC	INTERCHANGE
IN	INCH
L	LENGTH
LT	LEFT
MBGR	METAL BEAM GUARD RAIL
ML	MAINLINE
MPH	MILES PER HOUR
MAX	MAXIMUM
MIN	MINIMUM
N	NORTH NORTH ROUND
NB	NORTH BOUND
No, NO NTS	NUMBER NOT TO SCALE
OG	ORIGINAL GROUND
0/H OH	OVERHEAD
PG&E	PACIFIC GAS & ELECTRIC
PGL, FG	PROFILE GRADE LINE
RET	RETAINING
RR	RAILROAD
RD	ROAD
R/W	RIGHT OF WAY
RT	RIGHT
SB	SOUTH BOUND
SHLD	SHOULDER

TOP OF TRACK	RAIL
TELECOM OPTIC	='

	MATCH LINE
	HST TRACK
	PROPOSED HST RIGHT-OF-WAY
	FREIGHT/PASSENGER TRACK - EXISTING
	EXISTING OR EXISTING RIGHT-OF-WAY BRIDGE FEATURES
	RETAINING WALLS
	ORIGINAL GROUND
———— G16 ————	GAS LINE (16")
—TC ——	COMMUNICATION LINE
w	WATER LINE
—— FO —— ——	FIBER OPTIC LINE
	ELECTRICAL LINE
X	ELECTRICAL TOWER
S	SEWER LINE
	STORM DRAIN LINE
	FUEL LINE
—TC——	TELEPHONE LINE
P12	PETROLEUM LINE (12")
——— (OH) ———	OVERHE AD
	NORTH ARRROW
<u> </u>	PVI
	MBGR
->	DIRECTION OF TRAVEL
250	PROPOSED CONTOUR

, V								
7/0		•					DESIGNED BY R. LI	Γ
							DRAWN BY A. TRINH	1
							CHECKED BY	1
							A. SILVER	ł
9							A. BOONE	1
dye	REV	DATE	BY	СНК	APP	DESCRIPTION	DATE 06/30/2011	L

RECORD SET 15% DESIGN SUBMITTAL NOT FOR

CONSTRUCTION

STATE ROUTE

SANITARY SEWER

STOPPING SIGHT DISTANCE

SHEET

STREET

STATION

STRUCT, STR STRUCTURE

STANDARD

TANGENT

TELEPHONE

(OH) OVERHEAD LINE (UG) UNDERGROUND LINE

STORM DRAIN

SR

SHT

SS

SSD

ST

STA

STD

SD

TEL

2020 L Street, Suite 300 Sacramento, CA 95811 CH2MHILL





CALIFORNIA HIGH-SPEED TRAIN PROJECT MERCED TO FRESNO


AVE 21 HYBRID GENERAL ABBREVIATIONS, SYMBOLS AND NOTES SHEET 1 OF 1


CONTRACT NO. HSRO6-007						
DRAWIN	ю NO. Вб	992-B				
SCALE	NO	SCALE				


SHEET NO. ### OF ###

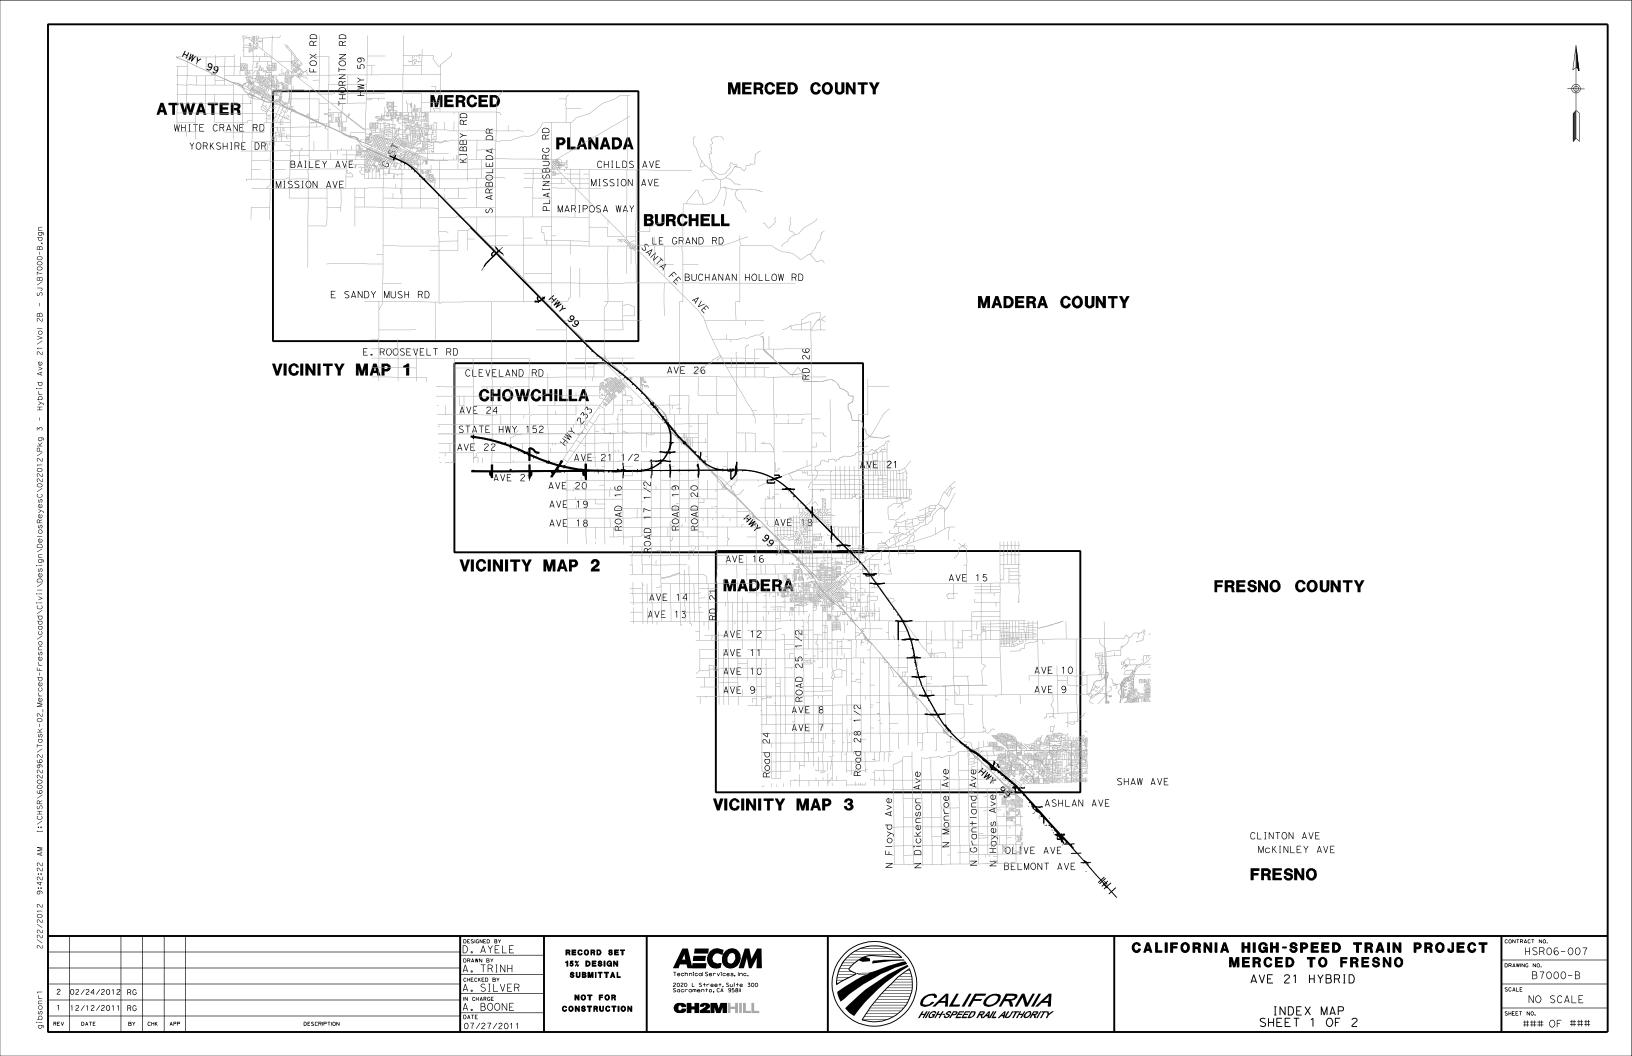


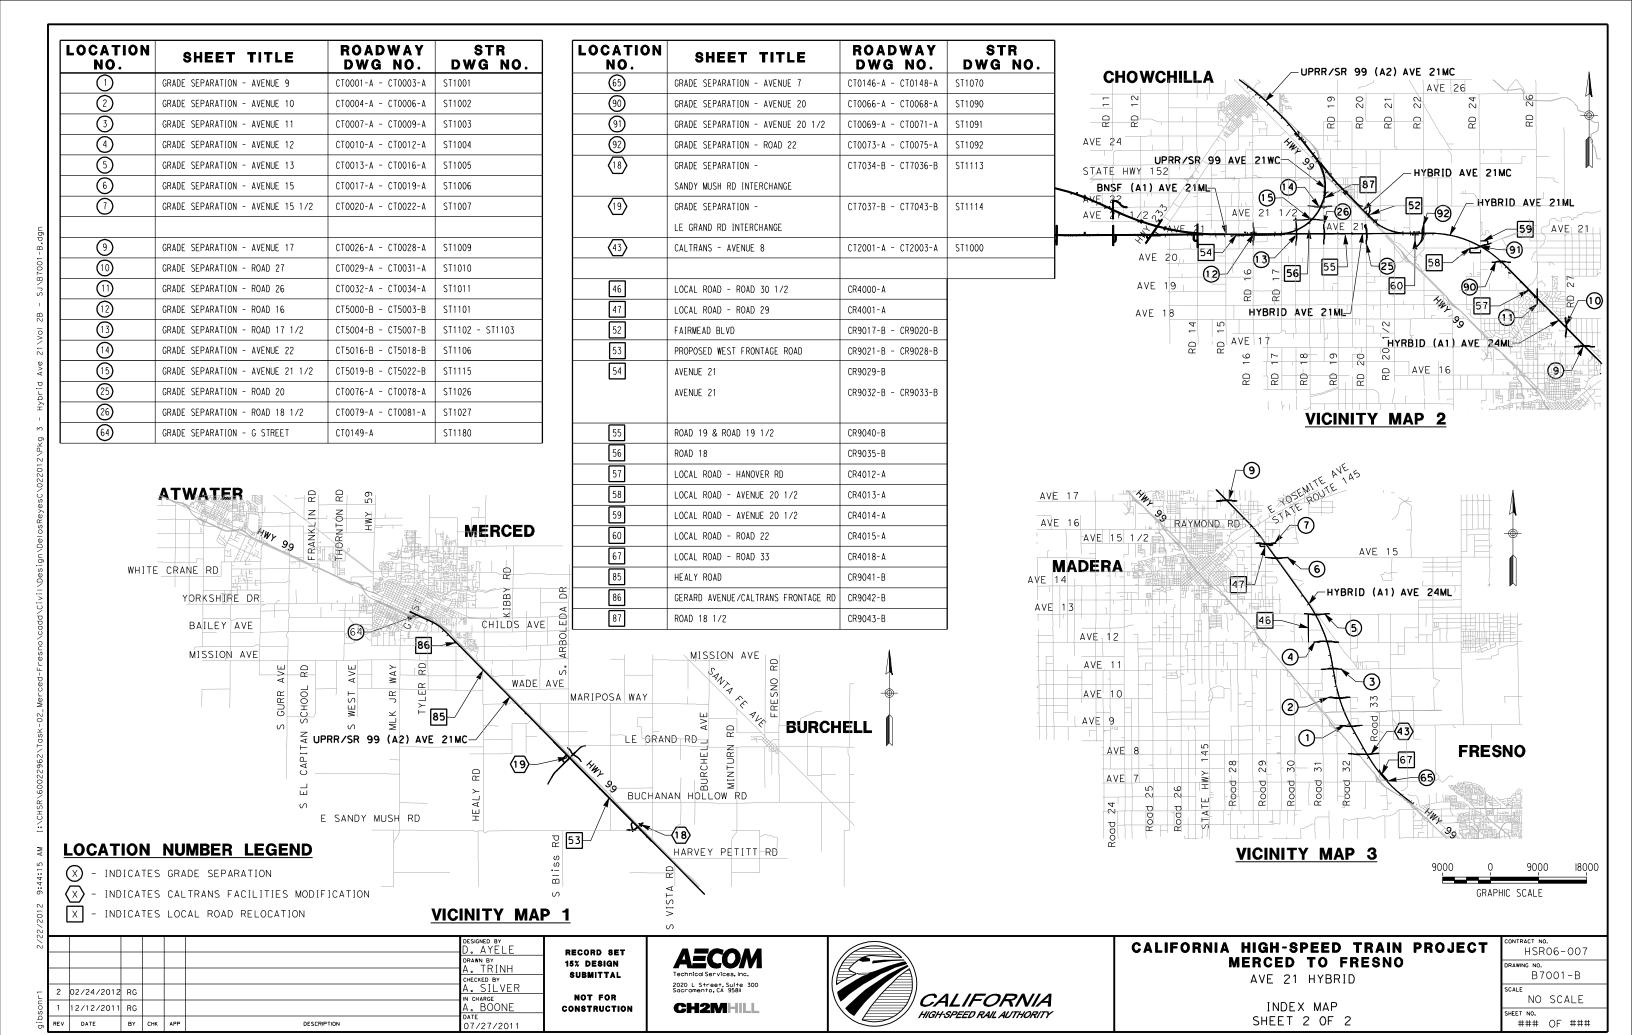


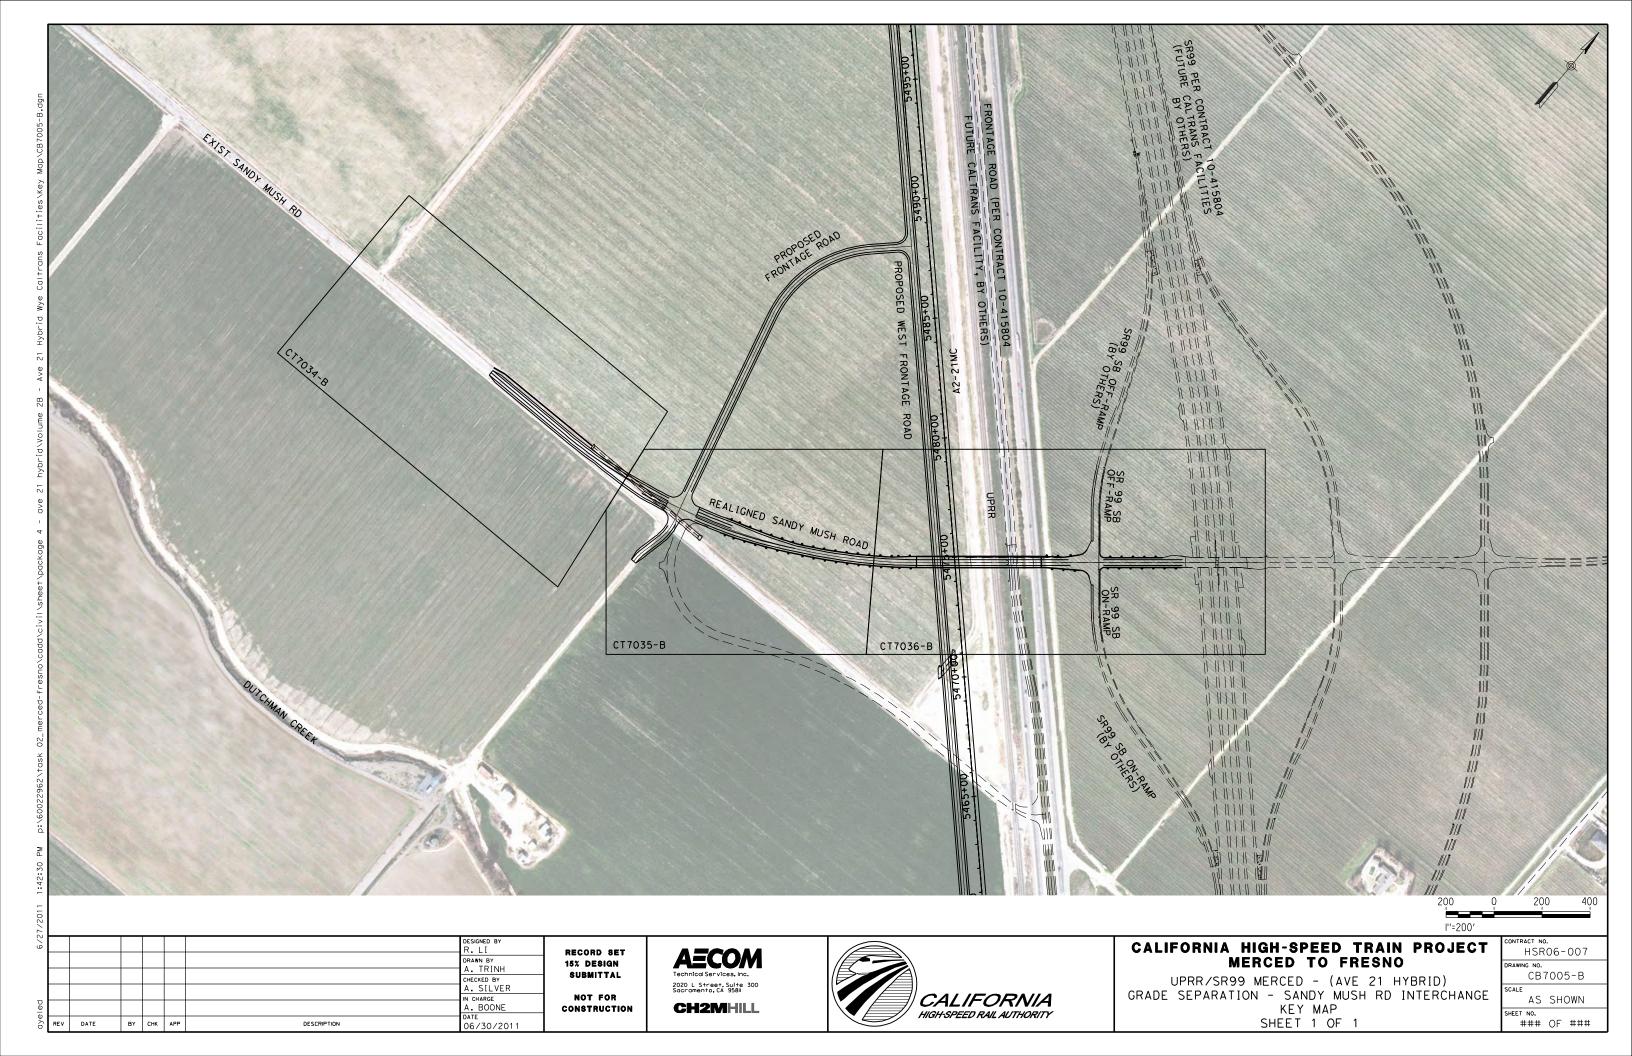

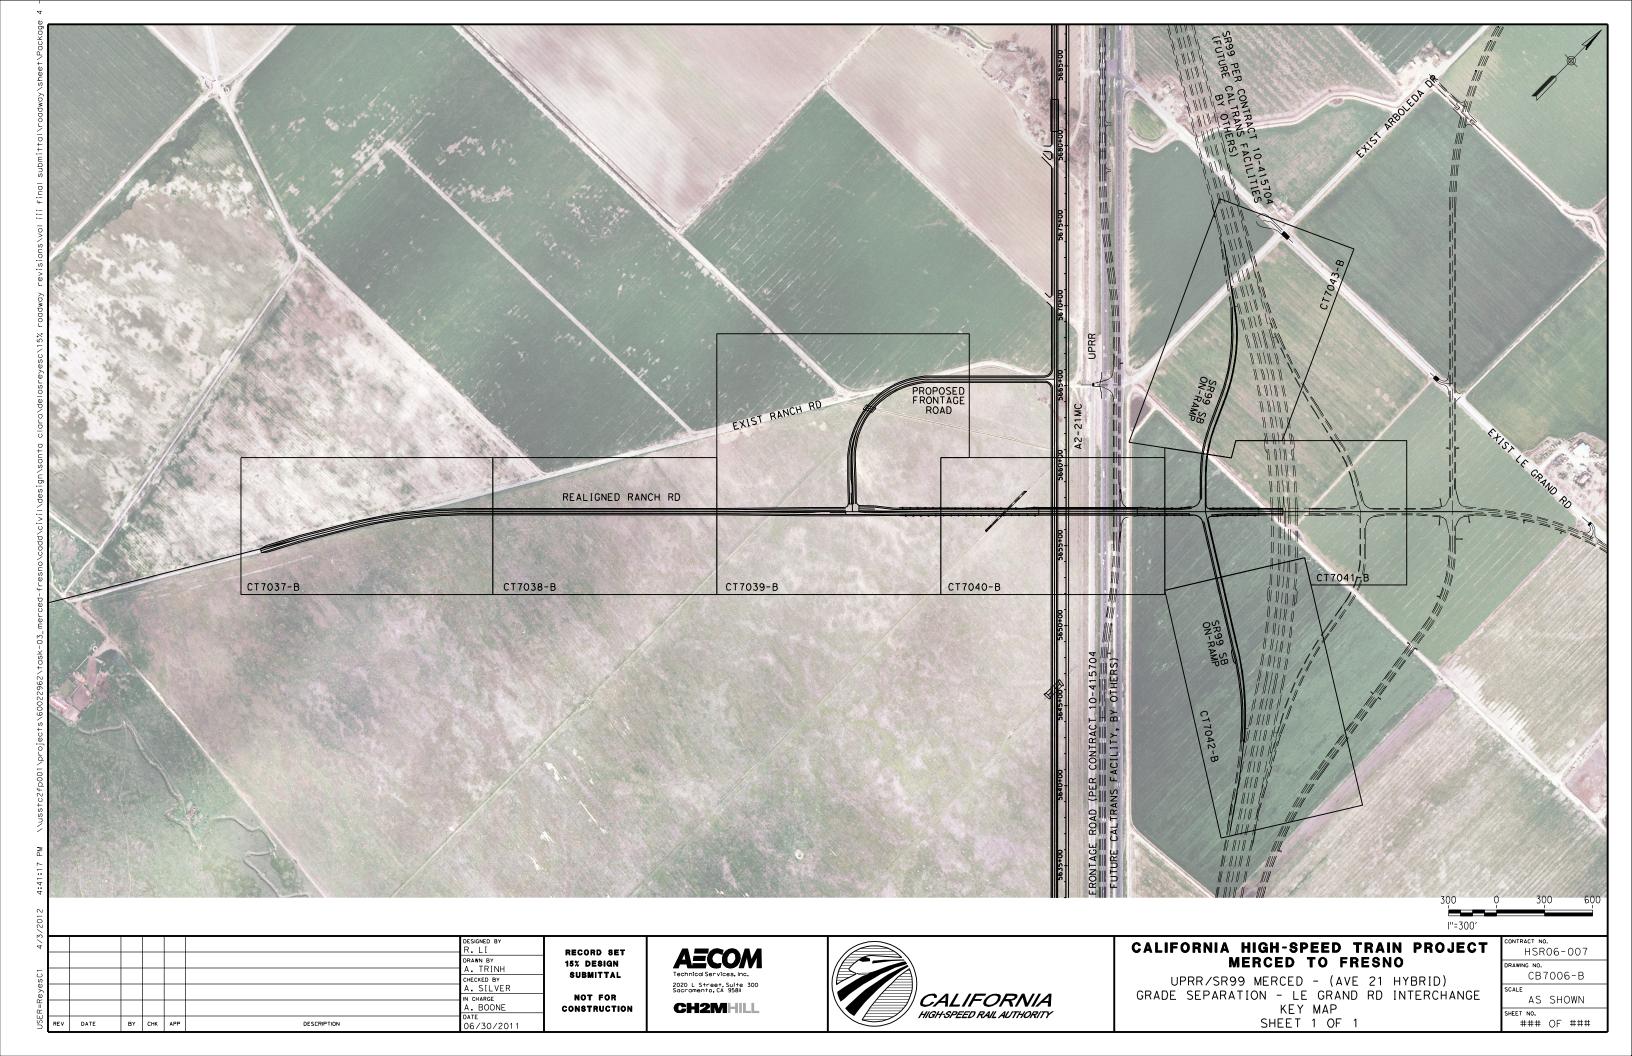

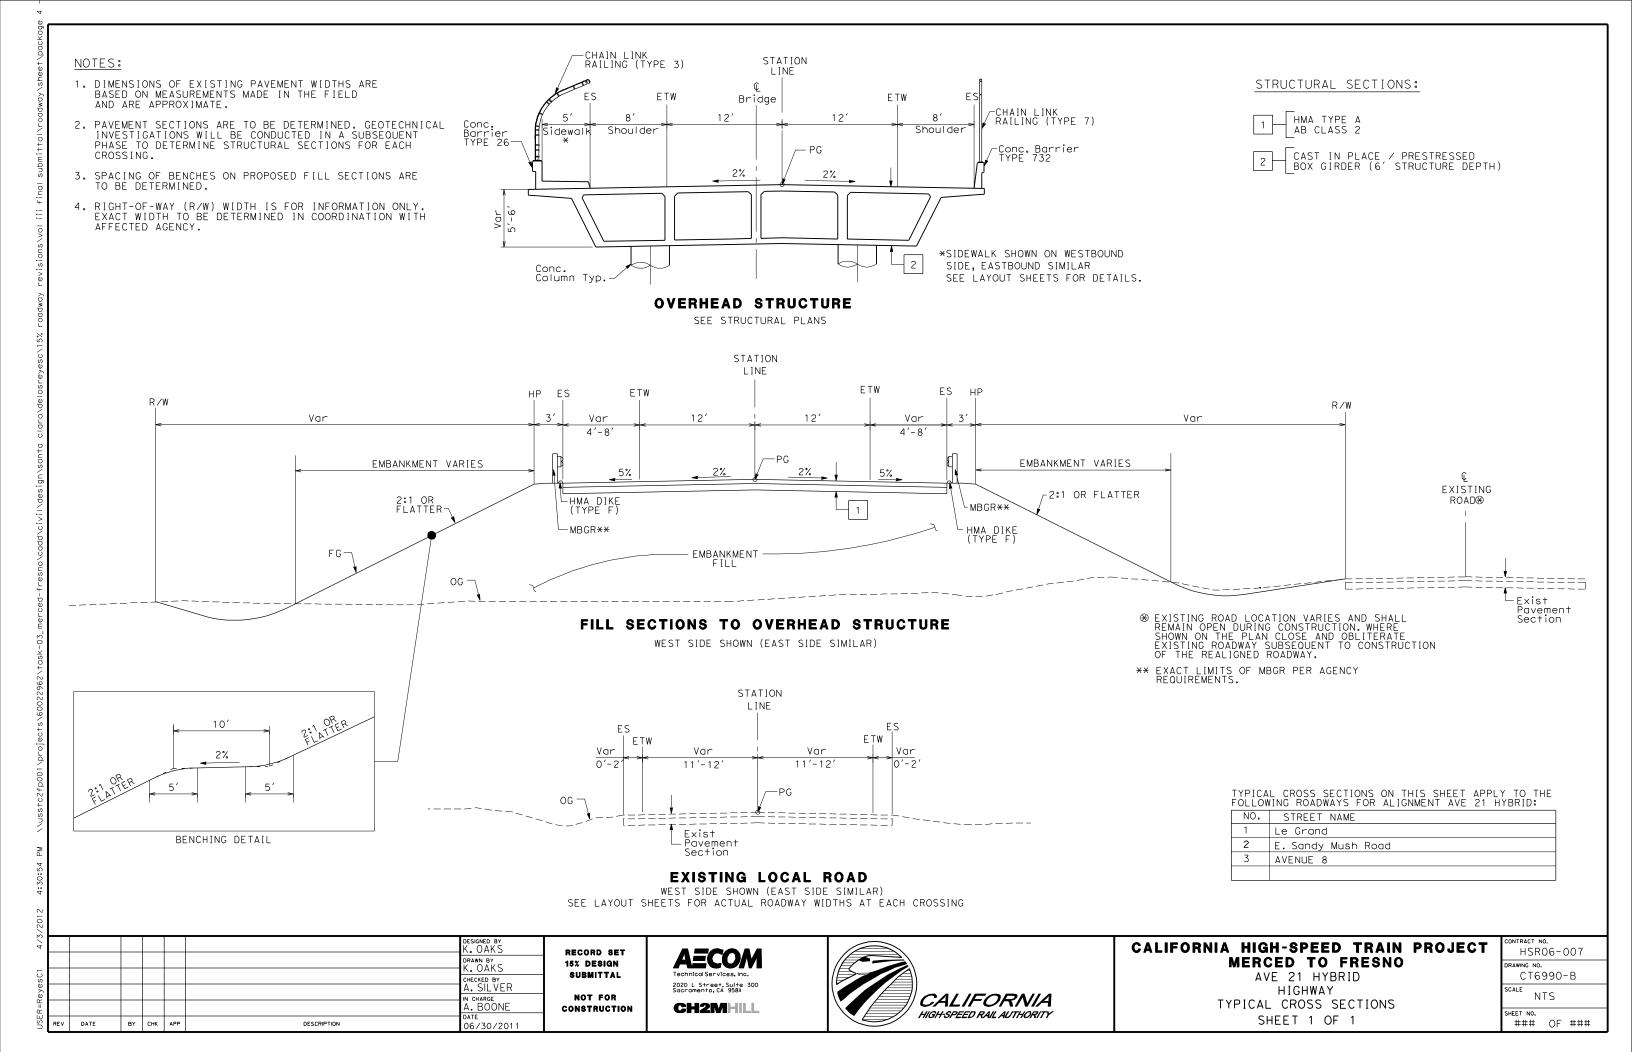


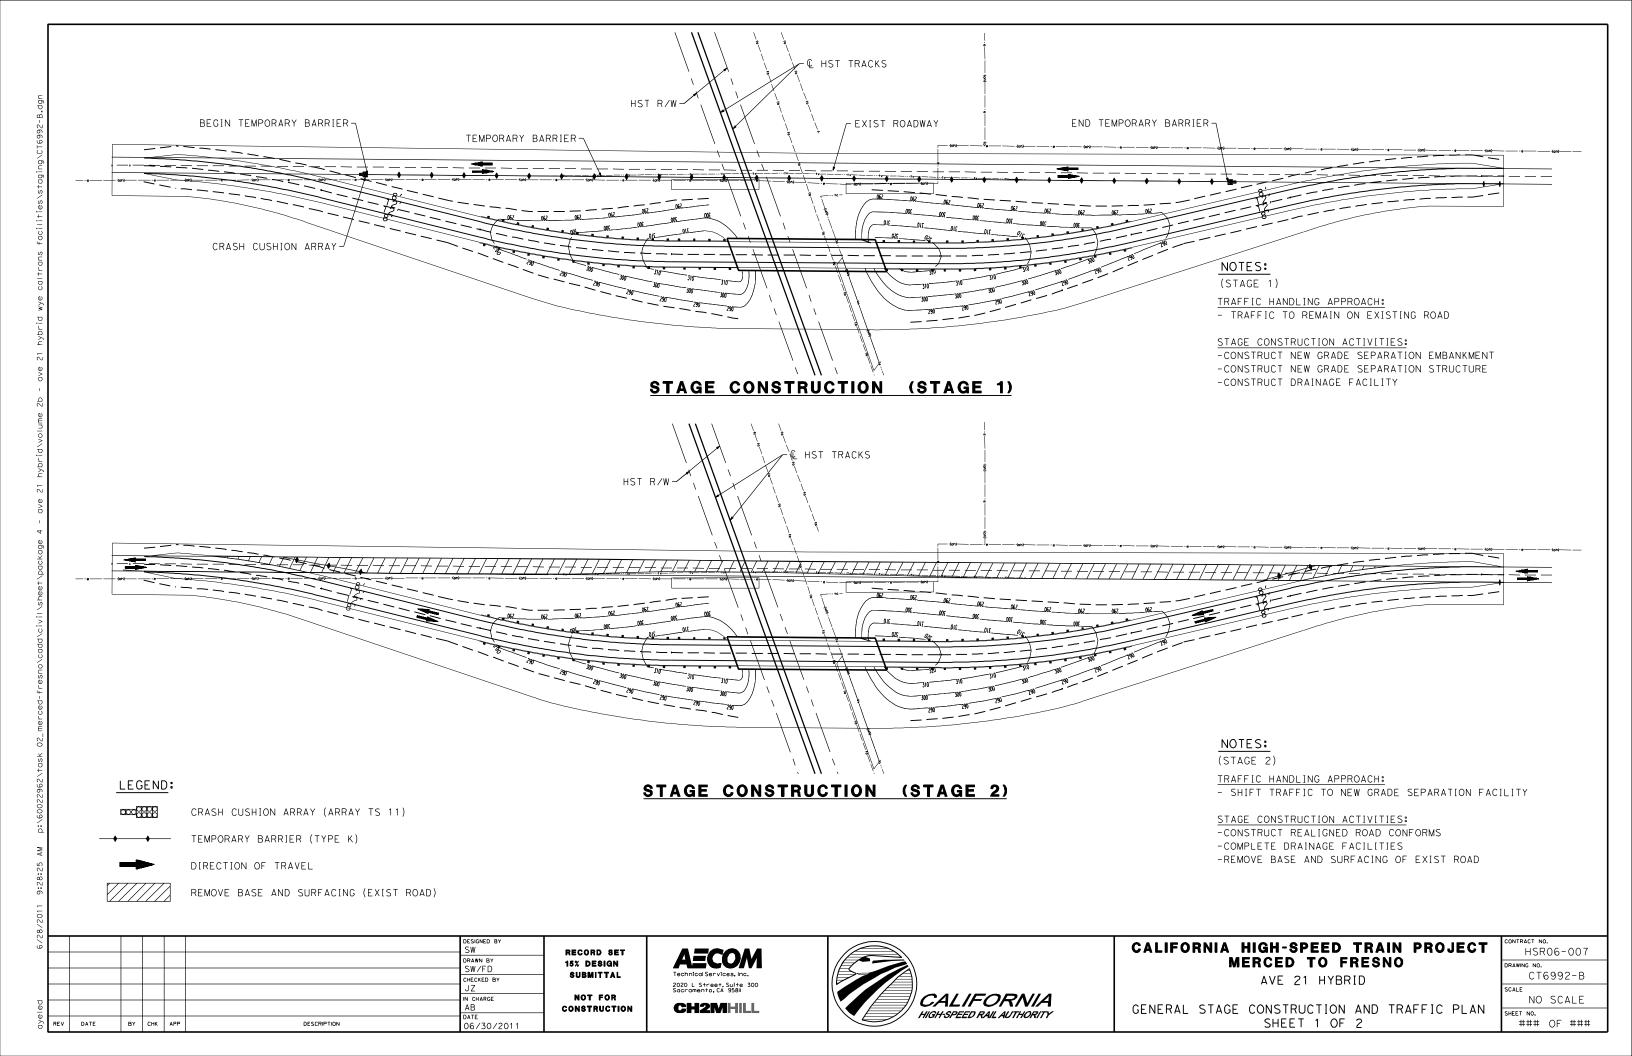


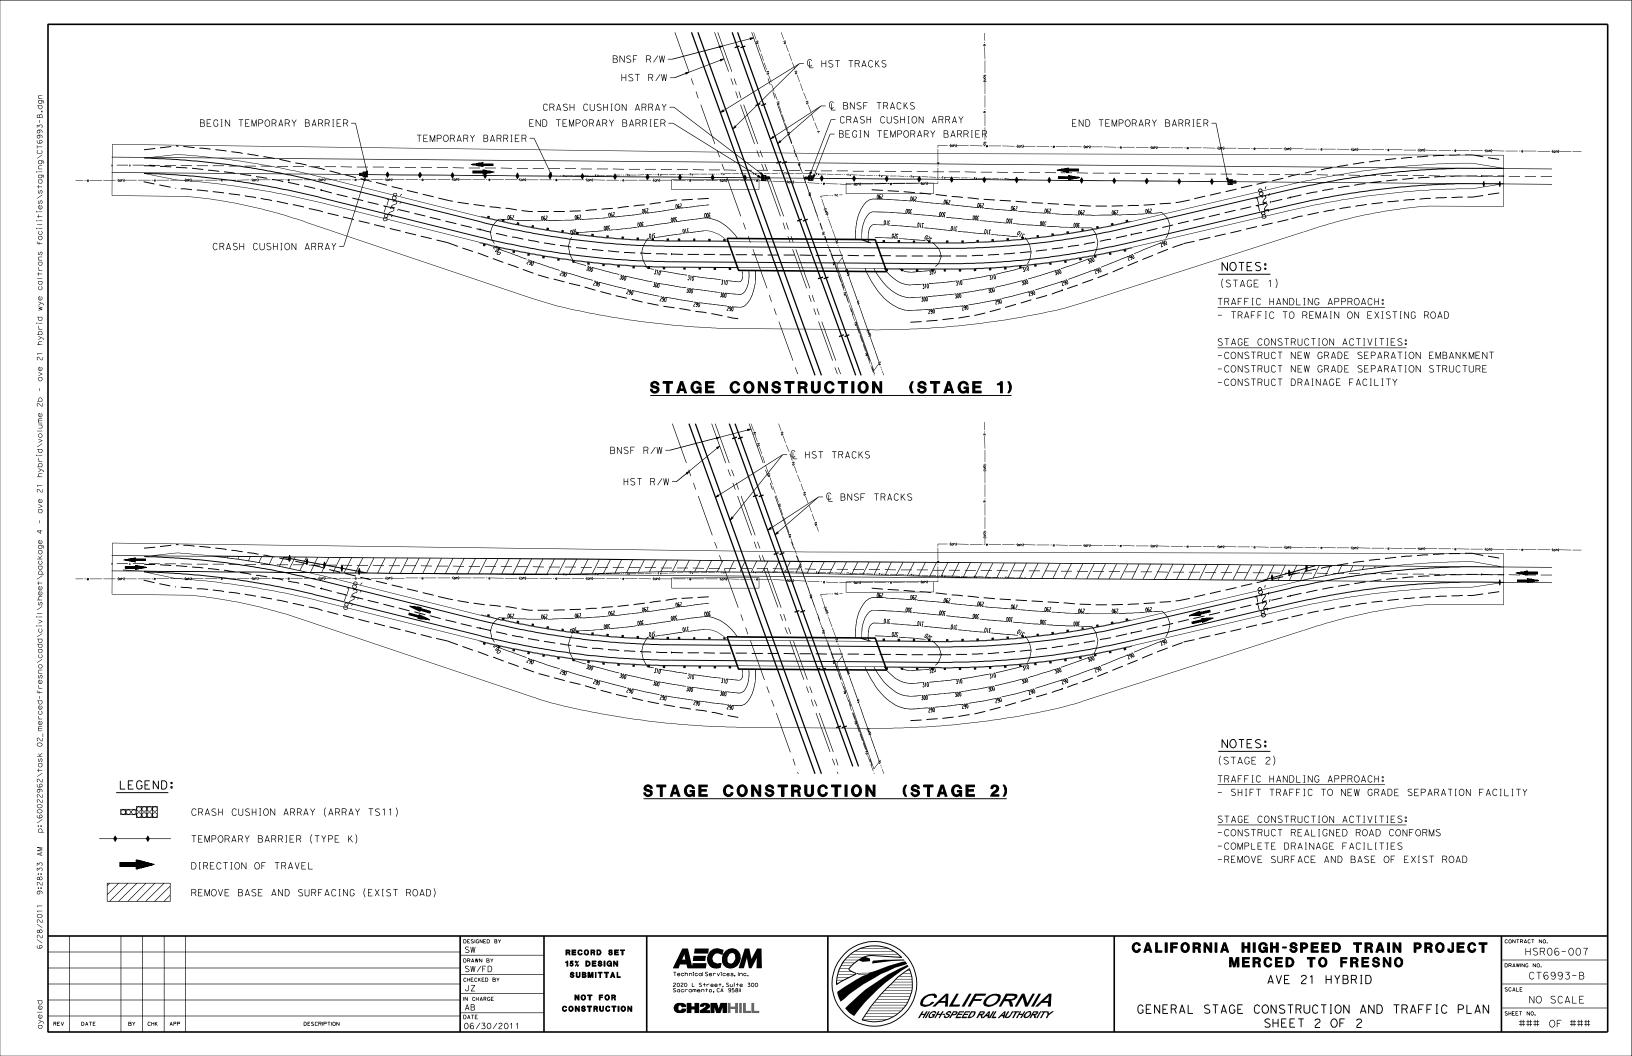

BY CHK APP


DESCRIPTION

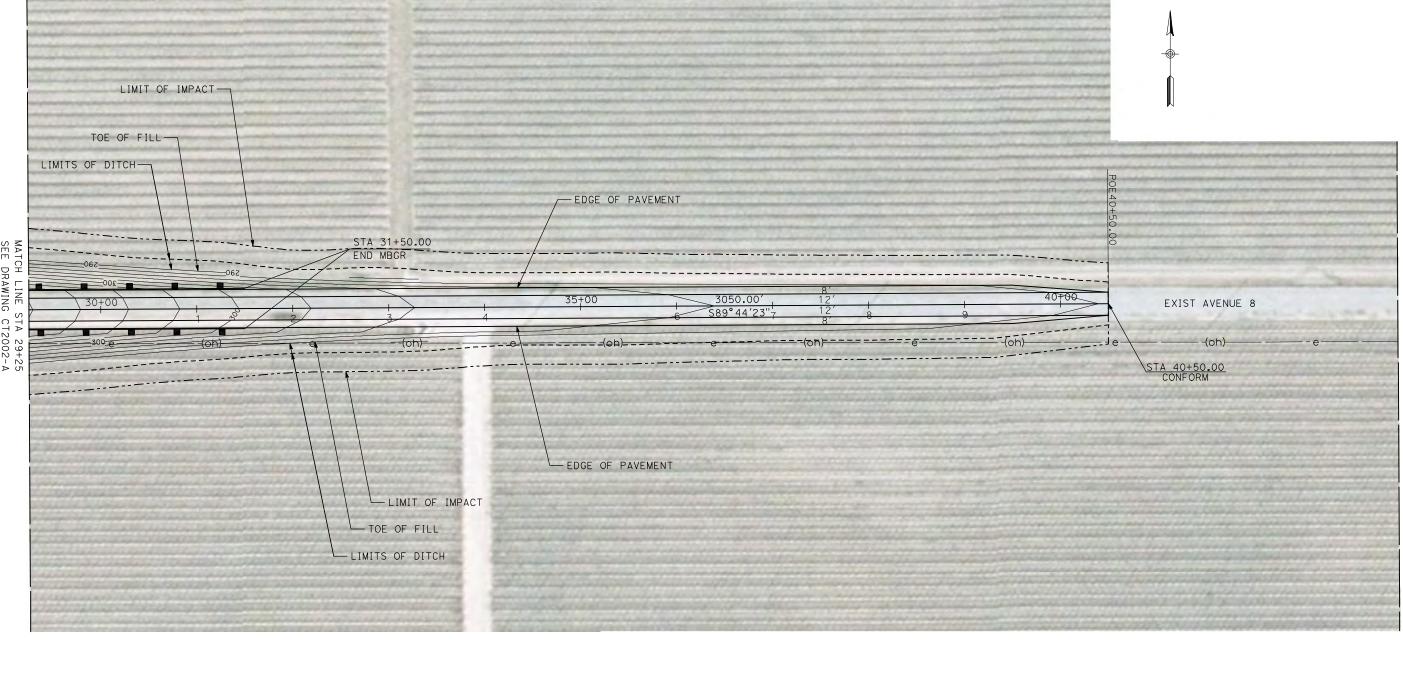

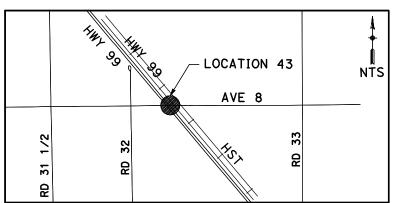

NOTE:

1. FOR ROADWAY PROFILE, SEE DRAWINGS CT3001-A THROUGH CT3003-A.

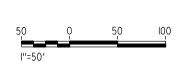

						DESIGNED BY R. GIBSON
						DRAWN BY H. PHAN
						CHECKED BY A. SILVER
						IN CHARGE A. BOONE
REV	DATE	BY	СНК	APP	DESCRIPTION	DATE 06/30/2011

RECORD SET
15% DESIGN
SUBMITTAL
NOT FOR
CONSTRUCTION







CALIFORNIA HIGH-SPEED TRAIN PROJECT MERCED TO FRESNO


BNSF MAIN LINE - (AVE 21 HYBRID)
GRADE SEPARATION - AVENUE 8
LAYOUT
SHEET 3 OF 3


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DRAWING NO. CT2003-A					
SCALE AS SHOWN					


AS SHOWN
SHEET NO.
OF

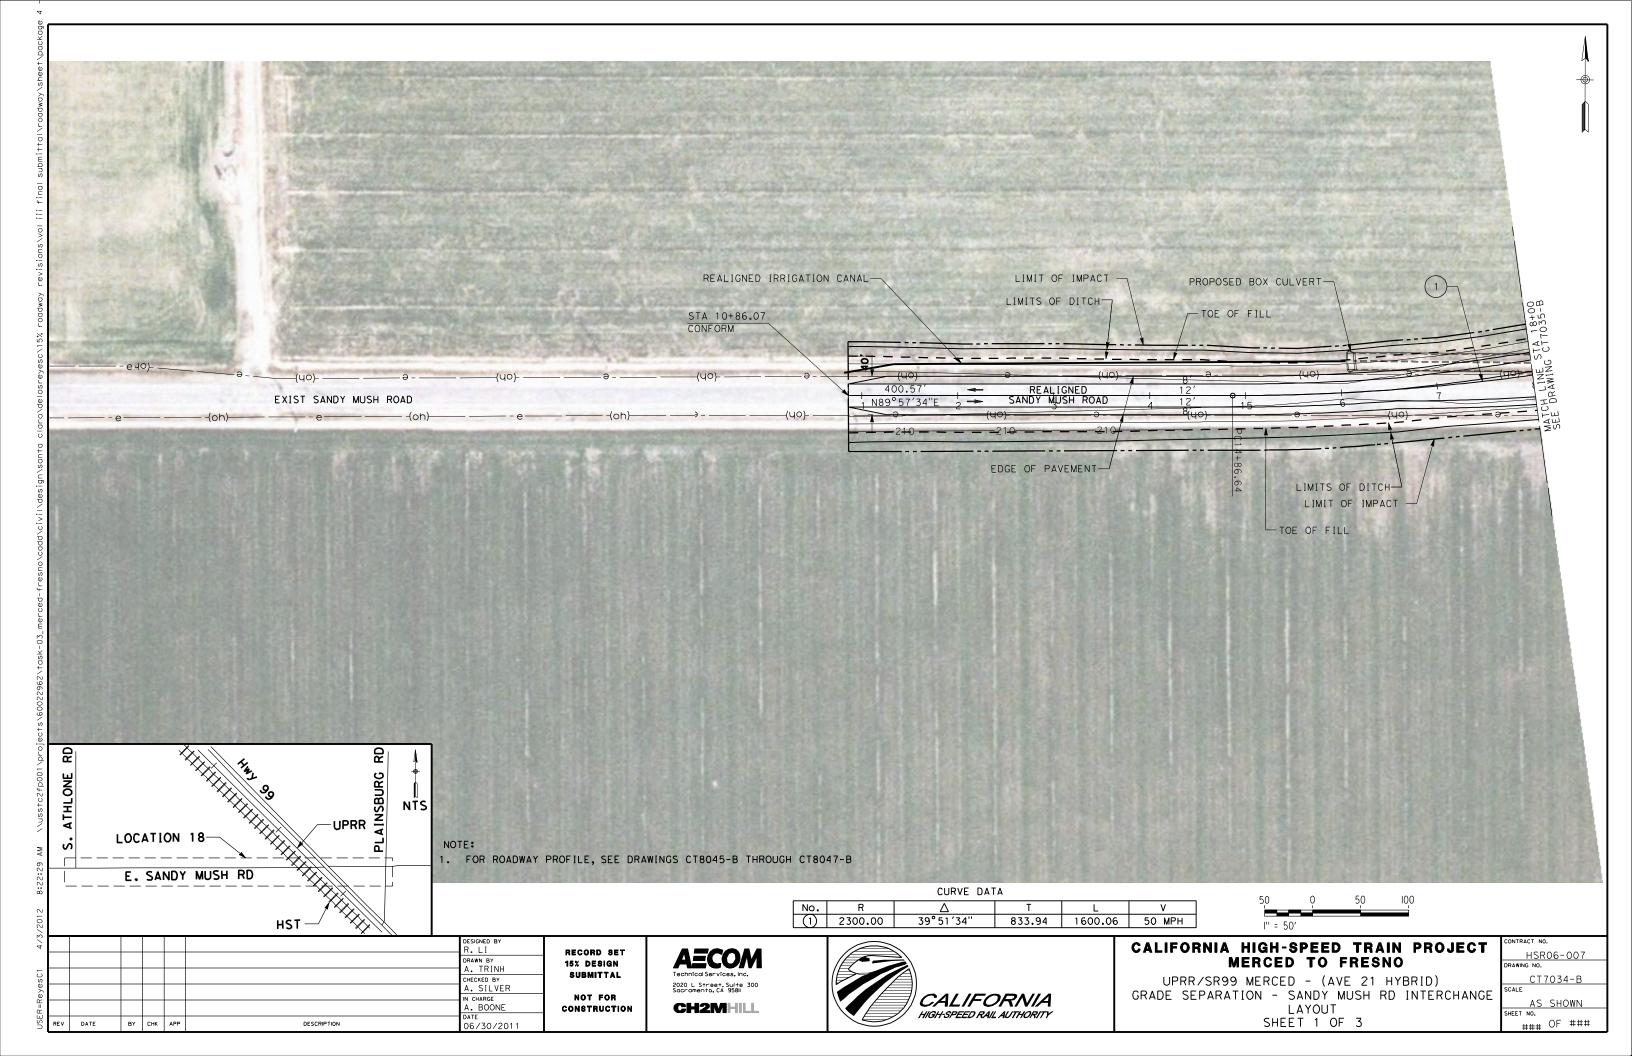


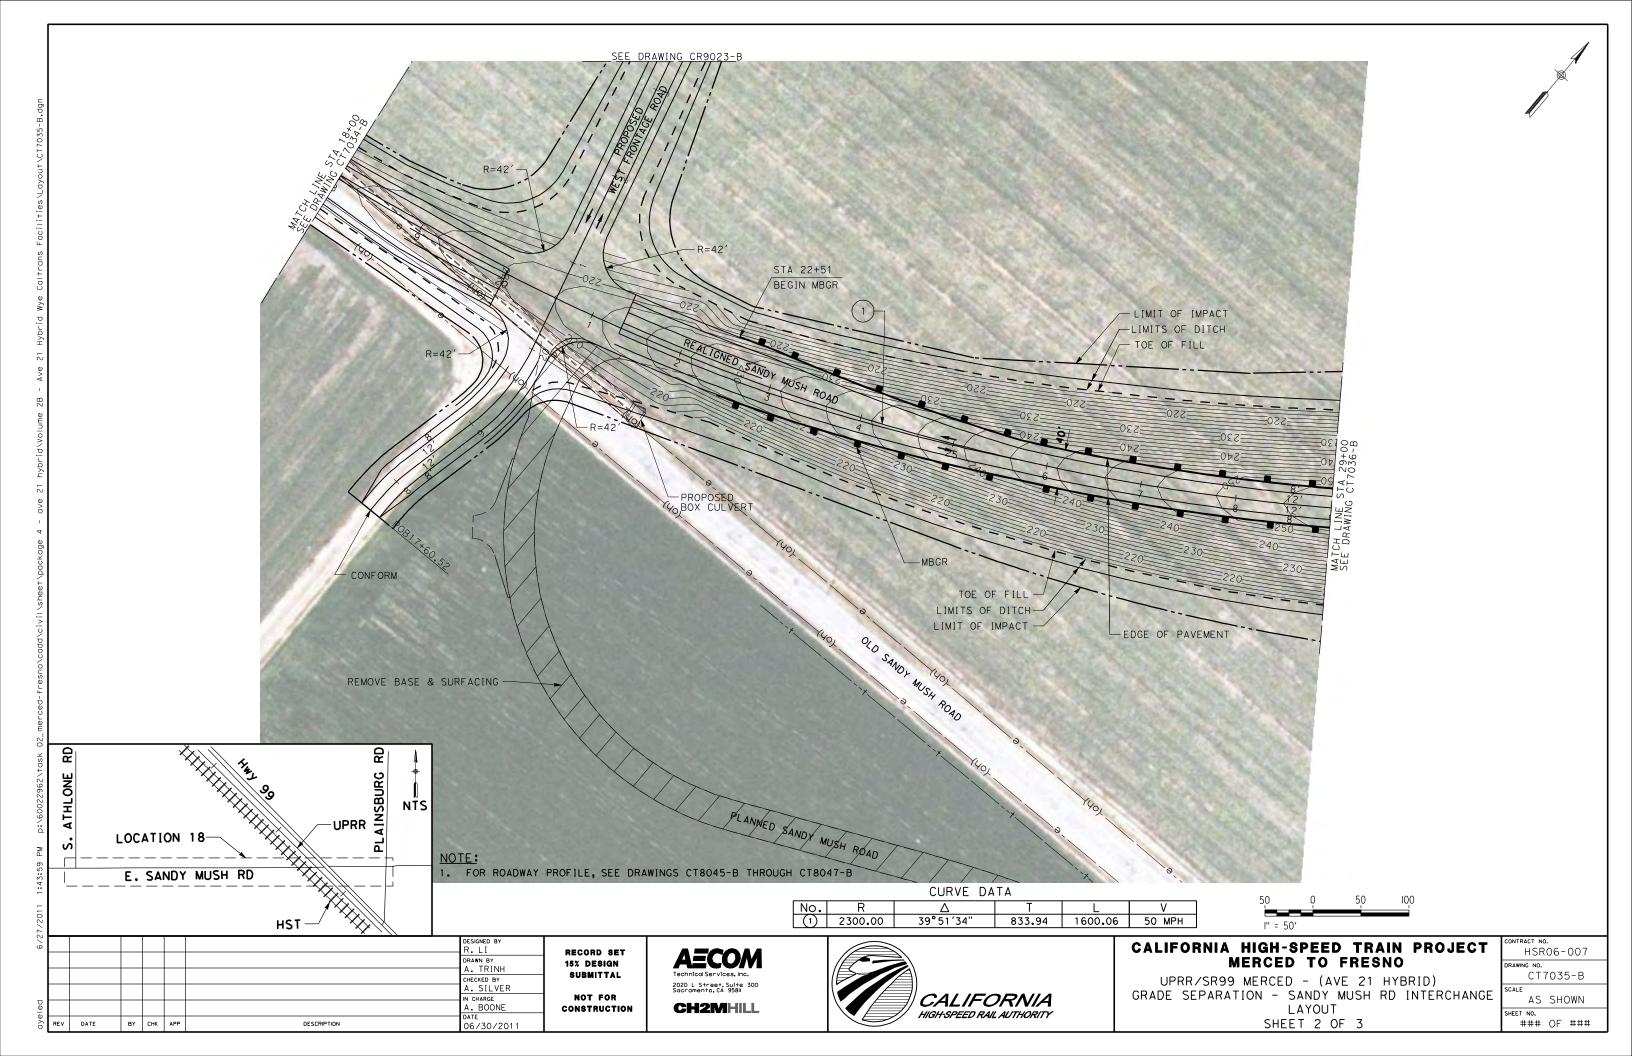


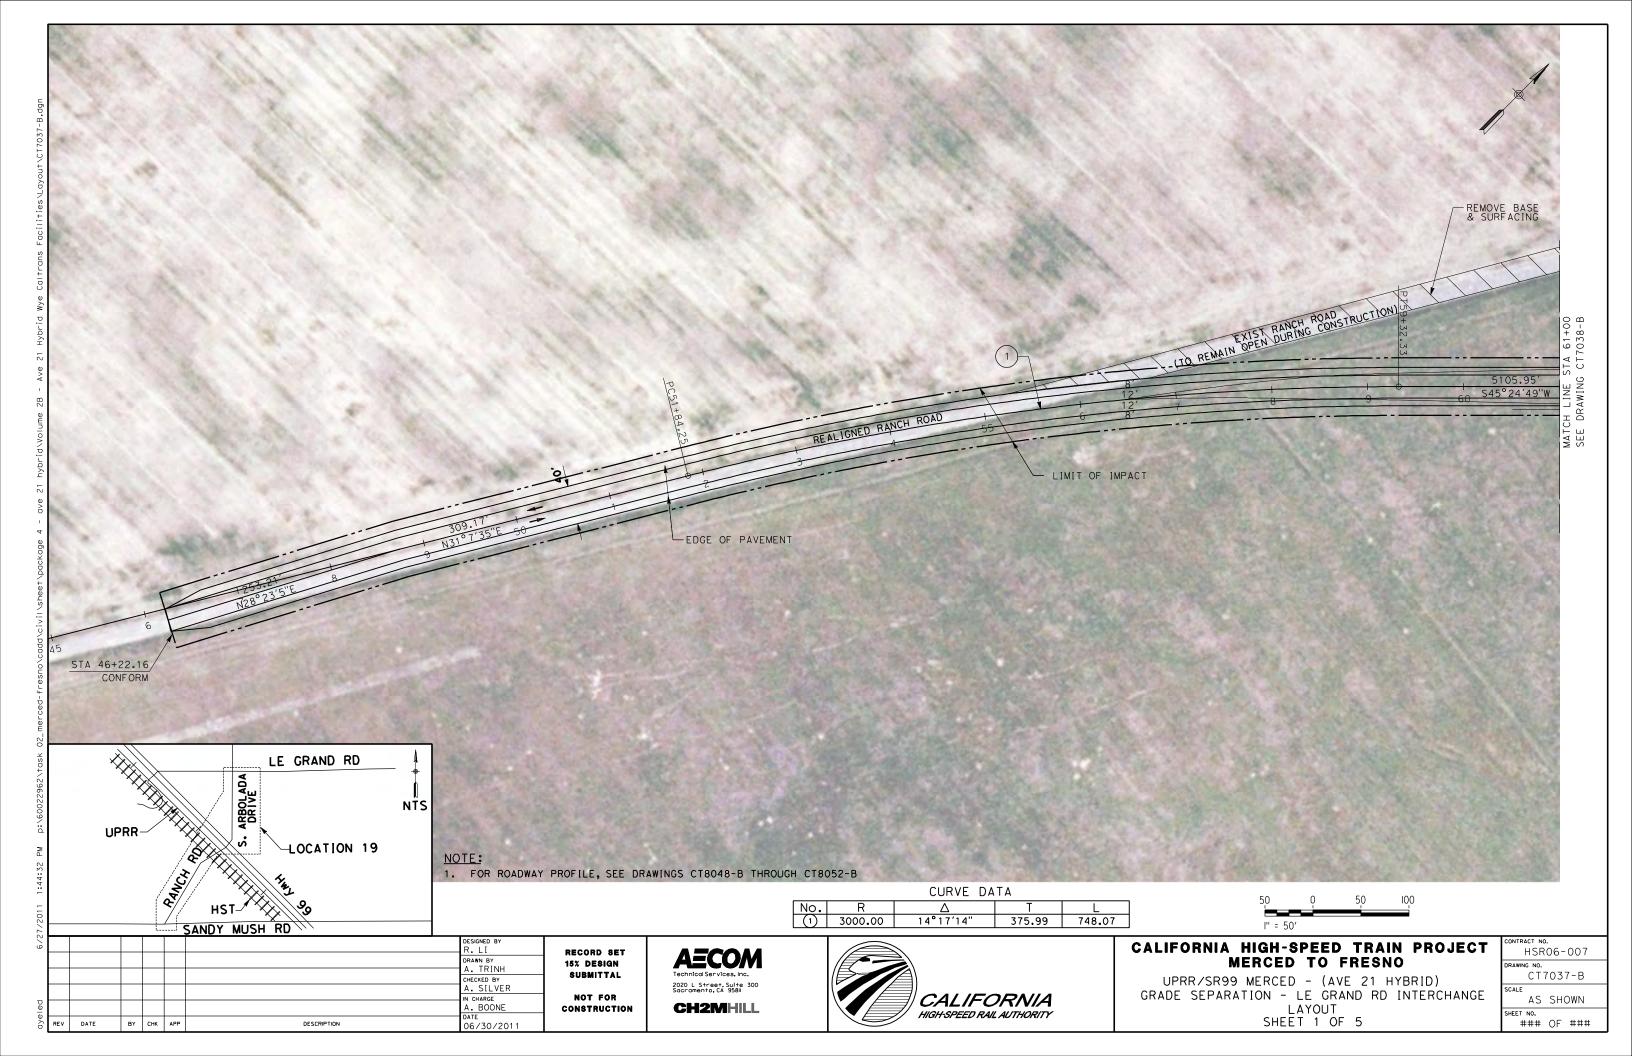


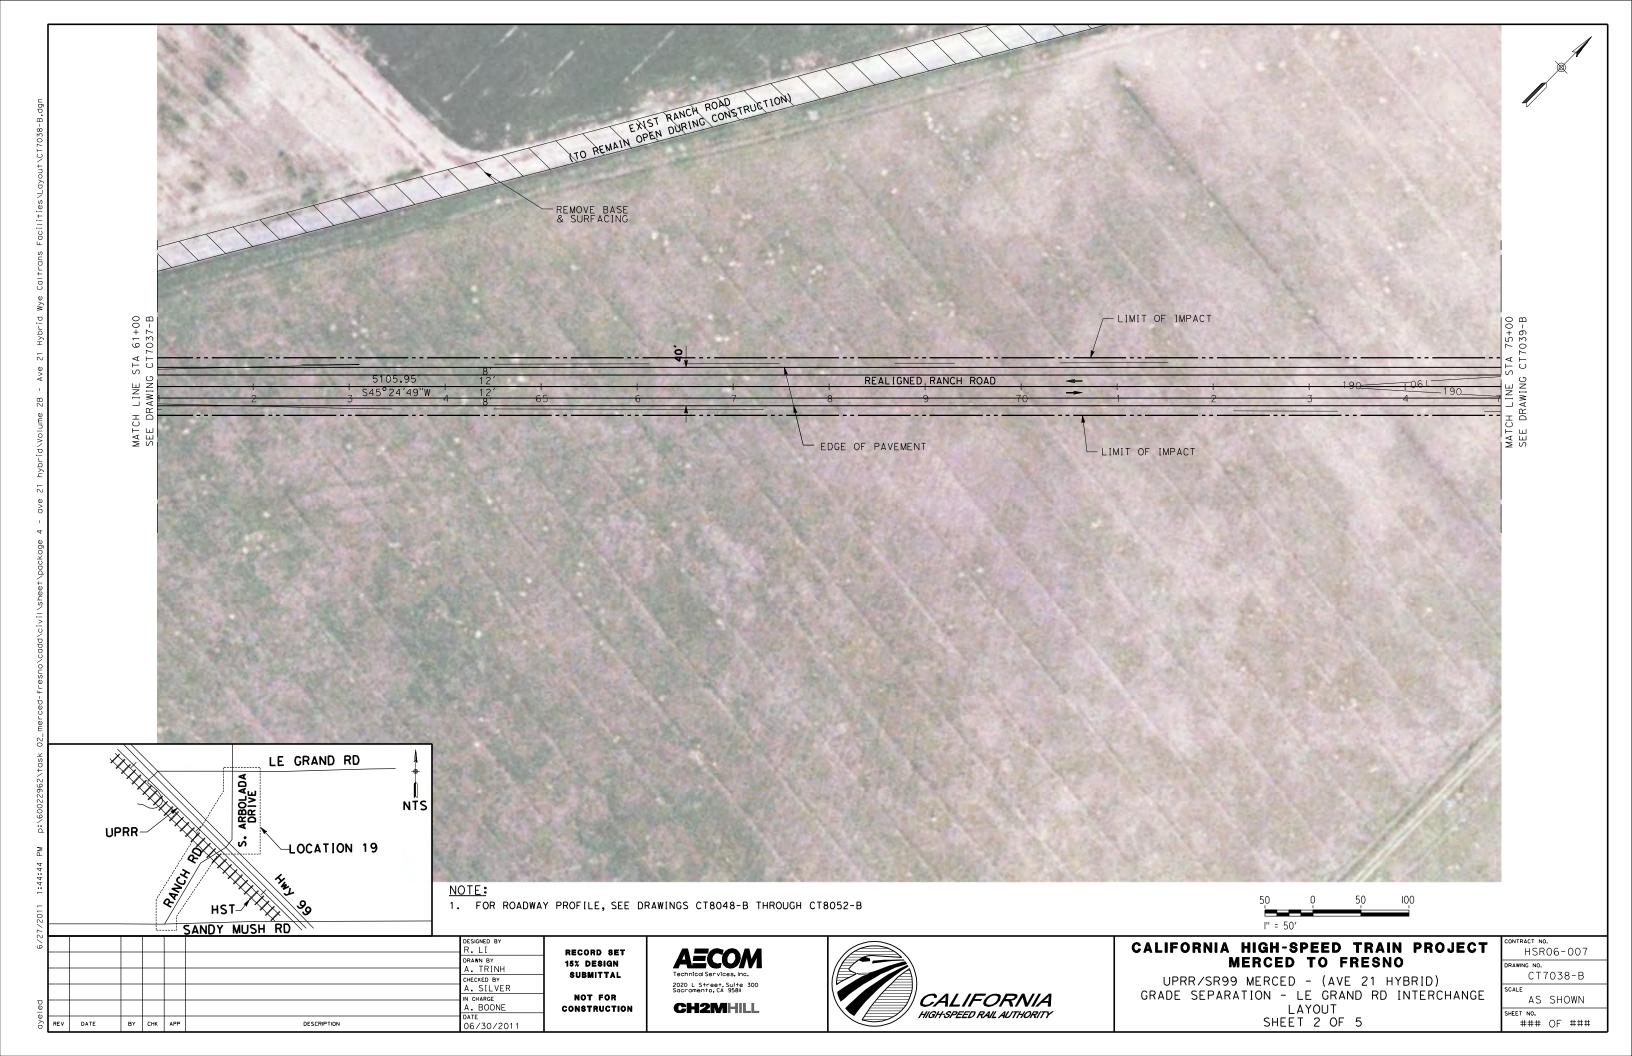

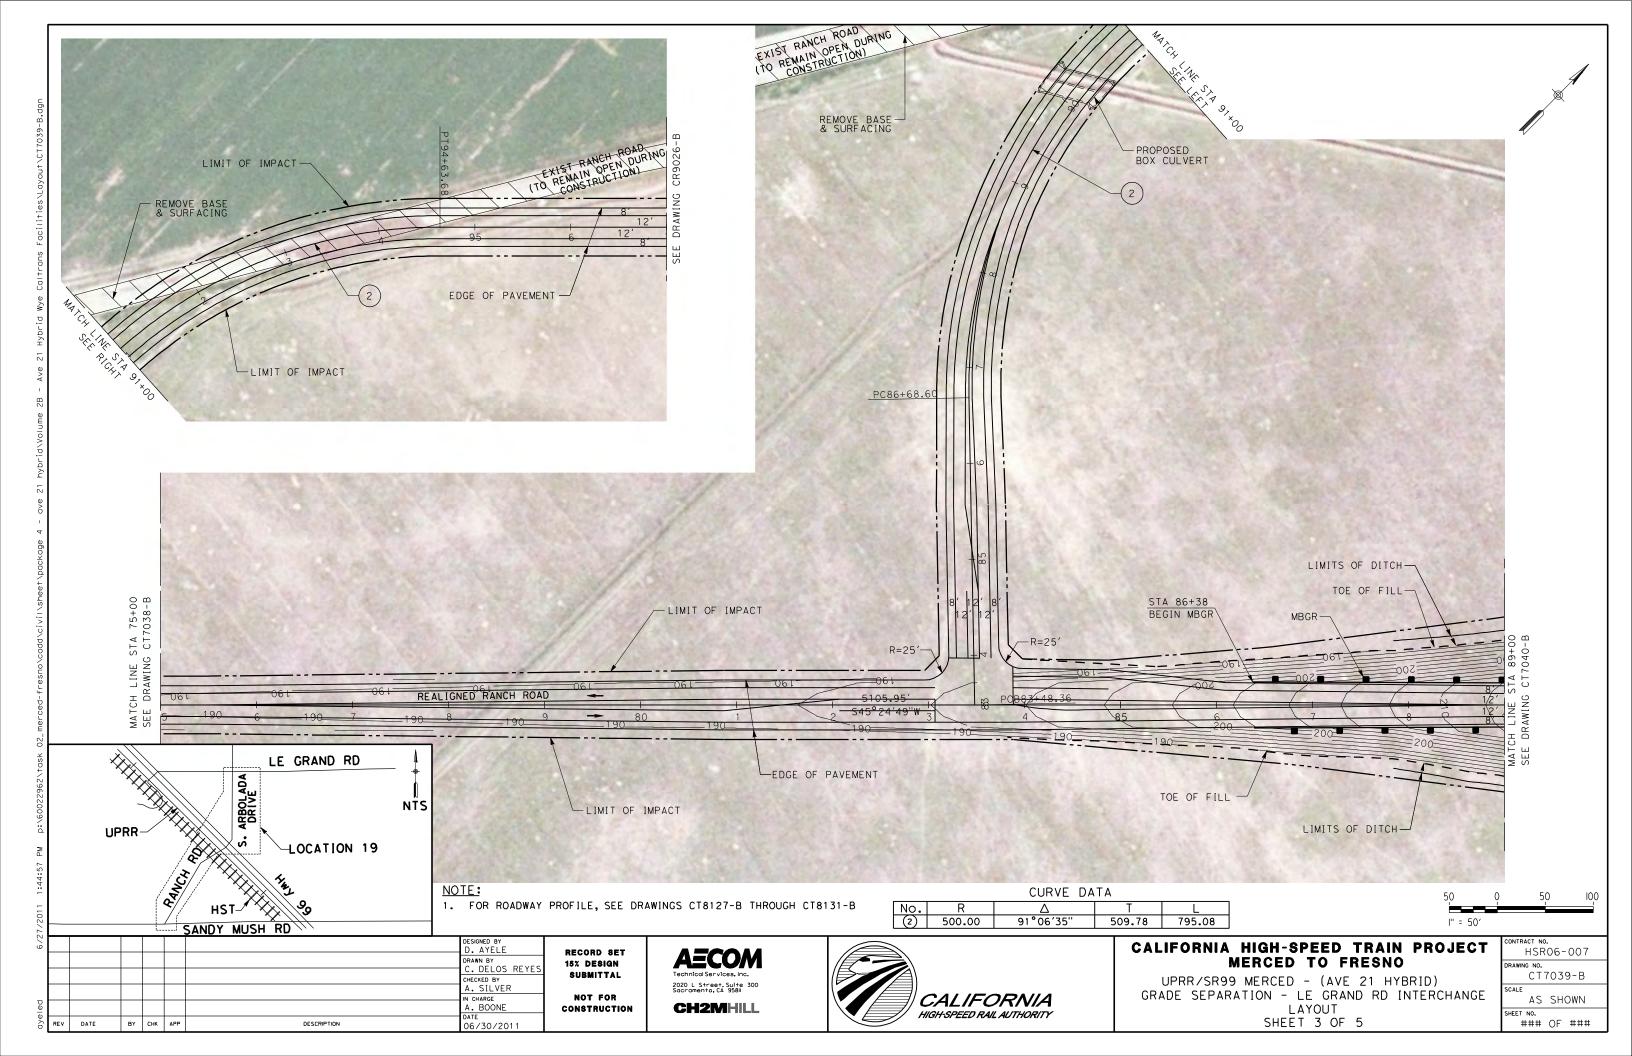

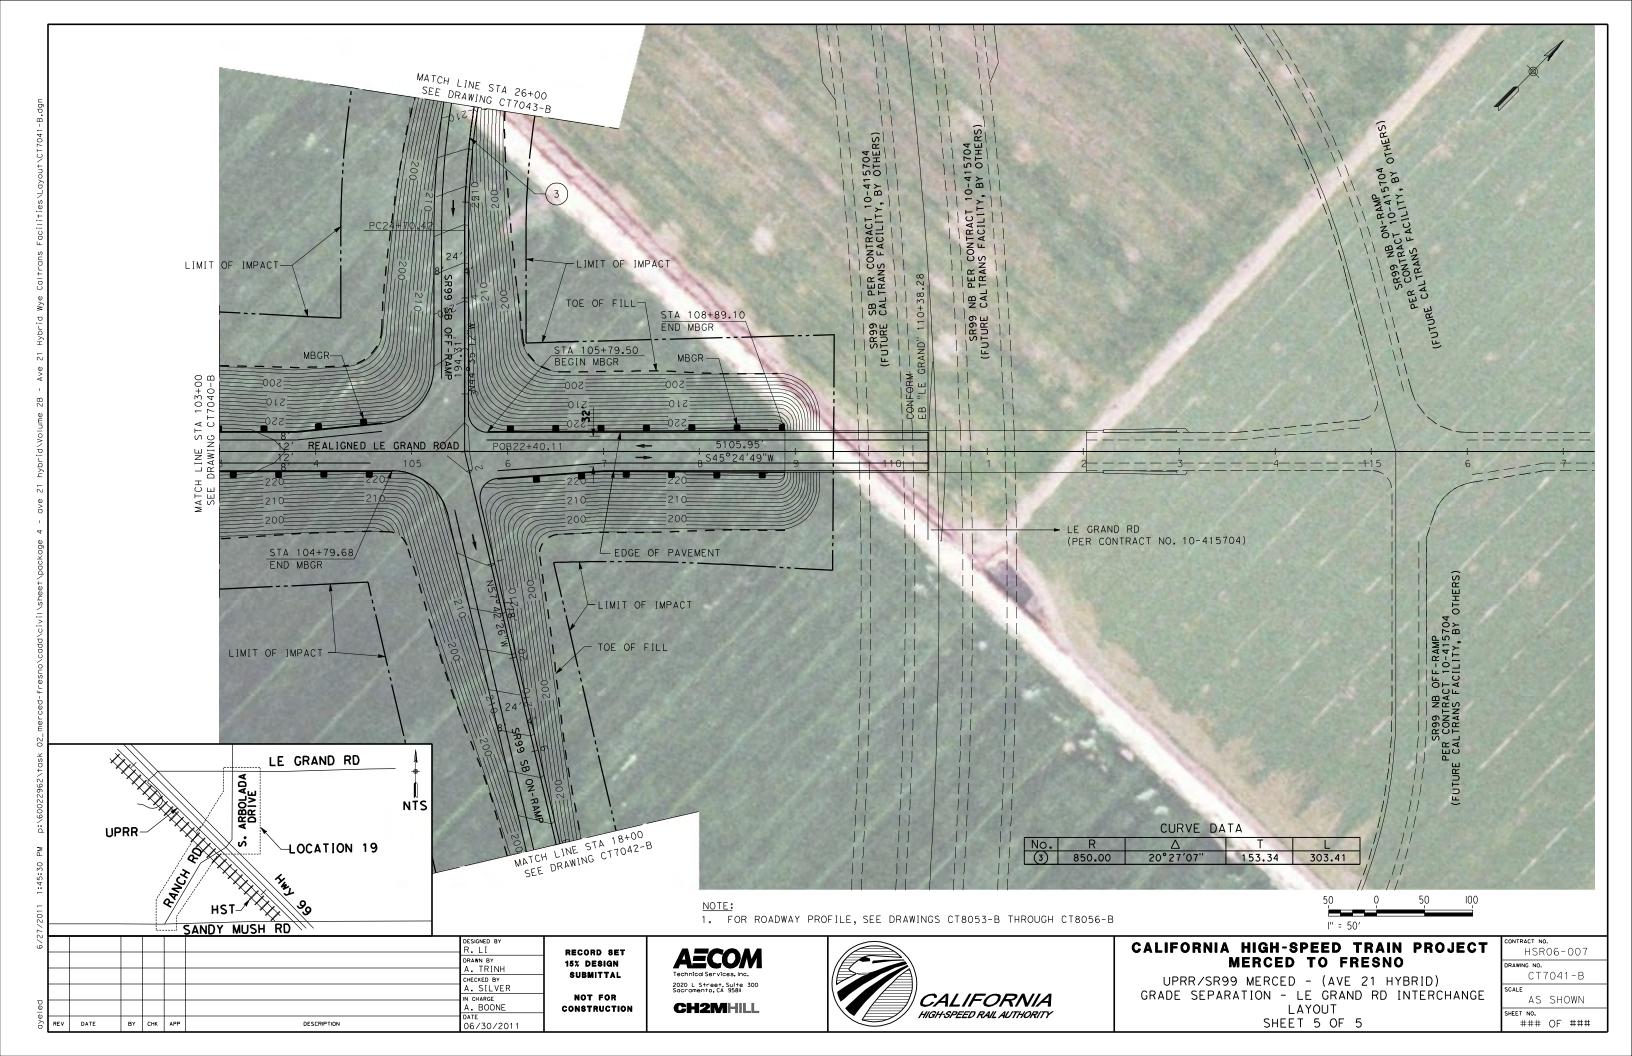

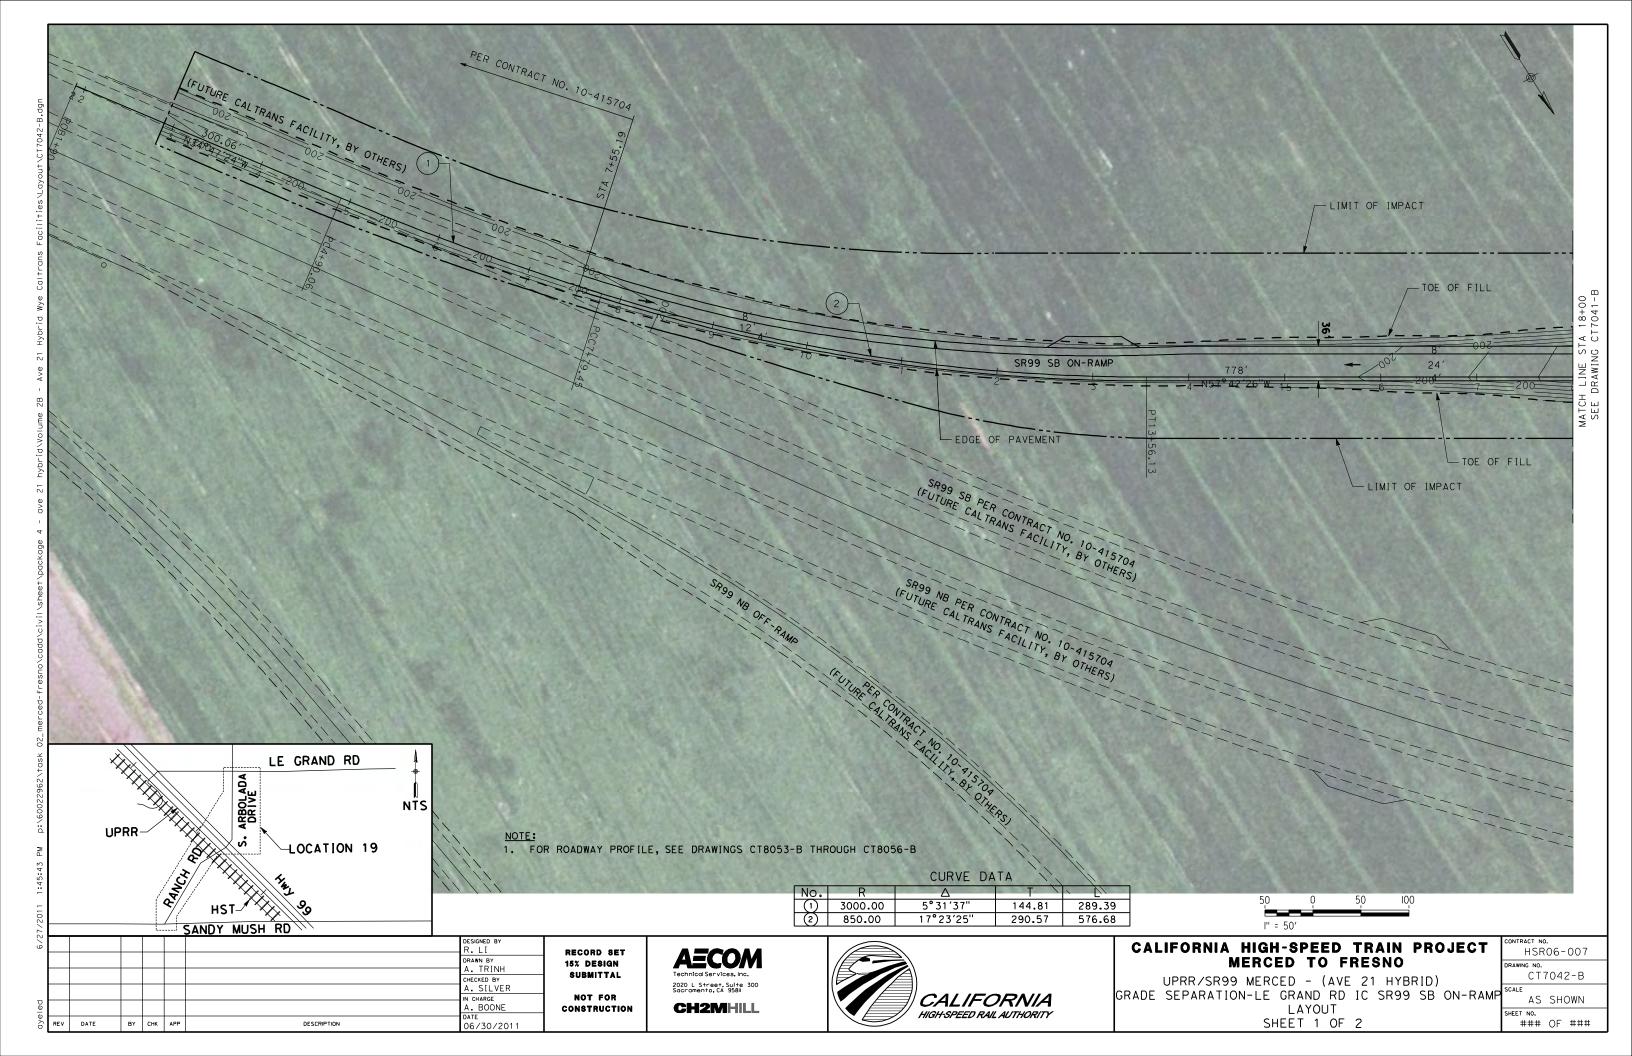

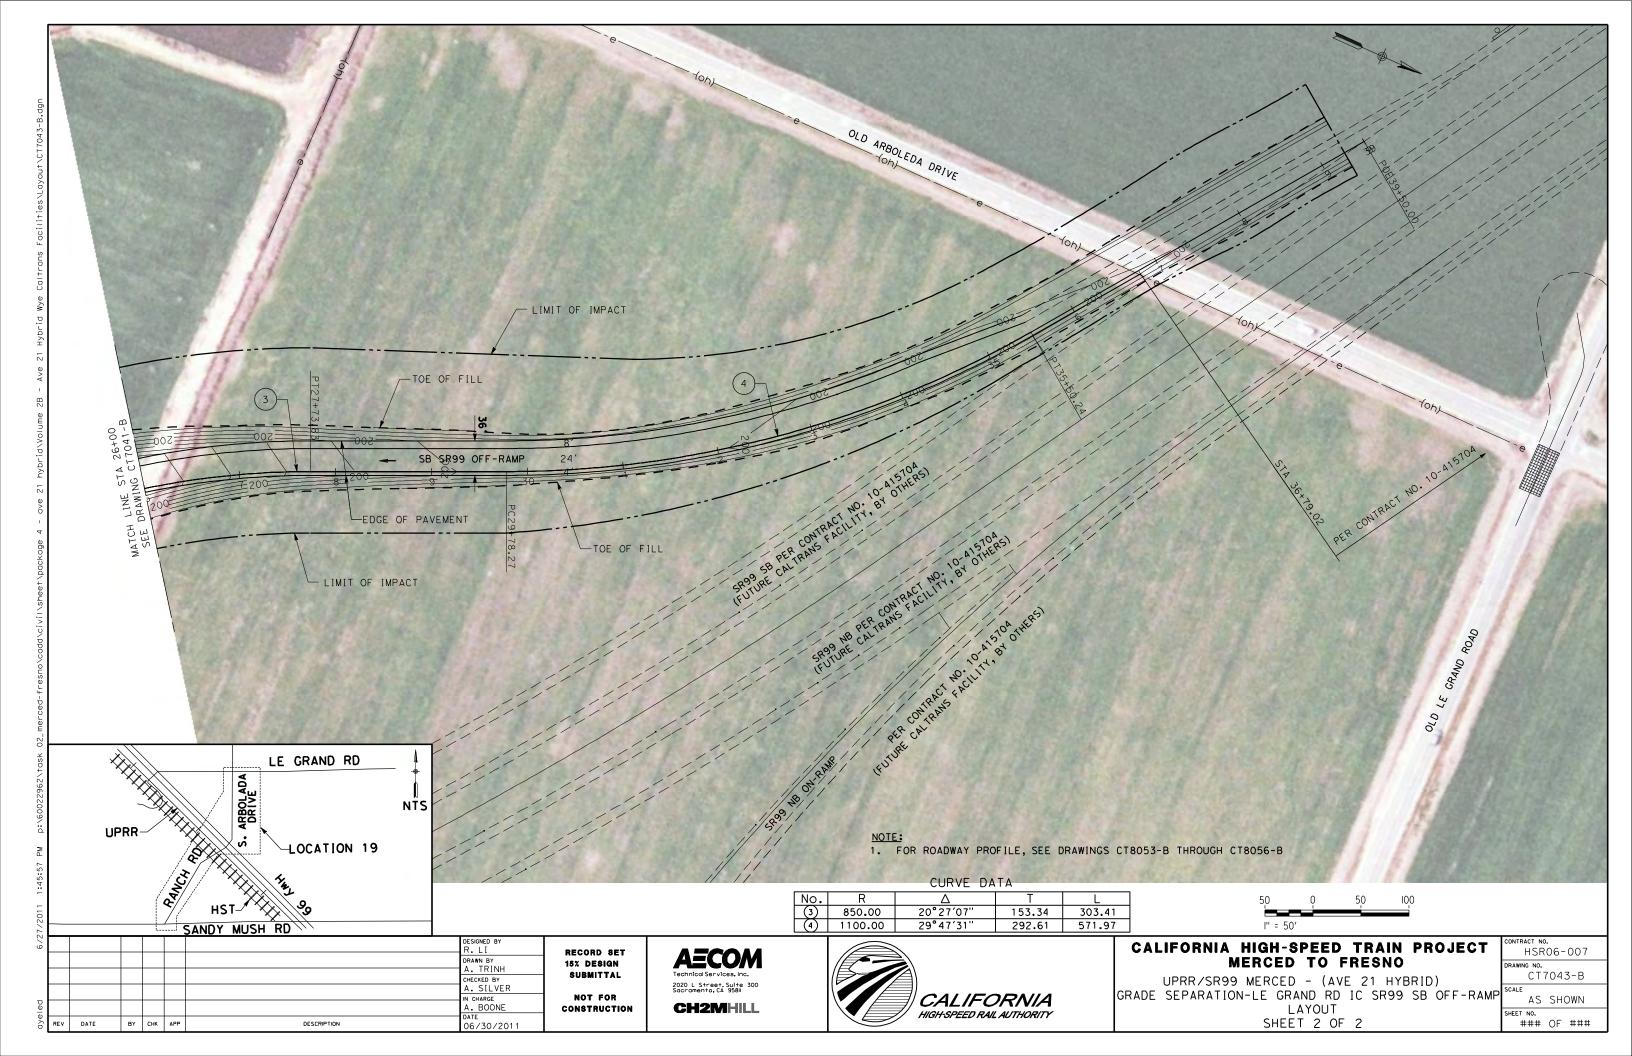

<u>355</u> <u>355</u> 350 350 345 345 340 340 335 335 330 330 325 325 320 320 <u>315</u> 310 310 600′ VC SSD 395′ 305 305 300 300 295 295 290 290 MATCH LINE S SEE DRAWING 285 285 280 280 PROFILE SCALE HORIZ: 1"=50' VERT: 1"=5' 275 275 270 270 NOT FOR CONSTRUCTION FOR INTERNAL USE ONLY DESIGNED BY R. GIBSON CALIFORNIA HIGH-SPEED TRAIN PROJECT HSR06-007 RECORD SET DRAWN BY F. DEMARCO MERCED TO FRESNO CT3001-A 15% DESIGN BNSF MAINLINE - (AVE 21 HYBRID)
GRADE SEPARATION - AVENUE 8
PROFILE
SHEET 1 OF 3 SUBMITTAL CHECKED BY A. SILVER NOT FOR CALIFORNIA AS SHOWN IN CHARGE A. BOONE **CH2M**HILL CONSTRUCTION HIGH-SPEED RAIL AUTHORITY DATE 06/30/2011 OF ###

BY CHK APP

DESCRIPTION

<u>355</u> <u>355</u> 350 350 345 345 340 340 335 335 330 330 +43.53 EVC Elev 319.42 325 325 320 320 800′ VC SSD 465′ <u>315</u> 310 310 305 305 œ 300 300 STA 29+25 CT3003-A CT3003-A 295 SEE DRAWING 290 __ OG SE DRY →HST TOR = 294.35 280 280 PROFILE SCALE HORIZ: 1"=50' VERT: 1"=5' 275 275 270 270 NOT FOR CONSTRUCTION 15 20 25 FOR INTERNAL USE ONLY DESIGNED BY R. GIBSON CALIFORNIA HIGH-SPEED TRAIN PROJECT HSR06-007 RECORD SET DRAWN BY F. DEMARCO MERCED TO FRESNO 15% DESIGN BNSF MAINLINE - (AVE 21 HYBRID) GRADE SEPARATION - AVENUE 8 PROFILE SHEET 2 OF 3 SUBMITTAL CT3002-A CHECKED BY A. SILVER CALIFORNIA NOT FOR AS SHOWN N CHARGE A. BOONE **CH2M**HILL CONSTRUCTION HIGH-SPEED RAIL AUTHORITY DATE 06/30/2011 OF ### REV DATE BY CHK APP DESCRIPTION

<u>355</u> <u>355</u> 350 350 345 345 340 340 335 335 330 330 325 325 320 320 315 310 310 305 305 300 300 295 295 290 290 285 285 280 280 PROFILE SCALE HORIZ: 1"=50' VERT: 1"=5' 275 275 270 270 35 NOT FOR CONSTRUCTION 30 FOR INTERNAL USE ONLY DESIGNED BY R. GIBSON CALIFORNIA HIGH-SPEED TRAIN PROJECT HSR06-007 RECORD SET DRAWN BY F. DEMARCO MERCED TO FRESNO DRAWING NO. CT3003-A 15% DESIGN BNSF MAINLINE - (AVE 21 HYBRID)
GRADE SEPARATION - AVENUE 8
PROFILE
SHEET 3 OF 3 SUBMITTAL CHECKED BY A. SILVER NOT FOR CALIFORNIA AS SHOWN N CHARGE A. BOONE **CH2M**HILL CONSTRUCTION HIGH-SPEED RAIL AUTHORITY DATE 06/30/2011 BY CHK APP DESCRIPTION

6% 6% 4% 14+86.64 BC 2% 2% AXIS OF ROTATION - CONTROL LINE L+ & R+ ETW +2% <u>-2%</u> S L+ & R+ SHLD <u>-4%</u> -6% SUPERELEVATION 250 250 245 245 240 240 235 235 230 225 225 220 220 +86.07 Elev 209.86 CONFORM # 78.07 BVC # +78.07 BVC # E1eV 209.17 # MATCH LINE DRAWING CT8046-B 215 210 -0.30% 205 205 PROFILE SCALE HORIZ: 1"=50' VERT: 1"=5' 200 DESIGNED BY CALIFORNIA HIGH-SPEED TRAIN PROJECT HSR06-007 RECORD SET AECOM DRAWN BY
A. TRINH
CHECKED BY
A. SILVER MERCED TO FRESNO 15% DESIGN SUBMITTAL CT8045-B UPRR/SR99 MERCED - (AVE 21 HYBRID) GRADE SEPARATION - SANDY MUSH RD INTERCHANGE 2020 L Street, Suite 300 Sacramento, CA 95811 IN CHARGE A. BOONE DATE 06/30/2011 NOT FOR CALIFORNIA AS SHOWN **CH2MHILL PROFILE** CONSTRUCTION HIGH-SPEED RAIL AUTHORITY

REV DATE

BY CHK APP

DESCRIPTION

SHEET 1 OF 3

OF

6% Rt ETW & Rt Shid +5% 2300′R, L† 4% 2% AXIS OF ROTATION - CONTROL LINE -2% -2% SEE -4% L+ ETW & L+ ShId -5% -6% SUPERELEVATION 250 250 +30.00 BVC Elev 239.81 245 1000' VC SSD 449' DS 50MPH 240 240 +28.07 EVC —EXIST OG PER CONTRACT NO. 10-415804 220 220 215 SSD 543' DS 50MPH 210 205 PROFILE SCALE HORIZ: 1"=50' VERT: 1"=5' 200 20 DESIGNED BY CALIFORNIA HIGH-SPEED TRAIN PROJECT HSR06-007 RECORD SET AECOM drawn by A. TRINH MERCED TO FRESNO 15% DESIGN SUBMITTAL CT8046-B CHECKED BY A. SILVER UPRR/SR99 MERCED - (AVE 21 HYBRID) 2020 L Street, Suite 300 Sacramento, CA 95811 GRADE SEPARATION - SANDY MUSH RD INTERCHANGE NOT FOR CALIFORNIA IN CHARGE A. BOONE AS SHOWN **CH2MHILL** PROFILE CONSTRUCTION HIGH-SPEED RAIL AUTHORITY SHEET 2 OF 3 ### OF ### 06/30/2011 BY CHK APP DESCRIPTION

6%_ 4% 2% AXIS OF ROTATION - CONTROL LINE L INE C T 80. L+ & R+ ETW -2% SEE L+ & R+ ShId -5% -6% SUPERELEVATION 230 230 220 220 215 205 205 200 200 195 PG-190 V OG 185 PROFILE SCALE HORIZ: 1"=50' VERT: 1"=5' SEE 180 180 DESIGNED BY CALIFORNIA HIGH-SPEED TRAIN PROJECT HSR06-007 RECORD SET AECOM drawn by A. TRINH MERCED TO FRESNO 15% DESIGN SUBMITTAL CT8049-B CHECKED BY A. SILVER UPRR/SR99 MERCED - (AVE 21 HYBRID) 2020 L Street, Suite 300 Sacramento, CA 95811 GRADE SEPARATION - LE GRAND RD INTERCHANGE IN CHARGE A. BOONE DATE 06/30/2011 NOT FOR CALIFORNIA AS SHOWN **CH2MHILL PROFILE** CONSTRUCTION HIGH-SPEED RAIL AUTHORITY SHEET 2 OF 5 ### OF ### BY CHK APP DESCRIPTION

265 260 260 255 255 245 245 240 230 230 220 220 PER CONTRACT NO. 10-415704
GRADE CONTROL BY "A" (RTE 99) 215 CROSS SLOPE FUTURE CALTRANS FACILITY, BY OTHERS 205 PG-470' VC 200 <u></u> 0G – 190 190 PROFILE SCALE HORIZ: 1"=50' VERT: 1"=5' 180 DESIGNED BY CALIFORNIA HIGH-SPEED TRAIN PROJECT HSR06-007 RECORD SET drawn by A. TRINH MERCED TO FRESNO 15% DESIGN SUBMITTAL CT8053-B CHECKED BY A. SILVER UPRR/SR99 MERCED - (AVE 21 HYBRID) 2020 L Street, Suite 300 Sacramento, CA 95811 GRADE SEPARATION-LE GRAND RD IC SR99 SB ON-RAMP IN CHARGE A. BOONE DATE 06/30/2011 NOT FOR CALIFORNIA AS SHOWN **CH2MHILL** PROFILE CONSTRUCTION HIGH-SPEED RAIL AUTHORITY SHEET 1 OF 4 ### OF ### BY CHK APP DESCRIPTION

265 260 260 255 255 245 245 GRADE CONTROL BY LE GRAND" CROSS SLOPE 240 "LE GRAND" 105+55.50 "SB ON-RAMP" 22+20,56 PER CONTRACT NO. 10-415704 Elev 220.38 230 230 1.59% 120' VC 220 220 215 EXIST SB ON-RAMP "R1" PROFILE 205 PER CONTRACT NO. 10-415704 470' VC 200 200 195 195 190 190 PROFILE SCALE HORIZ: 1"=50' VERT: 1"=5' DESIGNED BY CALIFORNIA HIGH-SPEED TRAIN PROJECT HSR06-007 RECORD SET AECOM drawn by A. TRINH MERCED TO FRESNO 15% DESIGN SUBMITTAL CT8054-B CHECKED BY A. SILVER UPRR/SR99 MERCED - (AVE 21 HYBRID) 2020 L Street, Suite 300 Sacramento, CA 95811 GRADE SEPARATION-LE GRAND RD IC SR99 SB ON-RAMP NOT FOR CALIFORNIA IN CHARGE A. BOONE DATE AS SHOWN **CH2MHILL** PROFILE CONSTRUCTION HIGH-SPEED RAIL AUTHORITY SHEET 2 OF 4 ### OF ### BY CHK APP DESCRIPTION 06/30/2011

265 260 260 255 255 245 245 240 GRADE CONTROL BY "LE GRAND" CROSS SLOPE "LE GRAND" 105+55.50 E I EW 224.60 CONFORM E GRAND 1 89.71 BVC "SB OFF-RAMP" 22+40.11 Elev 224.60 PER CONTRACT NO. 10-415704 230 230 "R3" 22+40.11 "LG" 105+55.50 POT Elev 220.38 2.00% 120' VC 220 220 215 EXIST SB OFF-RAMP "R3" PROFILE PER CONTRACT NO. 10-415704 570' VC 205 SSD 435 DS 50MPH 200 200 200′ VC 195 190 190 PROFILE SCALE HORIZ: 1"=50' VERT: 1"=5' 180 DESIGNED BY CALIFORNIA HIGH-SPEED TRAIN PROJECT HSR06-007 RECORD SET AECOM drawn by A. TRINH MERCED TO FRESNO 15% DESIGN SUBMITTAL CT8055-B CHECKED BY A. SILVER UPRR/SR99 MERCED - (AVE 21 HYBRID) 2020 L Street, Suite 300 Sacramento, CA 95811 GRADE SEPARATION-LE GRAND RD IC SR99 SB OFF-RAMP NOT FOR CALIFORNIA IN CHARGE A. BOONE DATE AS SHOWN **CH2MHILL** PROFILE CONSTRUCTION HIGH-SPEED RAIL AUTHORITY SHEET 3 OF 4 ### OF ### BY CHK APP DESCRIPTION 06/30/2011

265 260 260 255 255 245 245 240 230 230 220 220 215 PER CONTRACT NO. 10-415704 GRADE CONTROL BY "A" (RTE 99) CROSS SLOPE FUTURE CALTRANS FACILITY, BY OTHERS 205 PG ¬ -0.30% 능론 200 200 195 195 190 190 PROFILE SCALE HORIZ: 1"=50' VERT: 1"=5' 180 DESIGNED BY CALIFORNIA HIGH-SPEED TRAIN PROJECT HSR06-007 RECORD SET drawn by A. TRINH MERCED TO FRESNO 15% DESIGN SUBMITTAL CT8056-B CHECKED BY A. SILVER UPRR/SR99 MERCED - (AVE 21 HYBRID) 2020 L Street, Suite 300 Sacramento, CA 95811 GRADE SEPARATION-LE GRAND RD IC SR99 SB OFF-RAMP IN CHARGE A. BOONE DATE 06/30/2011 NOT FOR CALIFORNIA AS SHOWN **CH2MHILL** PROFILE CONSTRUCTION HIGH-SPEED RAIL AUTHORITY SHEET 4 OF 4 ### OF ###

BY CHK APP

DESCRIPTION

SHT NO.	DWG NO.	DRAWING TITLE LINE 3	DRAWING TITLE Line 4	SHEET TITLE Line 5	SHEET TITLE Line 6
		ROADWAY B	RIDGE STRUC	CTURE PLAN	
		HYBRID AL	TERNATIVE/A	VENUE 21	
			GENERAL		
		HYBRID ALTERNATIVE HYBRID ALTERNATIVE	AVENUE 21 AVENUE 21	INDEX OF DRAWINGS STRUCTURE INDEX MAP	SHEET 1 OF 1 SHEET 1 OF 1
	ı		OVERHEAD BRIDGES		
	ST1113 ST1114 ST1181	UPRR/SR 99 MERCED CONNECTION - HYBRID UPRR/SR 99 MERCED CONNECTION - HYBRID UPRR/SR 99 MERCED CONNECTION - HYBRID	AVENUE 21 AVENUE 21 AVENUE 21	SANDY MUSH ROAD OVERHEAD LE GRAND OVERHEAD SR 99 SOUTHBOUND OVERHEAD	PLANNING STUDY PLANNING STUDY PLANNING STUDY

					DESIGNED BY H. Lee	
					DRAWN BY B. Dolan	
					CHECKED BY J. Renteria	
					in charge A. Boone] ,
REV	DATE	ВΥ	СНК	APP	DATE 07/27/2011	

RECORD SET 15% DESIGN SUBMITTAL NOT FOR CONSTRUCTION







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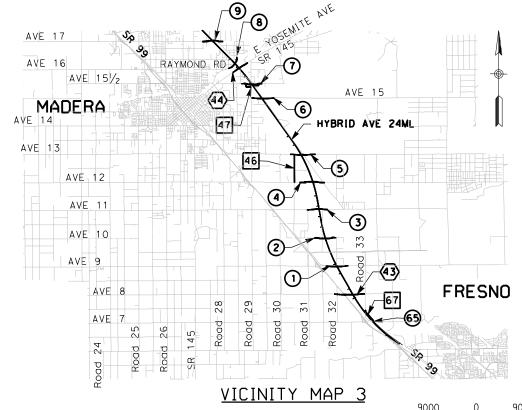
HYBRID ALTERNATIVE AVENUE 21 INDEX OF DRAWINGS SHEET 1 OF 1

CONTRACT NO.					
HSR06-007					
DRAWING NO.					
SB1401					
SCALE					
No scale					

SHEET NO.



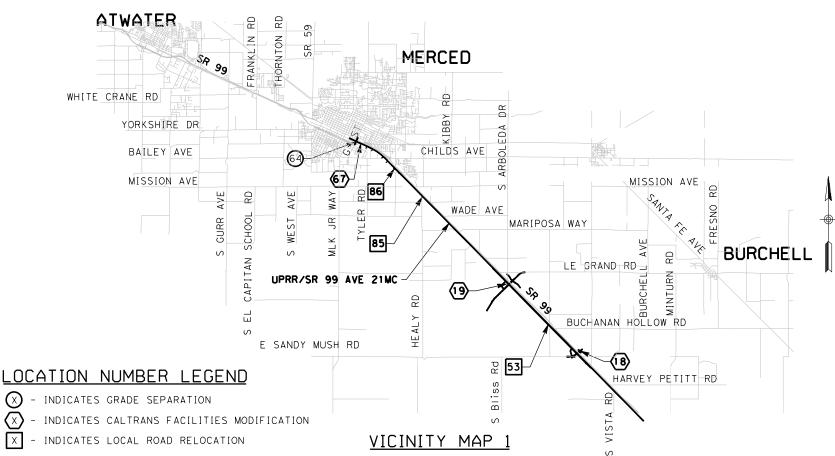

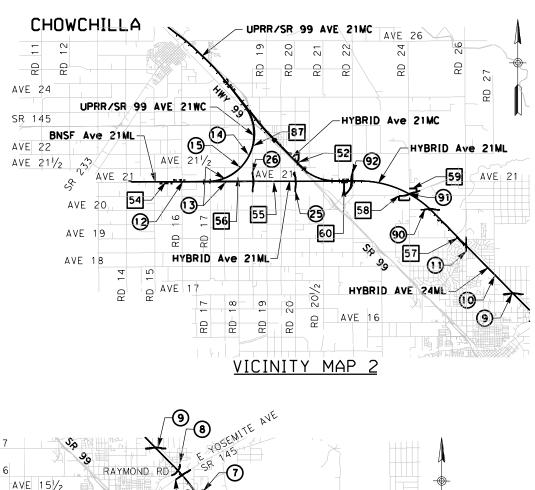

9000 18000 GRAPHIC SCALE

STRUCTURE INDEX MAP

CALIFORNIA HIGH-SPEED TRAIN PROJECT MERCED TO FRESNO HYBRID ALTERNATIVE **AVENUE 21**

SHEET 1 OF 1


HSR06-007 SB1402 As shown


H. Lee DRAWN BY B. Dolan CHECKED BY CHARGE . Boone BY CHK APP DESCRIPTION 07/27/2011


RECORD SET 15% DESIGN SUBMITTAL NOT FOR CONSTRUCTION


AECOM 2020 L Street, Suite 300 Sacramento, CA 95811 **CH2MHILL**

CALIFORNIA

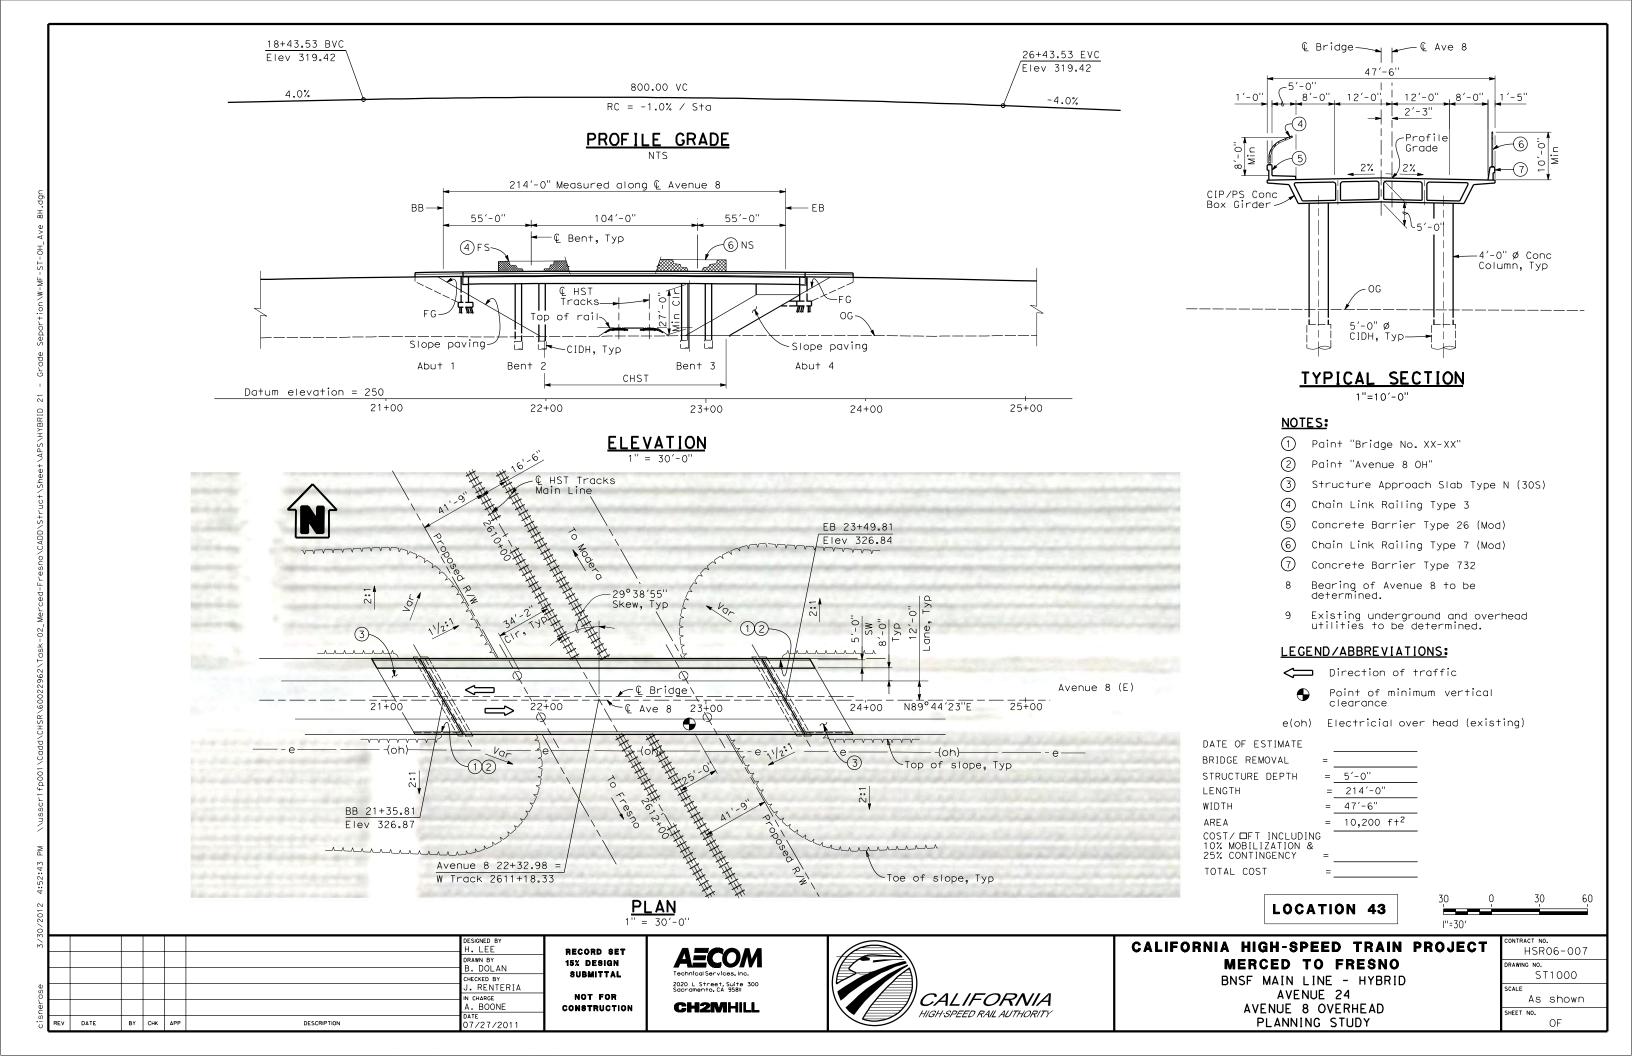

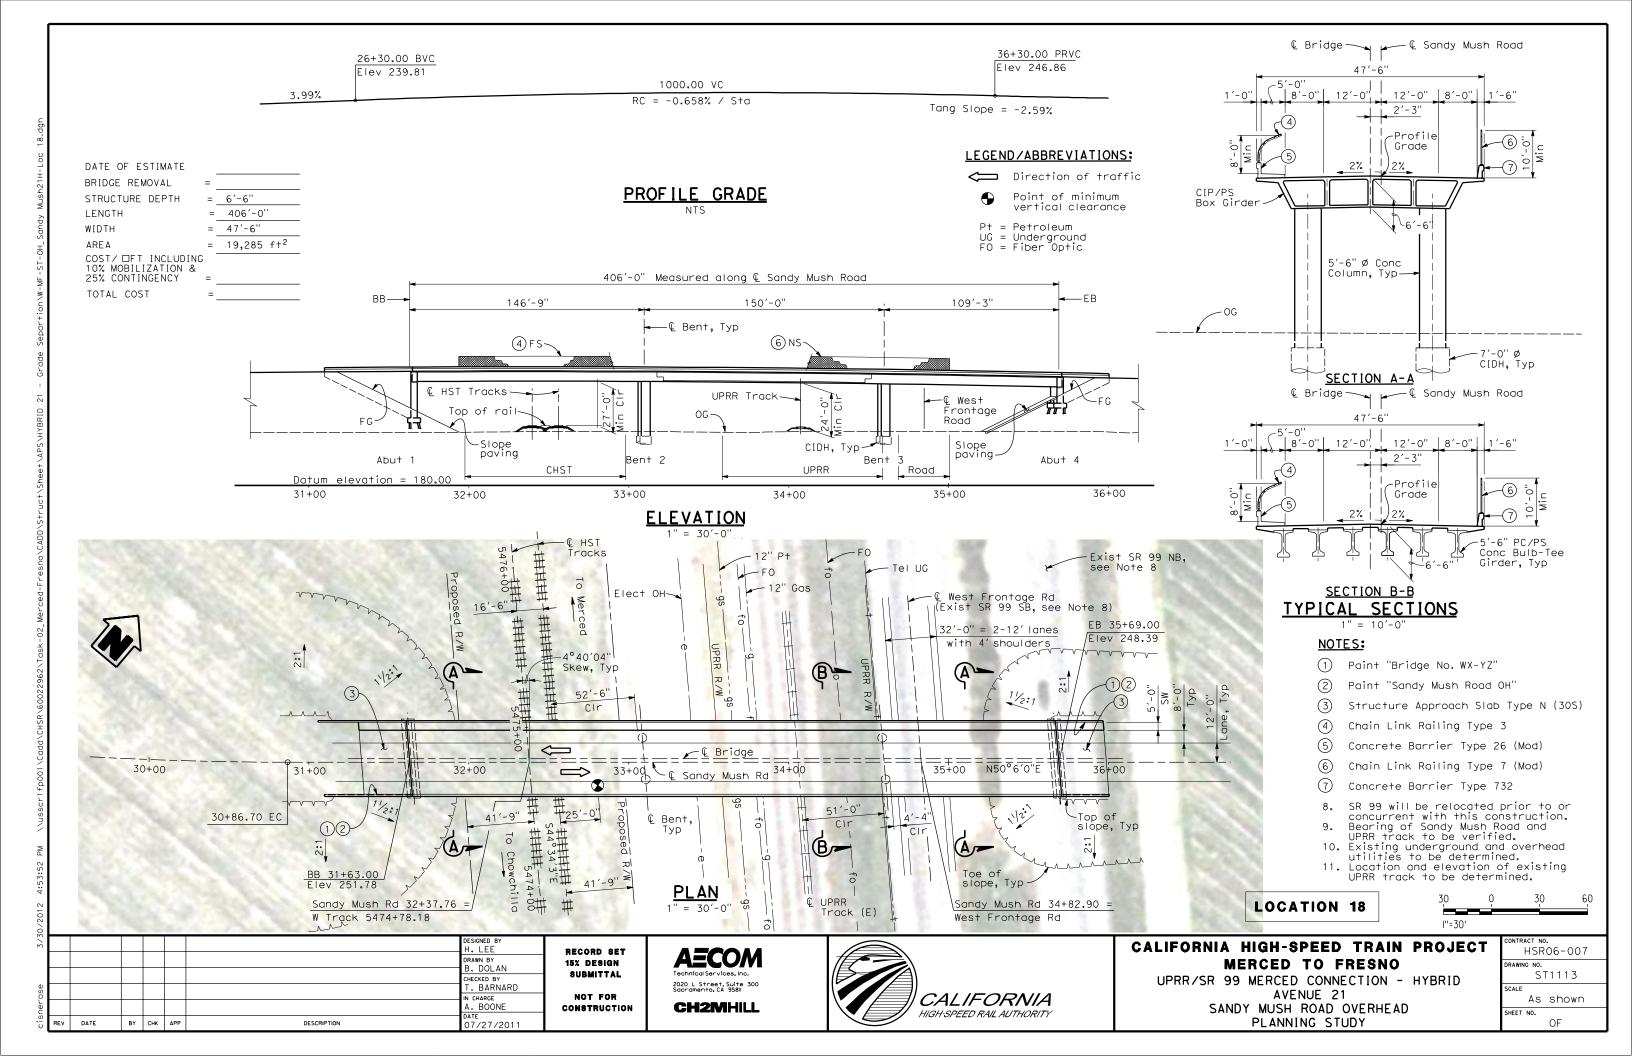

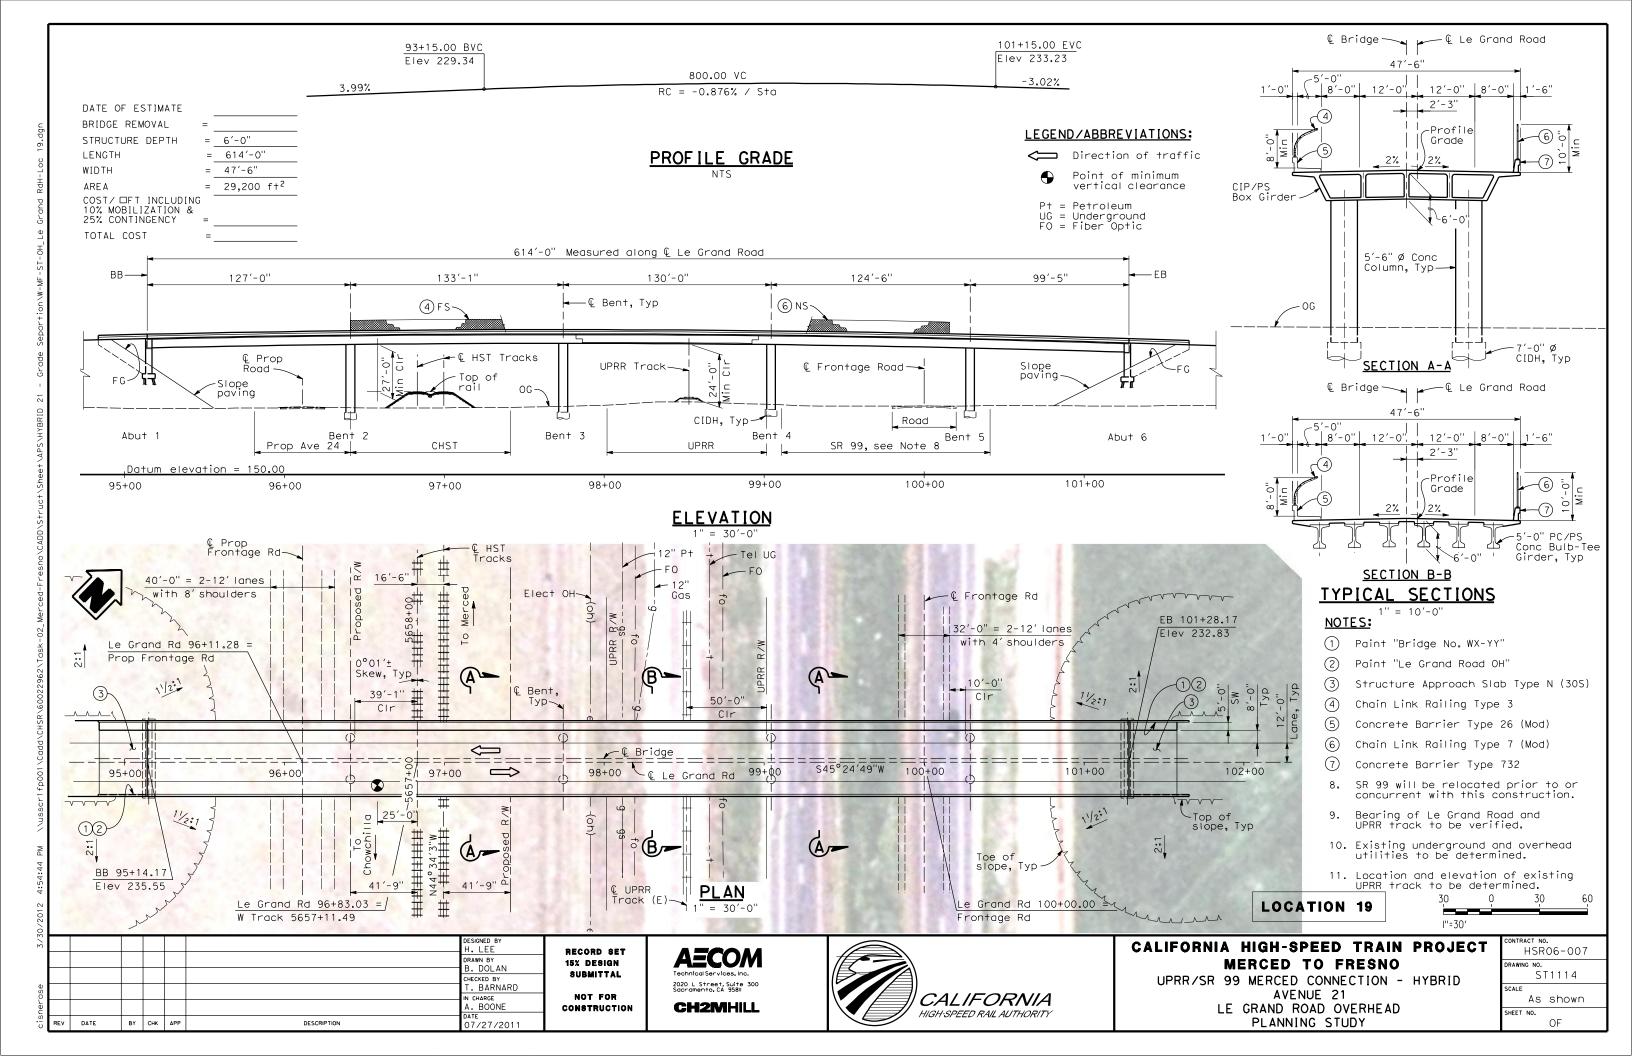

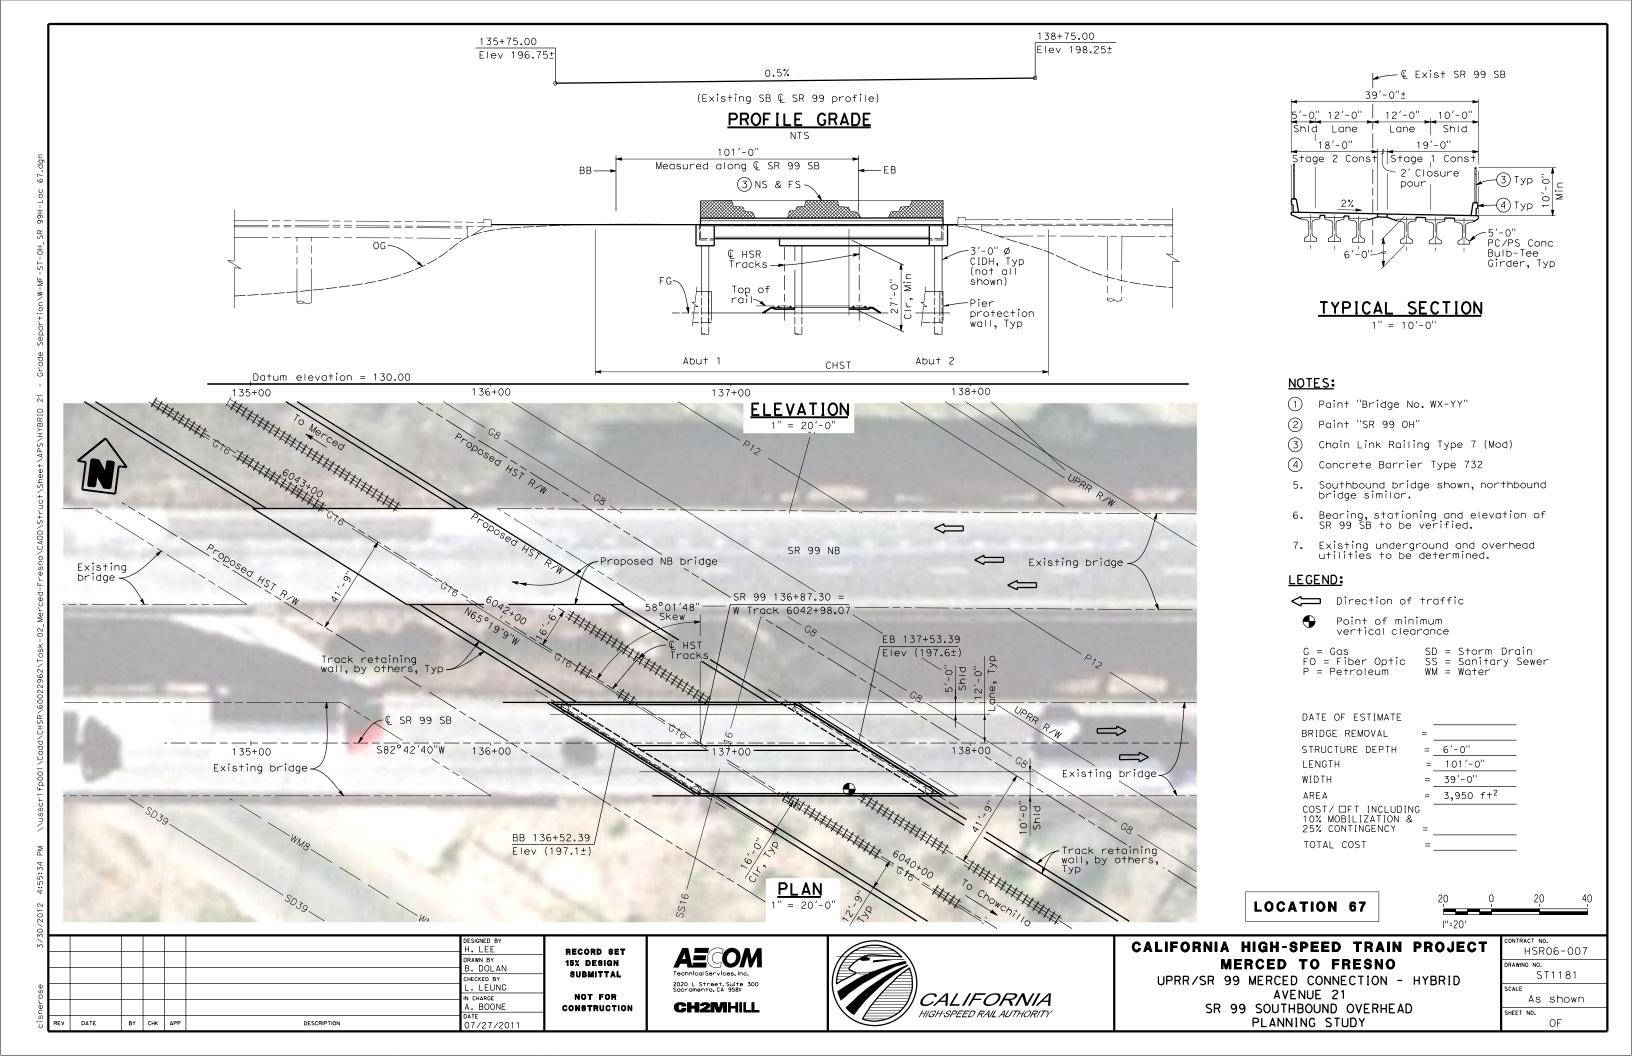

						DESIGNED BY R. LI
						DRAWN BY A. TRINH
						CHECKED BY
						A. SILVER
	12/28/11	RG				A. BOONE
Eν	DATE	BY	СНК	APP	DESCRIPTION	DATE 07/27/2011

LOCATION SHT DWG

NO. NO. NO.

B8990-B AVE 21 HYBRID

B8991-B AVE 21 HYBRID B9000-B AVE 21 HYBRID

B9001-B AVE 21 HYBRID

DRAWING TITLE

LINE 3

CB9002-B UPRR/SR99 MAINLINE/WYE/MERCED - (AVE 21 HYBRID) LOCAL & FRONTAGE RD
CB9003-B UPRR/SR99 MERCED - (AVE 21 HYBRID) LOCAL & FRONTAGE RD
CR8990-B AVE 21 HYBRID LOCAL ROADS

RECORD SET
15% DESIGN
SUBMITTAL
NOT FOR
CONSTRUCTION





CALIFORNIA HIGH-SPEED TRAIN PROJECT MERCED TO FRESNO

DRAWING TITLE

LINE 6

SHEET 1 OF 1 SHEET 1 OF 1 SHEET 1 OF 2

SHEET 2 OF 2

SHEET 1 OF 2 SHEET 2 OF 2 SHEET 1 OF 1

> AVE 21 HYBRID GENERAL INDEX OF DRAWINGS SHEET 1 OF 1

CONTRACT NO.						
HSR06-007						
DRAWING NO.						
B8990-B						
SCALE						
NONE						
SHEET NO.						
### OF ###						

·					
·	·	ΔVF	21 HYBRID (LAYOUT)		
			· · · · · · · · · · · · · · · · · · ·		
46		BNSF MAIN LINE - (AVE 21 HYBRID)	LOCAL ROAD - ROAD 30 1/2	LAYOUT	SHEET 1 OF 1
47		BNSF MAIN LINE - (AVE 21 HYBRID)	LOCAL ROAD - ROAD 29	LAYOUT	SHEET 1 OF 1
57	CR4012-A	BNSF MAIN LINE - (AVE 21 HYBRID)	LOCAL ROAD - HANOVER RD	LAYOUT	SHEET 1 OF 1
58	CR4013-A	BNSF MAIN LINE - (AVE 21 HYBRID)	LOCAL ROAD - AVENUE 20 1/2	LAYOUT	SHEET 1 OF 1
59	CR4014-A	BNSF MAIN LINE - (AVE 21 HYBRID)	LOCAL ROAD - AVENUE 20 1/2	LAYOUT	SHEET 1 OF 1
60	CR4015-A	BNSF MAIN LINE - (AVE 21 HYBRID)	LOCAL ROAD - ROAD 22	LAYOUT	SHEET 1 OF 1
67	CR4018-A	BNSF MERCED CONNECTION - (AVE 21 HYBRID)	LOCAL ROAD - ROAD 33	LAYOUT	SHEET 1 OF 1
52	CR9017-B	UPRR/SR99 MERCED - (AVE 21 HYBRID)	FAIRMEAD BLVD	LAYOUT	SHEET 1 OF 4
52	CR9018-B	UPRR/SR99 MERCED - (AVE 21 HYBRID)	FAIRMEAD BLVD	LAYOUT	SHEET 2 OF 4
52	CR9019-B	UPRR/SR99 MERCED - (AVE 21 HYBRID)	FAIRMEAD BLVD	LAYOUT	SHEET 3 OF 4
52	CR9020-B	UPRR/SR99 MERCED - (AVE 21 HYBRID)	FAIRMEAD BLVD	LAYOUT	SHEET 4 OF 4
53	CR9021-B	UPRR/SR99 MERCED - (AVE 21 HYBRID)	PROPOSED WEST FRONTAGE ROAD	LAYOUT	SHEET 1 OF 8
53	CR9022-B	UPRR/SR99 MERCED - (AVE 21 HYBRID)	PROPOSED WEST FRONTAGE ROAD	LAYOUT	SHEET 2 OF 8
53	CR9023-B	UPRR/SR99 MERCED - (AVE 21 HYBRID)	PROPOSED WEST FRONTAGE ROAD	LAYOUT	SHEET 3 OF 8
53	CR9024-B	UPRR/SR99 MERCED - (AVE 21 HYBRID)	PROPOSED WEST FRONTAGE ROAD	LAYOUT	SHEET 4 OF 8
53	CR9025-B	UPRR/SR99 MERCED - (AVE 21 HYBRID)	PROPOSED WEST FRONTAGE ROAD	LAYOUT	SHEET 5 OF 8
53	CR9026-B	UPRR/SR99 MERCED - (AVE 21 HYBRID)	PROPOSED WEST FRONTAGE ROAD	LAYOUT	SHEET 6 OF 8
53	CR9027-B	UPRR/SR99 MERCED - (AVE 21 HYBRID)	PROPOSED WEST FRONTAGE ROAD	LAYOUT	SHEET 7 OF 8
53	CR9028-B	UPRR/SR99 MERCED - (AVE 21 HYBRID)	PROPOSED WEST FRONTAGE ROAD	LAYOUT	SHEET 8 OF 8
54	CR9029-B	UPRR/SR99 MAINLINE/WYE - (AVE 21 HYBRID)	AVENUE 21	LAYOUT	STA 63+99.89 TO STA 77+00
54	CR9032-B	UPRR/SR99 MAINLINE/WYE - (AVE 21 HYBRID)	AVENUE 21	LAYOUT	STA 77+00 TO STA 135+00
54	CR9033-B	UPRR/SR99 MAINLINE/WYE - (AVE 21 HYBRID)	AVENUE 21	LAYOUT	STA 135+00 TO STA 160+00
56	CR9035-B	UPRR/SR99 MAINLINE/WYE - (AVE 21 HYBRID)	ROAD 18	LAYOUT	
55	CR9040-B	UPRR/SR99 MAINLINE - (AVE 21 HYBRID)	ROAD 19 AND ROAD 19 1/2	LAYOUT	
85	CR9041-B	UPRR/SR99 MERCED - (AVE 21 HYBRID)	HEALY ROAD	LAYOUT	
86	CR9042-B	UPRR/SR99 MERCED - (AVE 21 HYBRID)	GERARD AVENUE/CALTRANS FRONTAGE ROAD	LAYOUT	
87	CR9043-B	UPRR/SR99 MAINLINE/WYE - (AVE 21 HYBRID)	ROAD 18 1/2	LAYOUT	STA 50+00 TO STA 74+07.87
	CR1479A	BNSF MAIN LINE	AVENUE 24/SR152/AVENUE 21	AVENUE 22 CONNECTOR TO ROAD 11	PLAN AND PROFILE
	CR1480A	BNSF MAIN LINE	AVENUE 24/SR152/AVENUE 21	AVENUE 22 CONNECTOR TO ROAD 11	PLAN AND PROFILE
	CR1483A	BNSF MAIN LINE	AVENUE 24/SR152/AVENUE 21	AVENUE 21	PLAN AND PROFILE

DRAWING TITLE

LINE 4

GENERAL

GENERAL

GENERAL

DRAWING TITLE

LINE 5

INDEX OF DRAWINGS

TYPICAL CROSS SECTIONS

INDEX MAP

INDEX MAP

KEY MAP

ABBREVIATIONS, SYMBOLS AND NOTES

MISCELLANEOUS

ALIGN	ALIGNMENT HORIZONTAL									
BC EC PC PCC PI POB POC POT PRC PT R V, DS	BEGINNING OF CURVE END OF CURVE POINT OF CURVE POINT OF COMPOUNT CURVES POINT OF INTERSECTION OF TWO TANGENTS POINT OF BEGINNING POINT ON CURVE POINT OF ENDING POINT ON TANGENT POINT OF REVERSE CURVES POINT OF TANGENCY RADIUS OF CURVATURE IN FEET DESIGN VELOCITY IN MILES PER HOUR									
BVC EVC PVC PVI PVT VC	VERTICAL BEGIN OF VERTICAL CURVE END OF VERTICAL CURVE POINT OF VERTICAL CURVE (BEGINNING OF CURVE) POINT OF VERTICAL INTERSECTION (OF TANGENTS) POINT OF VERTICAL TANGENCY (ENDING OF CURVE) VERTICAL CURVE									

A.L. T	AL TERMATIVE
ALT	ALTERNATIVE
AVE	AVENUE
BB	BEGIN BRIDGE
BEG	BEGIN
BLVD	BOULEVARD
Œ.	CENTER LINE
CL	CENTERLINE, CLASS
CLR	CLEAR
COL	COLUMN
DWG	DRAWING
EB	END BRIDGE
ELEV	ELEVATION
EQ	EQUATION
ES	EDGE OF SIDEWALK
ETW	EDGE OF TRAVELED WAY
	FLOW LINE
HORIZ	HORIZONTAL
HP	HINGE POINT
HST	HIGH SPEED TRAIN
HWY	HIGHWAY
I C	INTERCHANGE
IN	INCH
L	LENGTH
LT MBGR	LEFT
	METAL BEAM GUARD RAIL MAINLINE
ML MPH	MILES PER HOUR
MAX	MAXIMUM
MIN	MINIMUM
N	NORTH
NB	NORTH BOUND
No, NO	NUMBER
NTS	NOT TO SCALE
OG	ORIGINAL GROUND
O/H OH	OVERHEAD
PG&E	PACIFIC GAS & ELECTRIC
	PROFILE GRADE LINE
RET	RETAINING
RR	RAILROAD
RD	ROAD
R/W	RIGHT OF WAY
RT	RIGHT
SB	SOUTH BOUND
SHLD	SHOULDER
SR	STATE ROUTE
SHT	SHEET
SS	SANITARY SEWER
SSD	STOPPING SIGHT DISTANCE
ST	STREET
STA	STATION
STD	STANDARD
SD	STORM DRAIN
STRUCT, STR	STRUCTURE
T	TANGENT
TEL	TELEPHONE
	(OU) OVEDUEAD LINE

TOR	TOP OF RAIL
TK	TRACK
TYP	TYPICAL
TBD	TO BE DETERMINED
TF	TELECOMMUNICATIONS FIBER
	OPTIC
UPRR	UNION PACIFIC RAILROAD
VAR	VARIES
V VERT	VERTICAL
W	WATER, WEST

	MATCH LINE
	HST TRACK
	PROPOSED HST RIGHT-OF-WAY
	FREIGHT/PASSENGER TRACK - EXISTING
	EXISTING OR EXISTING RIGHT-OF-WAY BRIDGE FEATURES
	RETAINING WALLS
	ORIGINAL GROUND
G16	GAS LINE (16")
— TC ——	COMMUNICATION LINE
W	WATER LINE
—— FO —— ——	FIBER OPTIC LINE
——-E———	ELECTRICAL LINE
X	ELECTRICAL TOWER
S	SEWER LINE
	STORM DRAIN LINE
	FUEL LINE
—TC ——	TELEPHONE LINE
———— P12 ———	PETROLEUM LINE (12")
——— (ОН) ———	OVERHEAD
→ →	NORTH ARRROW
A	PVI
	MBGR
->-	DIRECTION OF TRAVEL
250	PROPOSED CONTOUR

_							
7/9						DESIGNED BY R. LI	
						DRAWN BY A. TRINH	
						CHECKED BY A. SILVER	
eled						IN CHARGE A. BOONE	
dye	REV	DATE	BY	СНК	APP	DATE 06/30/2011	

RECORD SET
15% DESIGN
SUBMITTAL
NOT FOR

CONSTRUCTION

(OH) OVERHEAD LINE (UG) UNDERGROUND LINE





CALIFORNIA HIGH-SPEED TRAIN PROJECT MERCED TO FRESNO

AVE 21 HYBRID


GENERAL


ABBREVIATIONS, SYMBOLS AND NOTES


SHEET 1 OF 1


CONTRACT NO. HSRO6-007								
DRAWIN	^{в но.} В8	991-B						
SCALE	NO	SCALE						


SHEET NO. ### OF ###

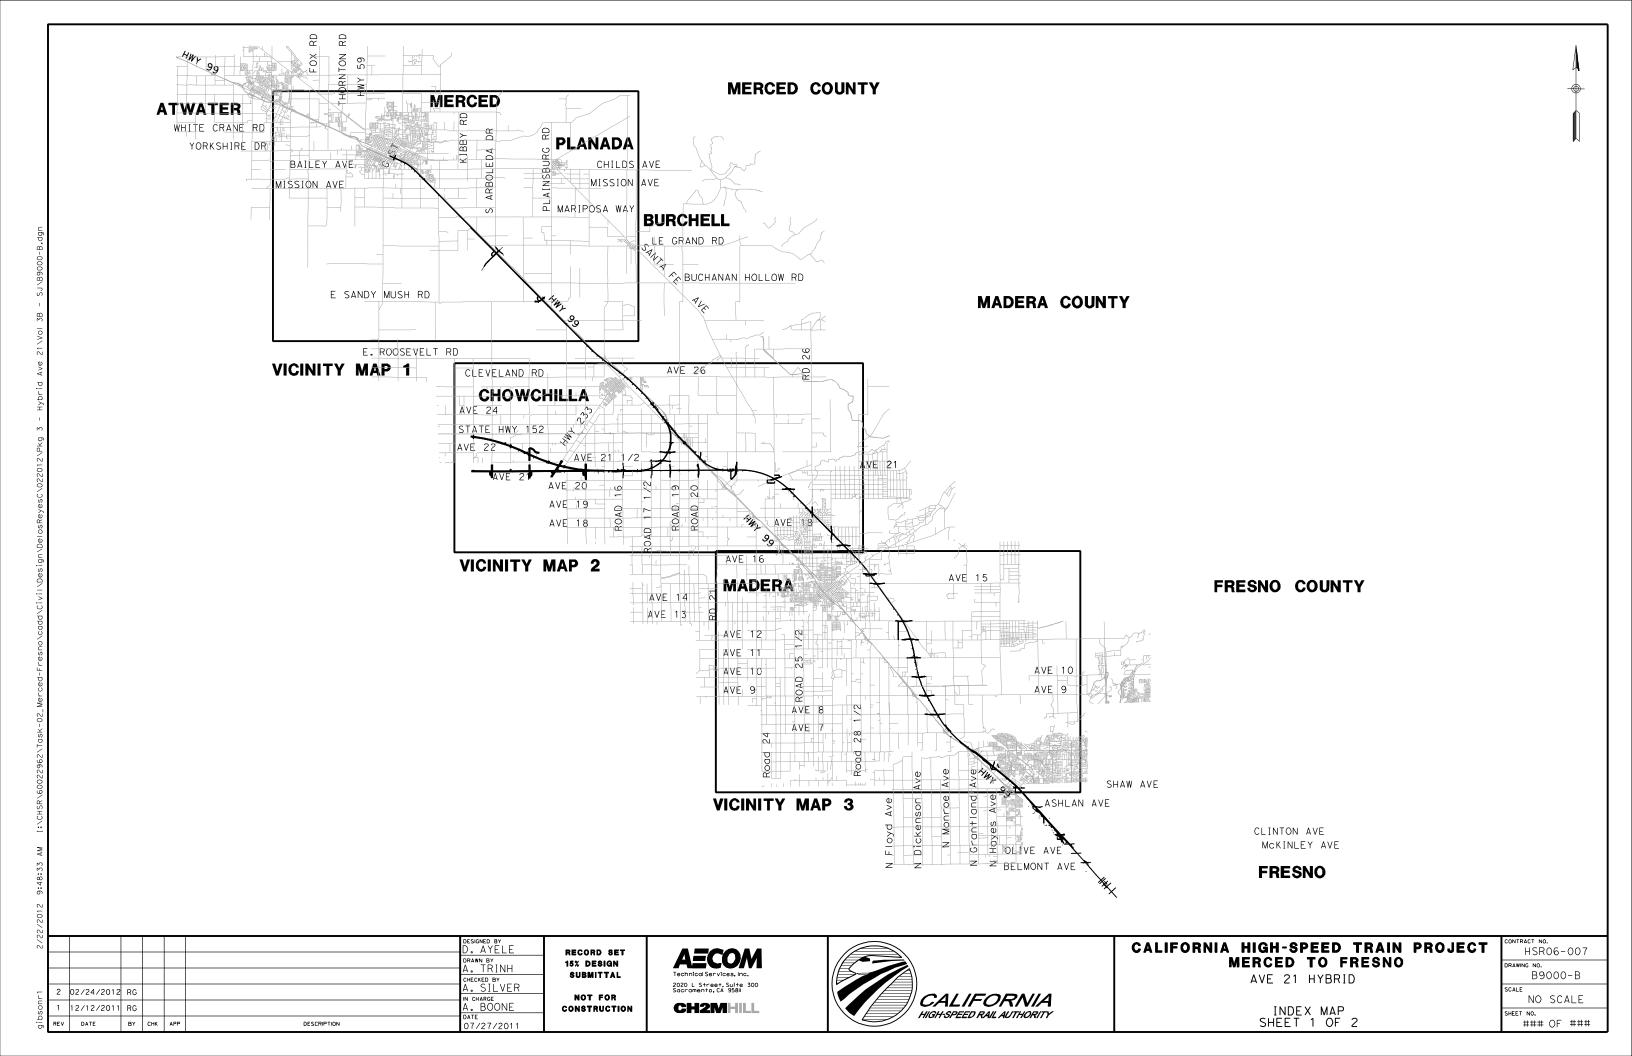


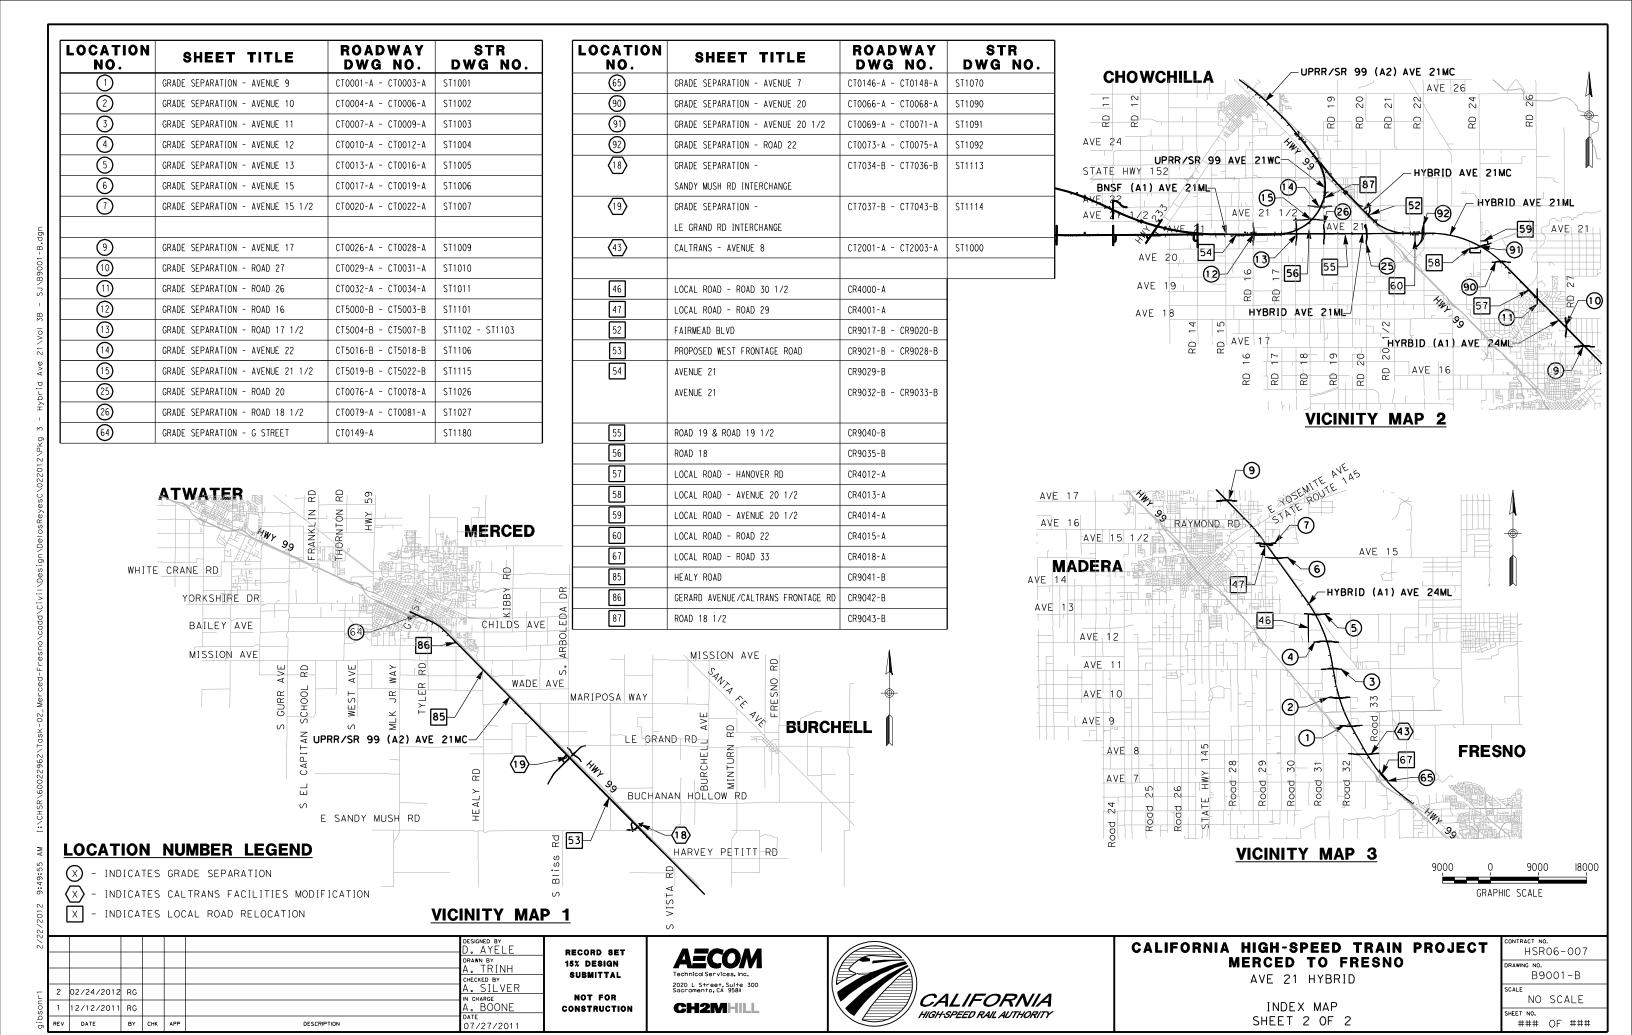


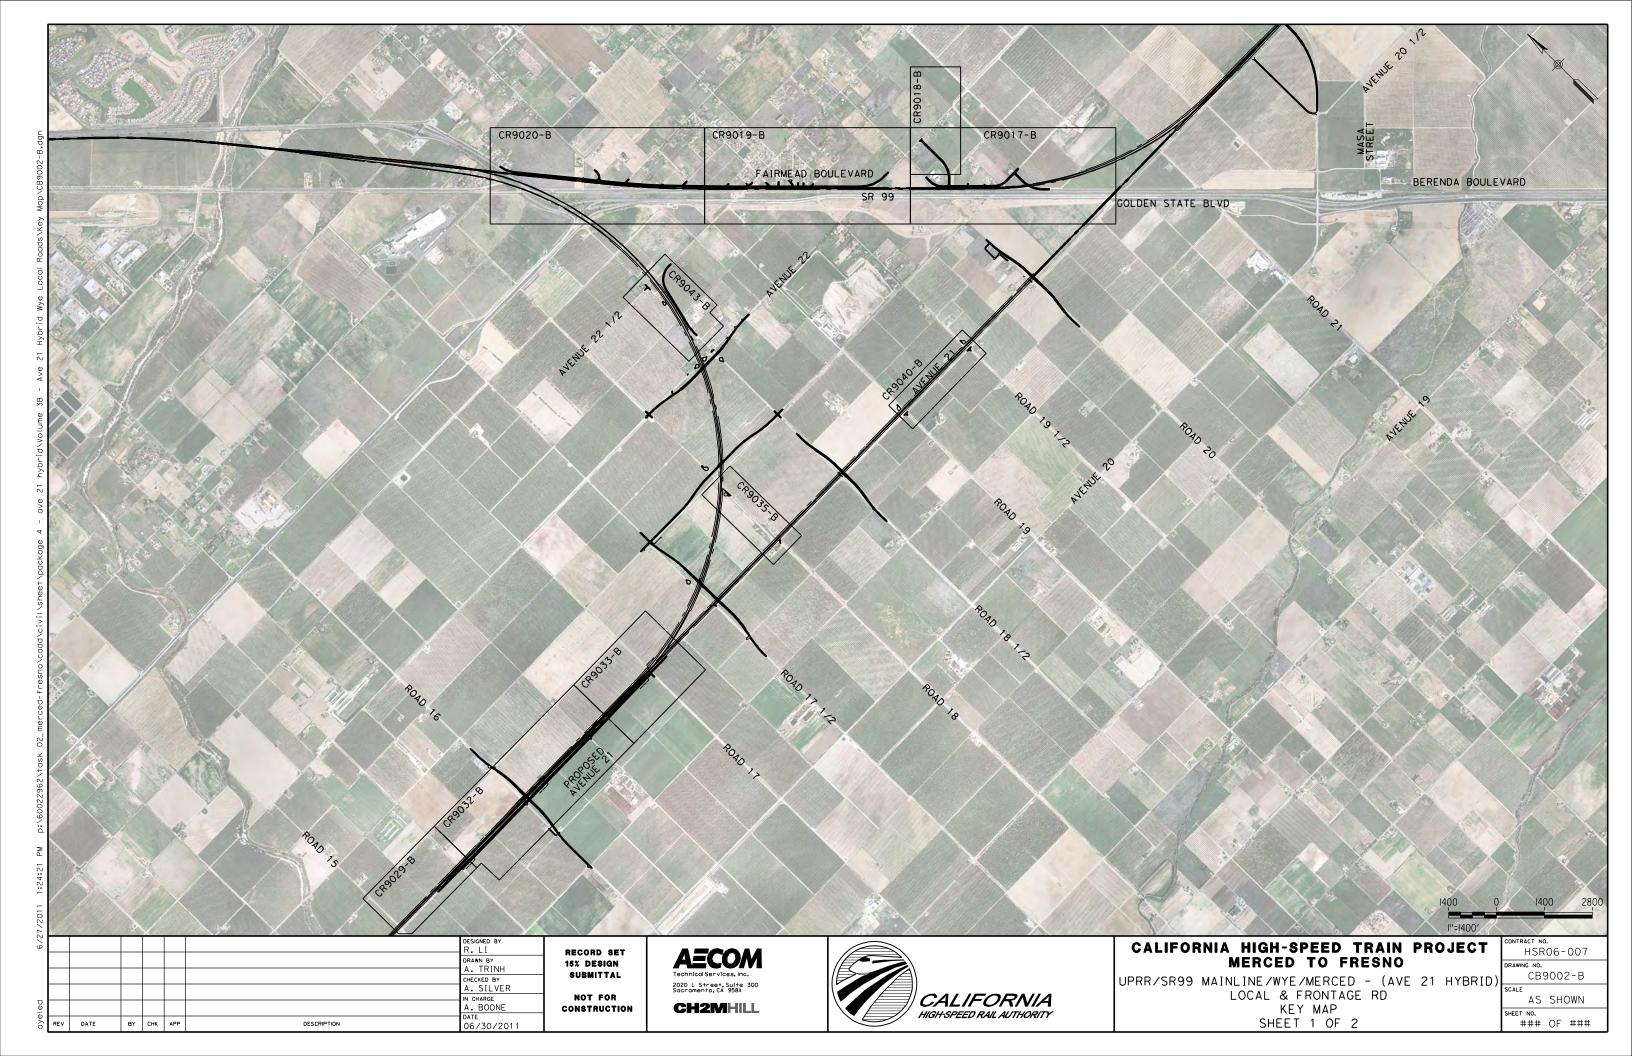


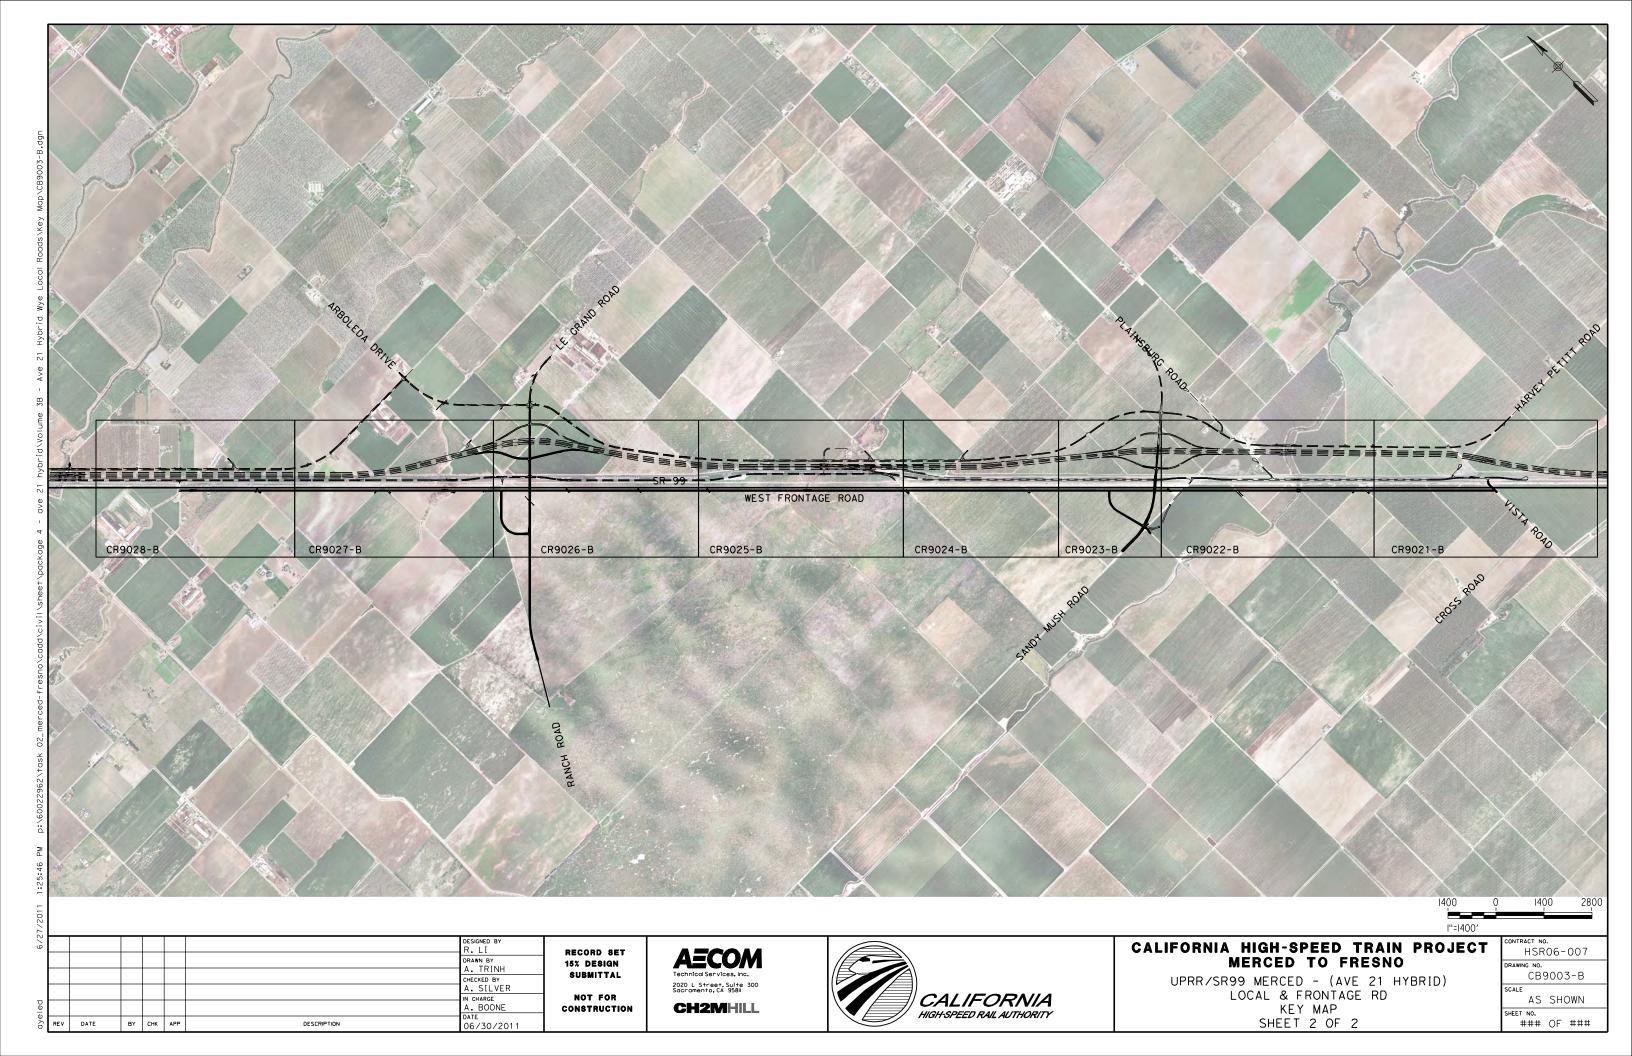

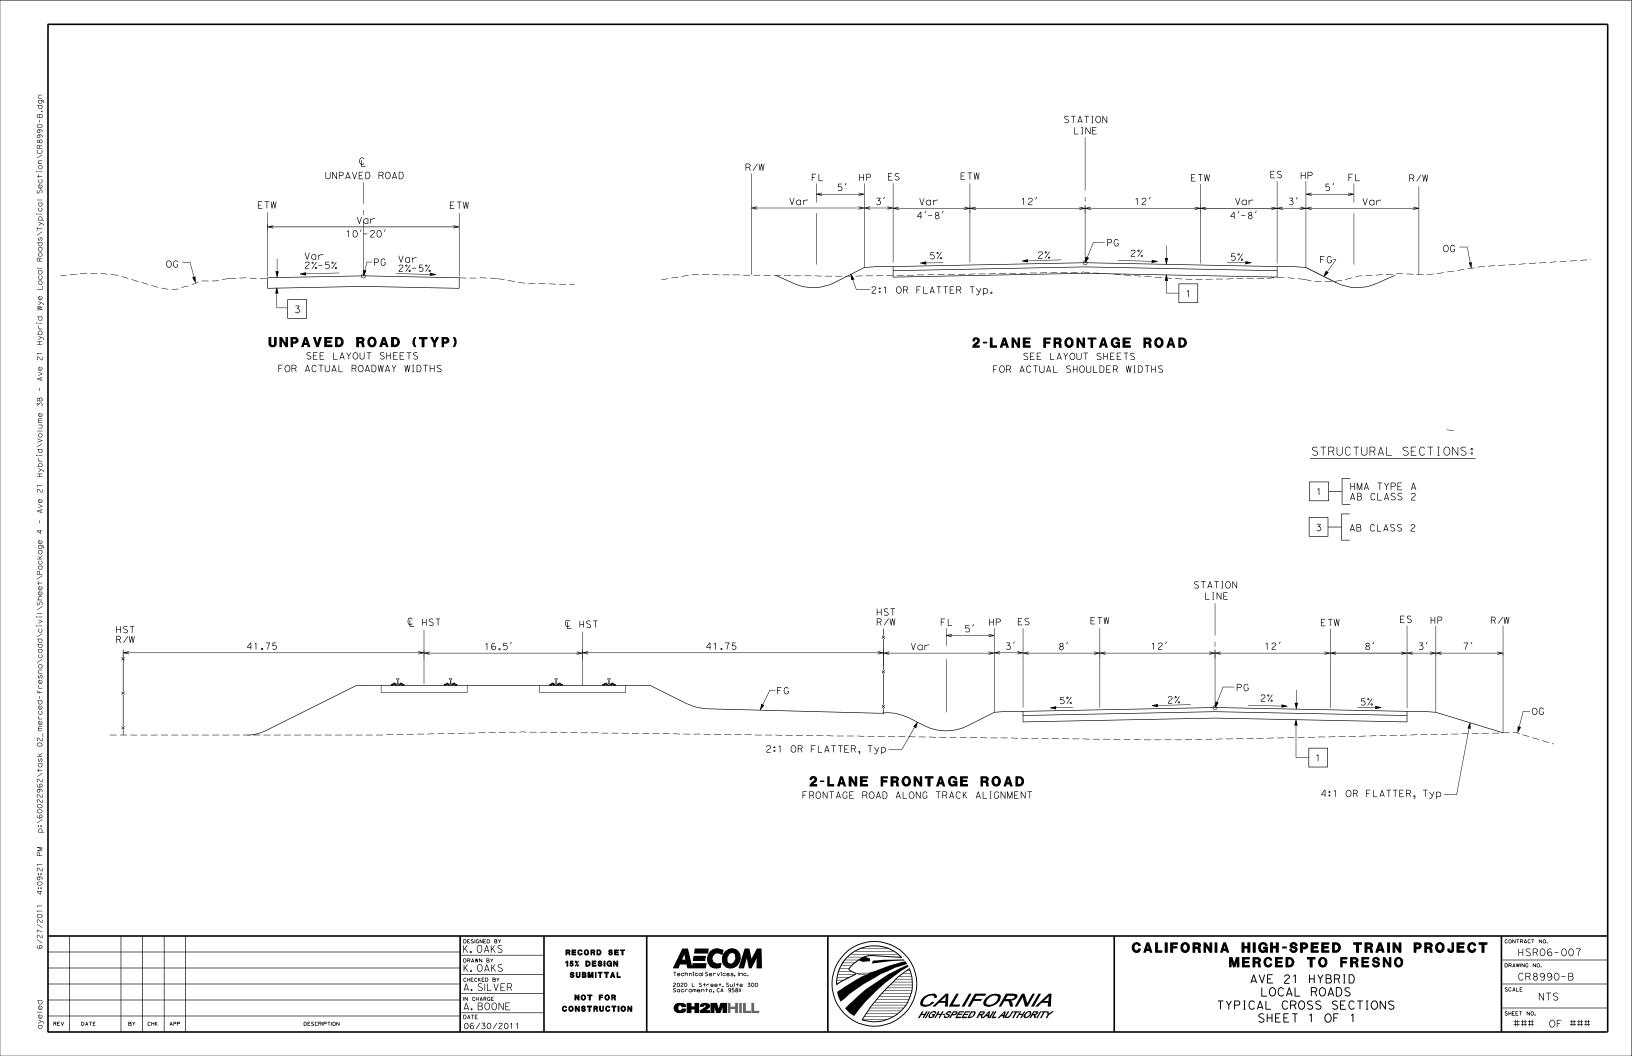

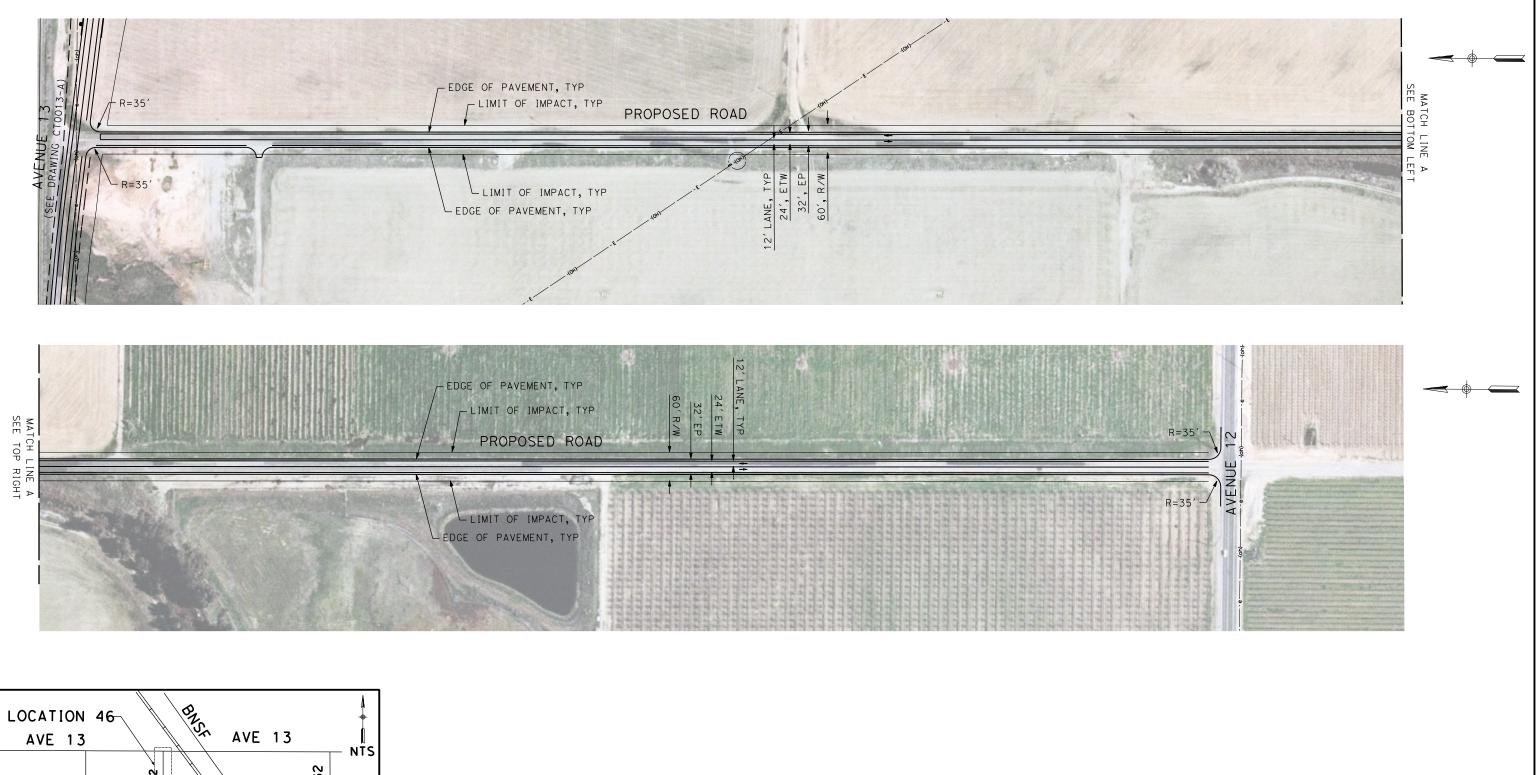

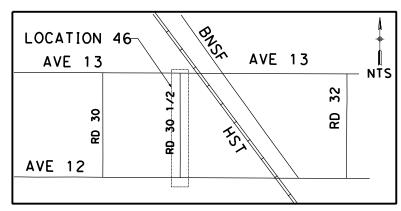

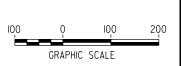

						DESIGNED BY R. GIBSON
						DRAWN BY H. PHAN
						CHECKED BY J. ZANDIAN
						IN CHARGE
						A. BOONE
REV	DATE	BY	СНК	APP	DESCRIPTION	07/27/2011

RECORD SET
15% DESIGN
SUBMITTAL
NOT FOR
CONSTRUCTION


AECOM
Technical Services, Inc.
2020 L Street, Suite 300
Sacramento, CA 958II
CH2MHILL





CALIFORNIA HIGH-SPEED TRAIN PROJECT MERCED TO FRESNO


BNSF MAIN LINE - (AVE 21 HYBRID)
LOCAL ROAD - ROAD 30 1/2
LAYOUT
SHEET 1 OF 1


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	DRAWING NO.						
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	SHEET NO.						
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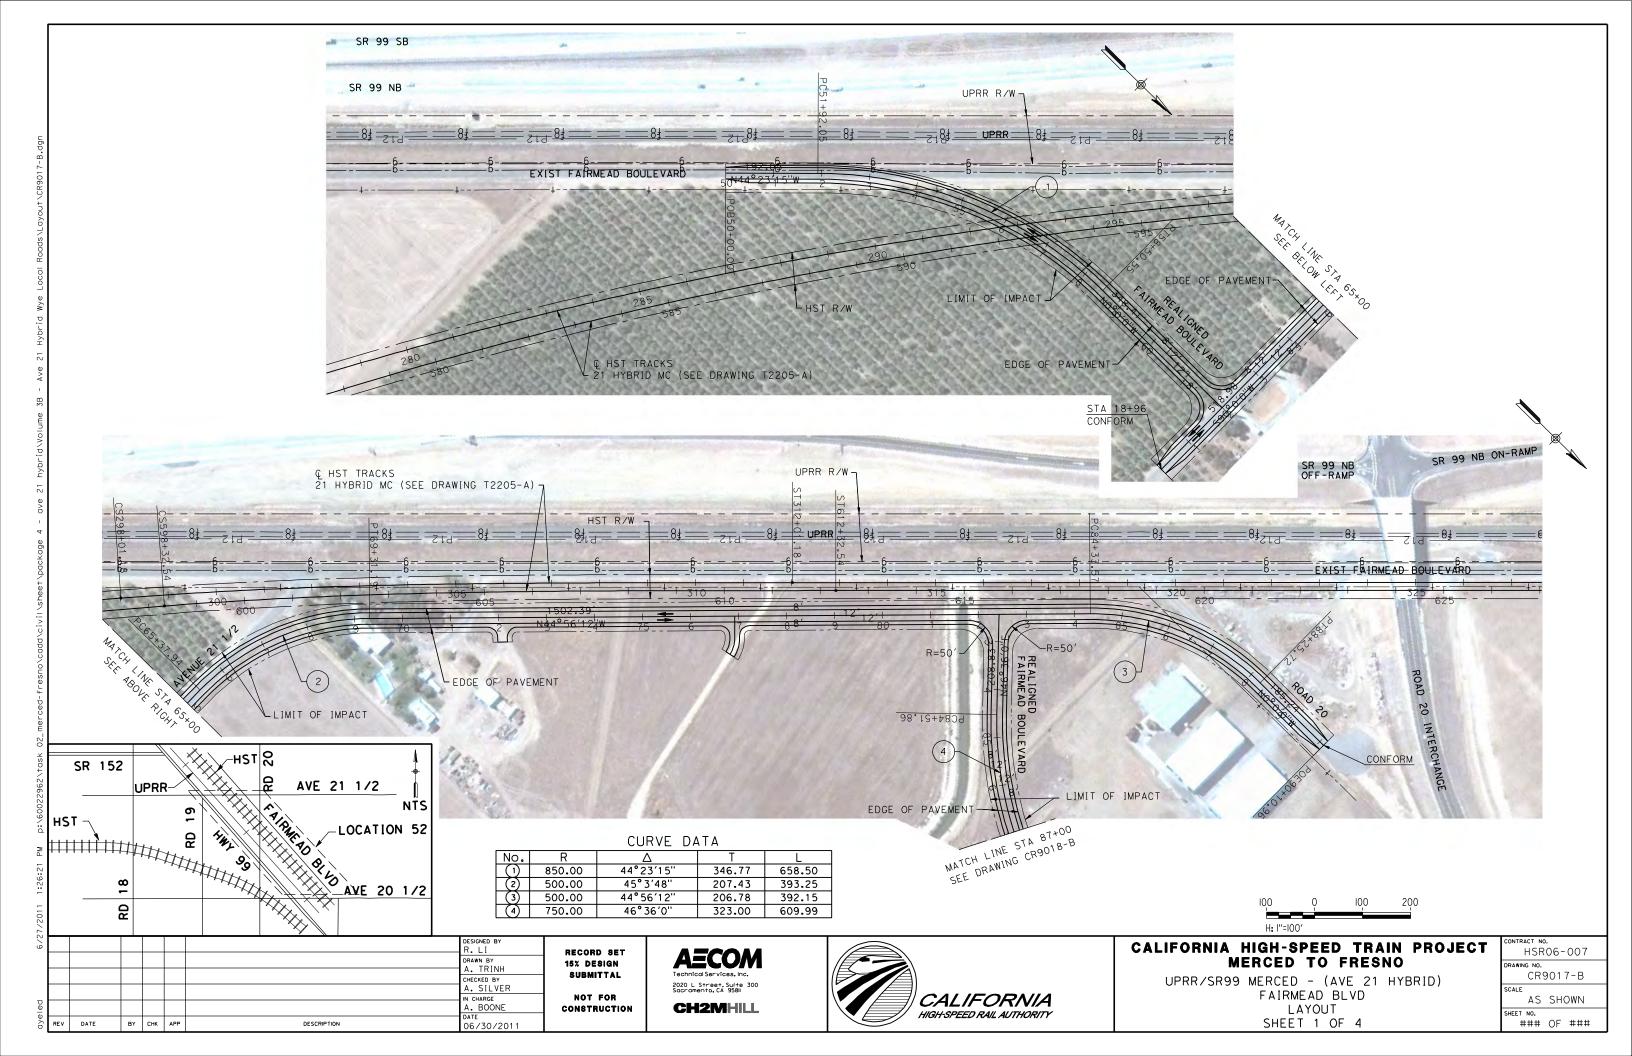


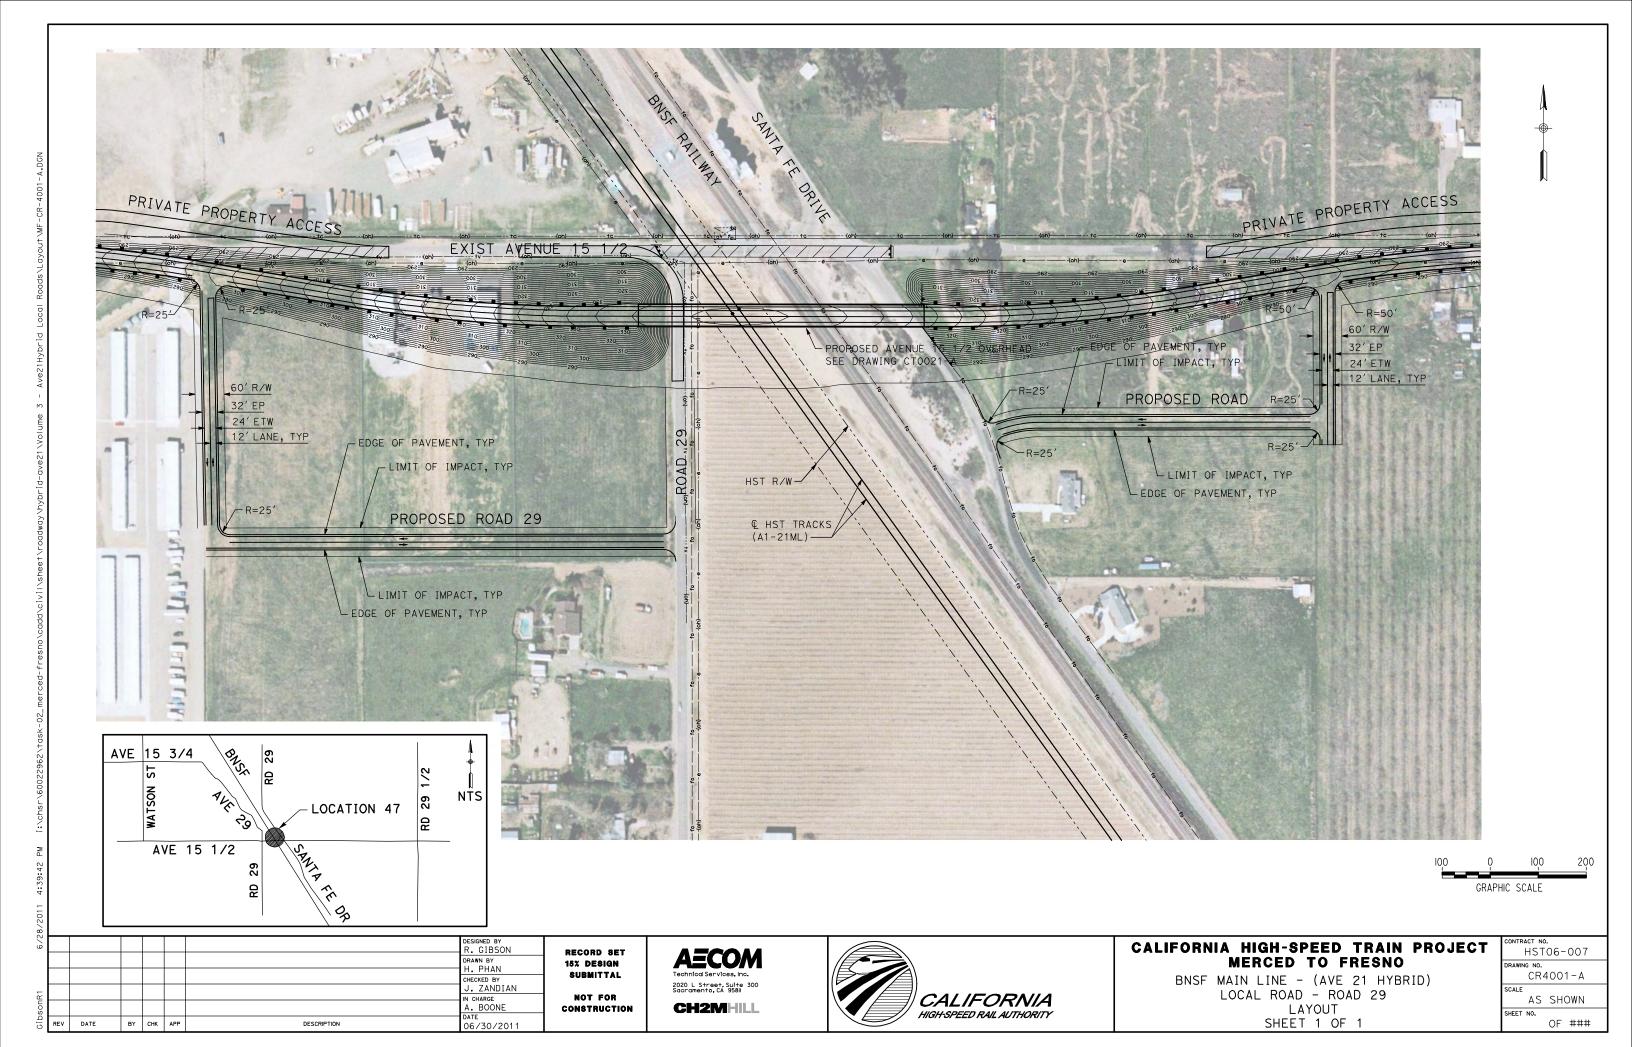


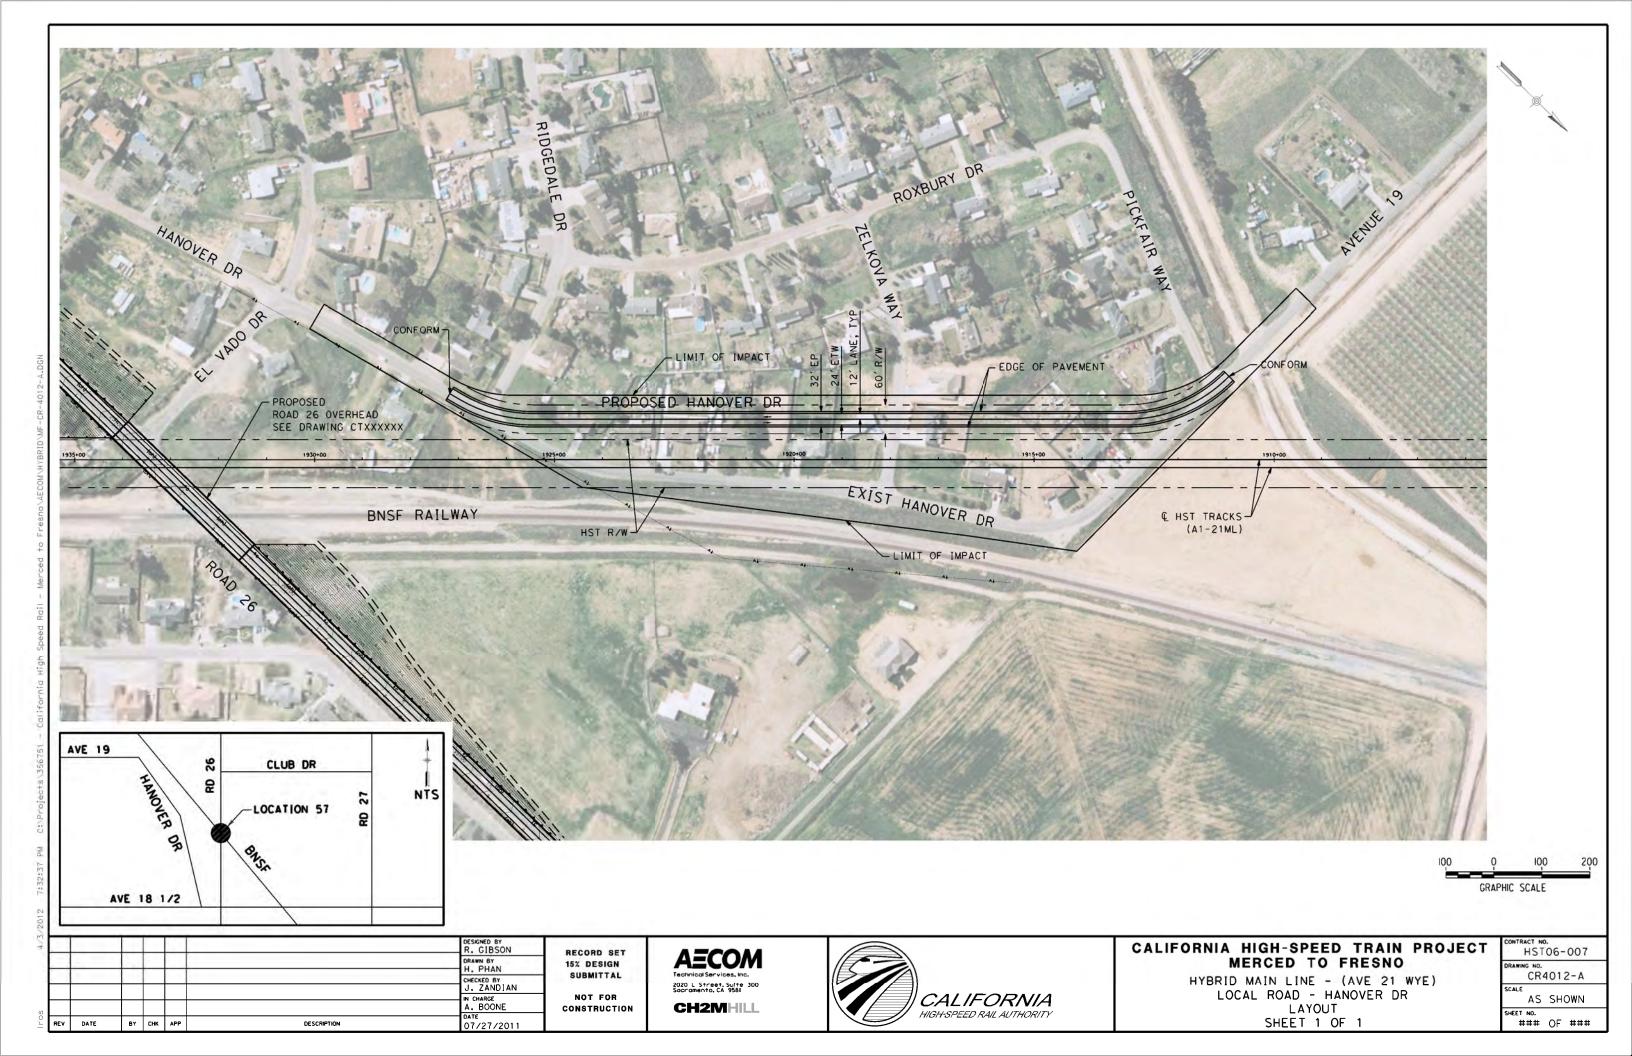

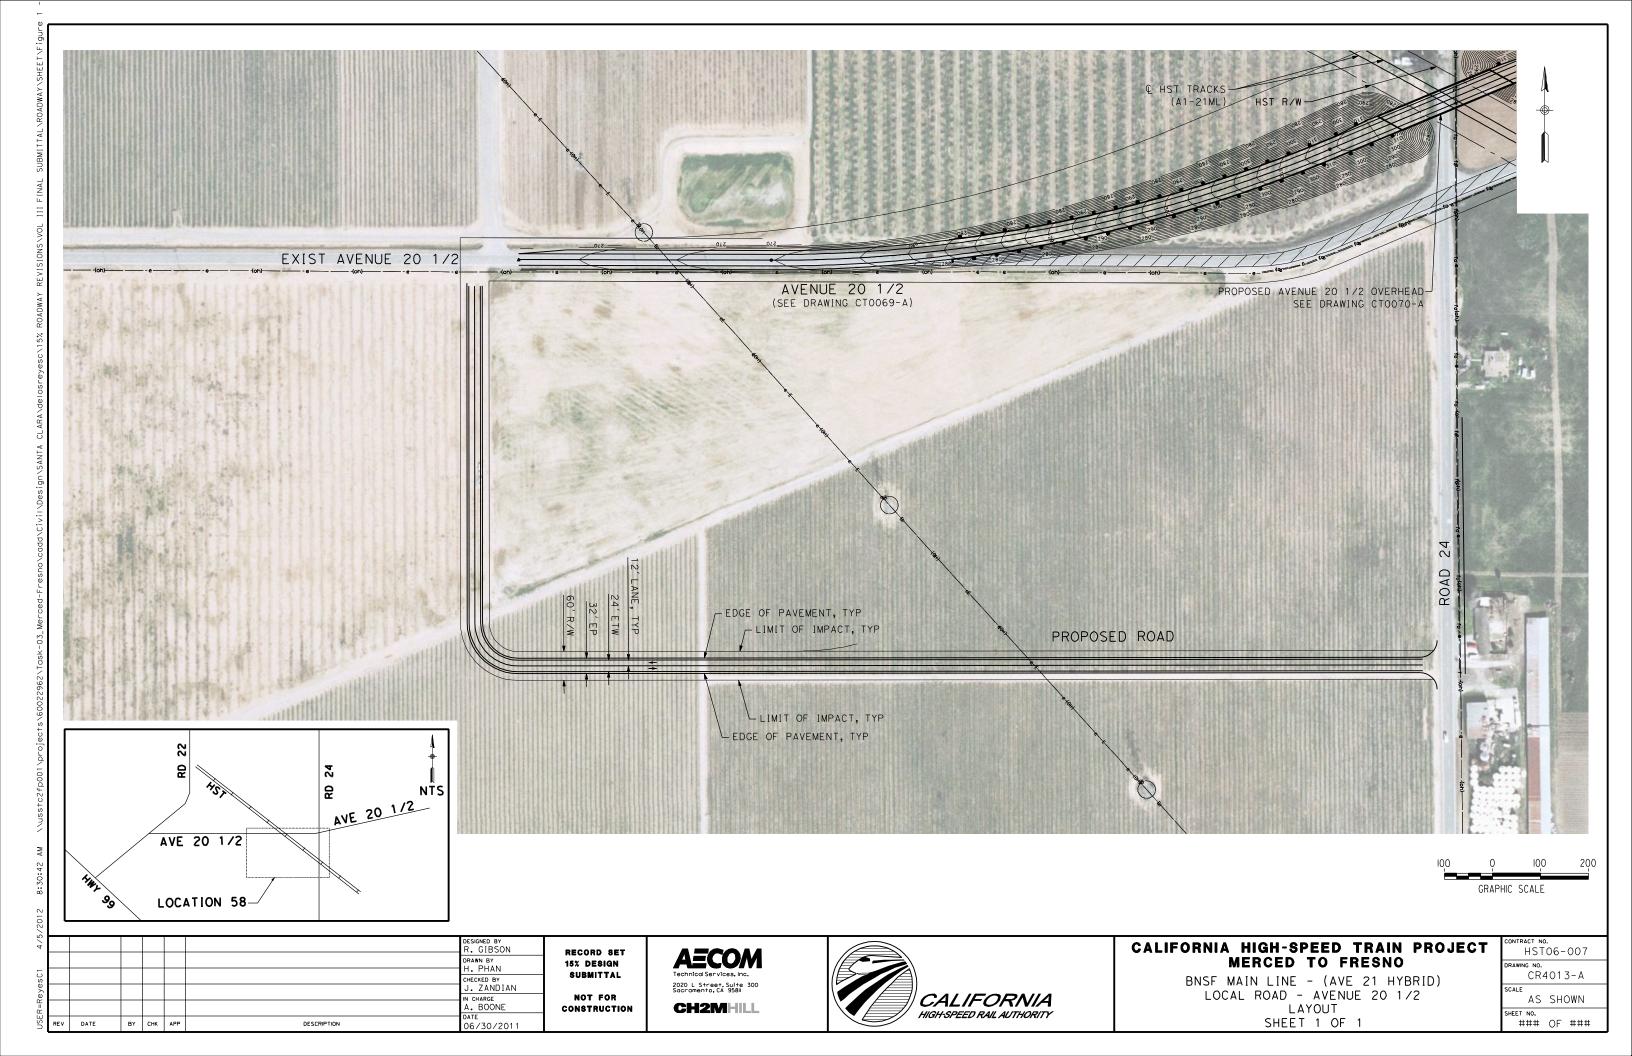

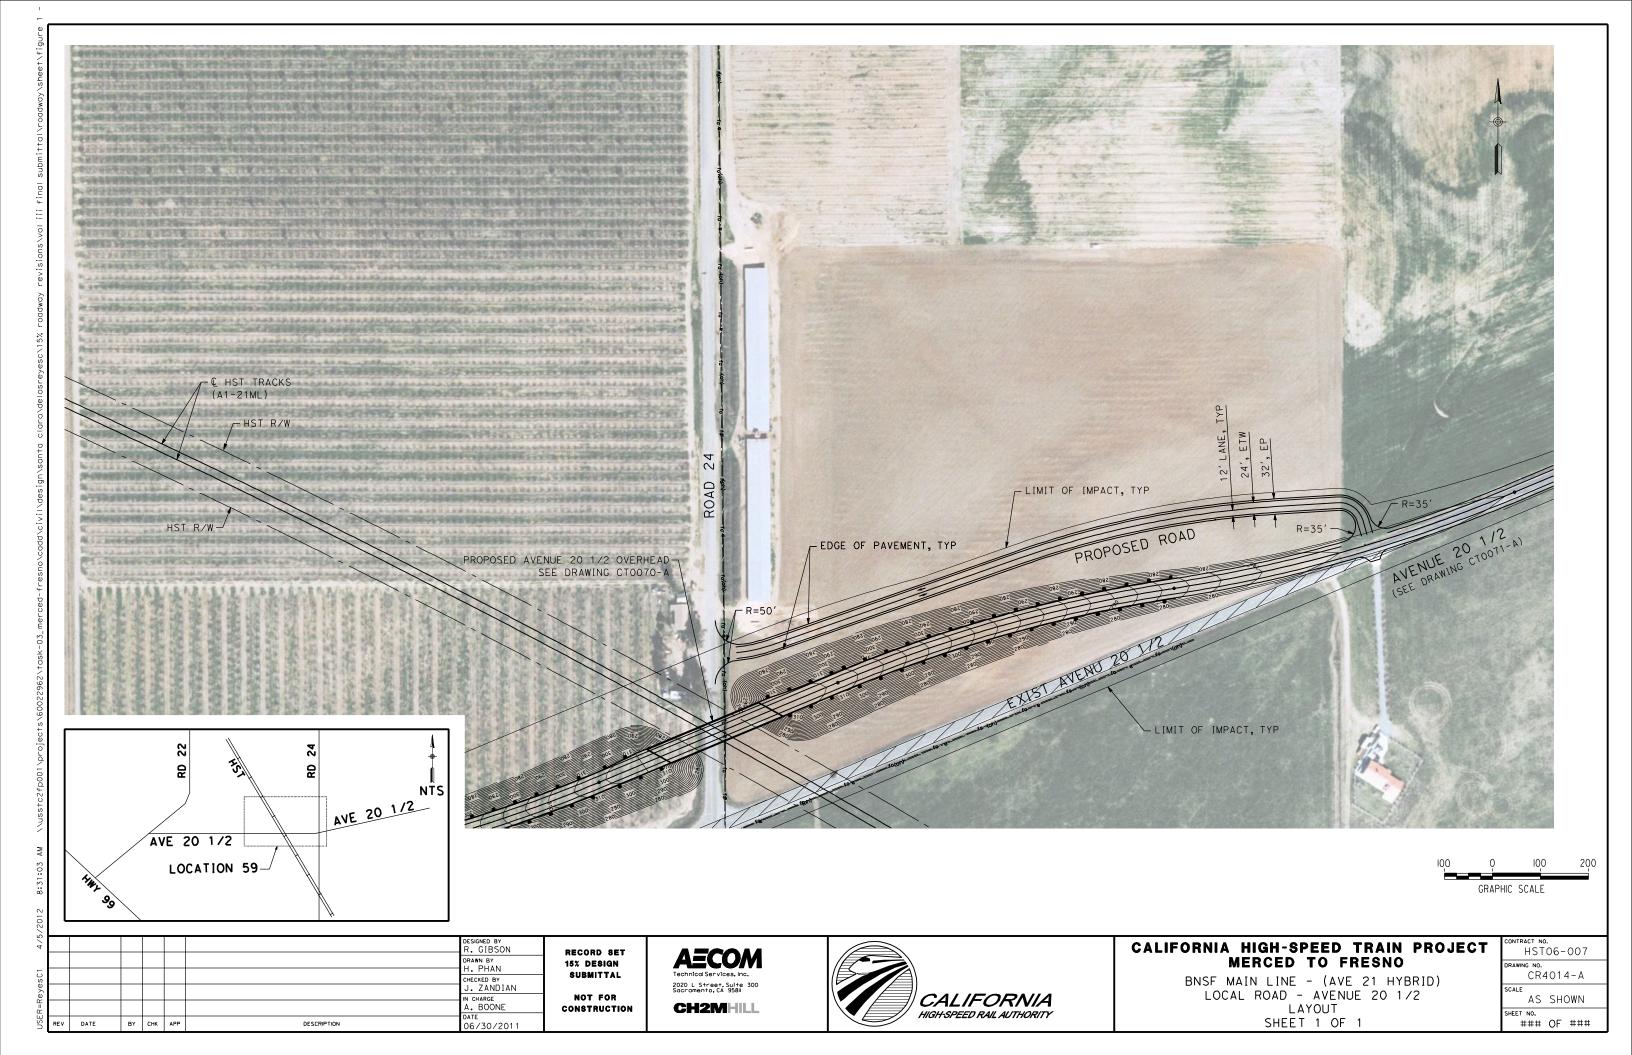

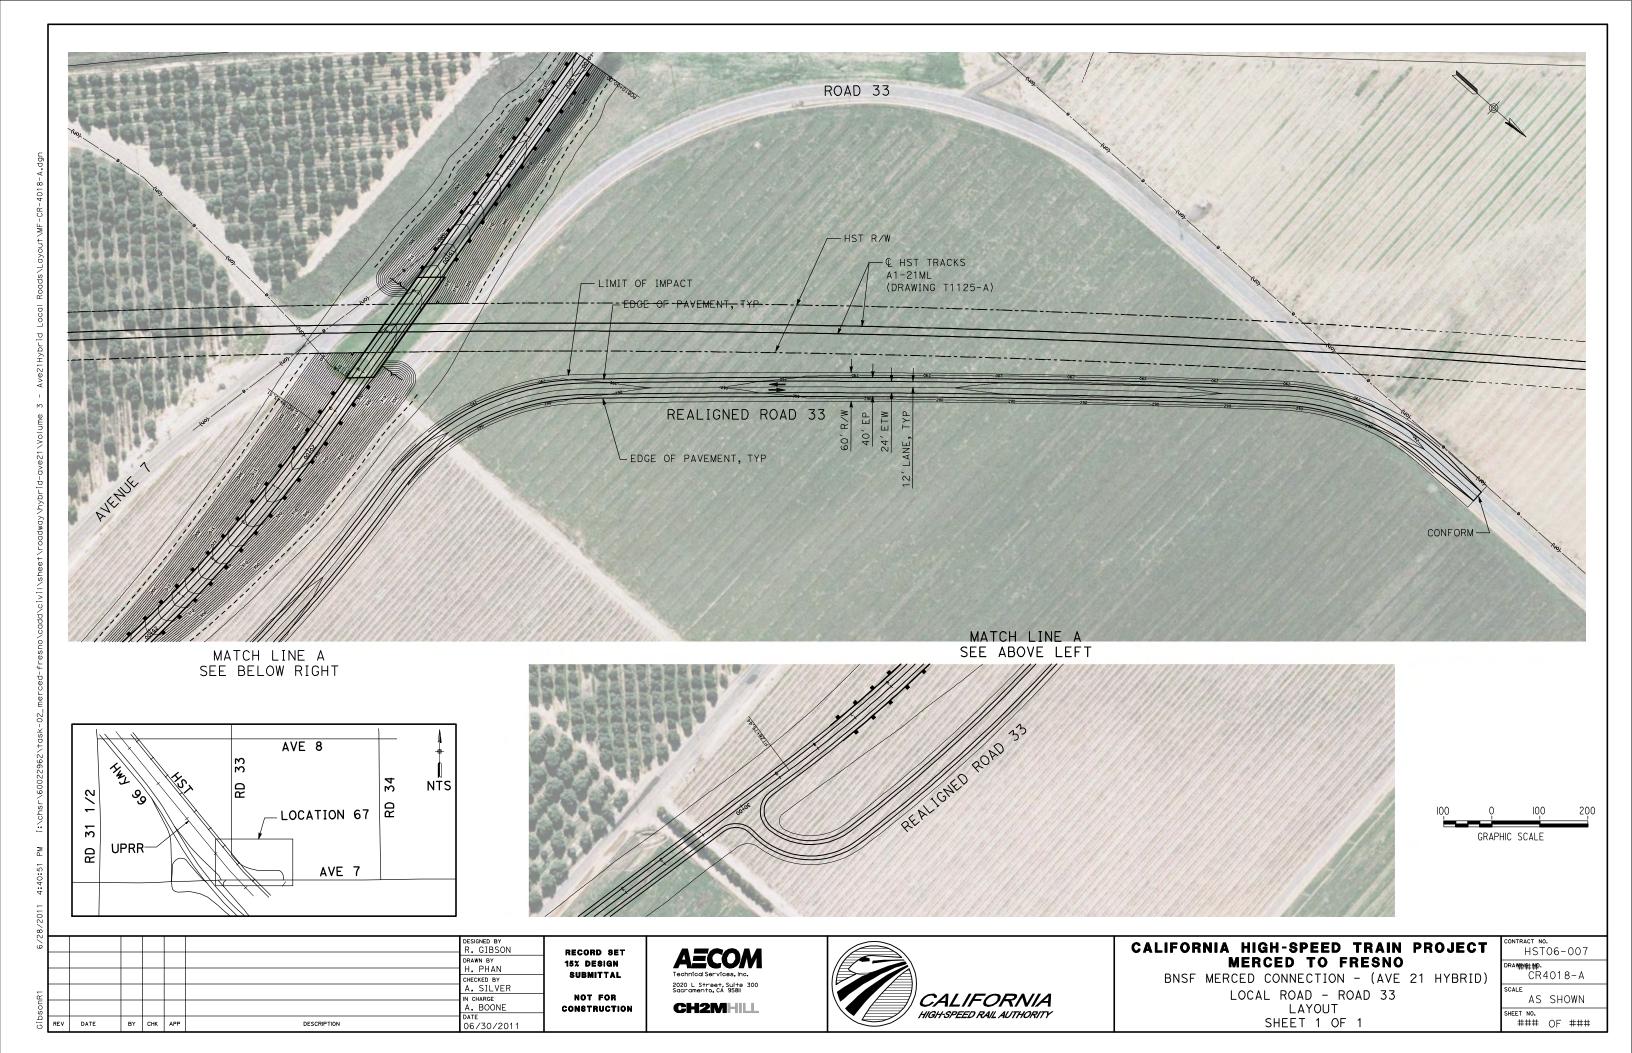

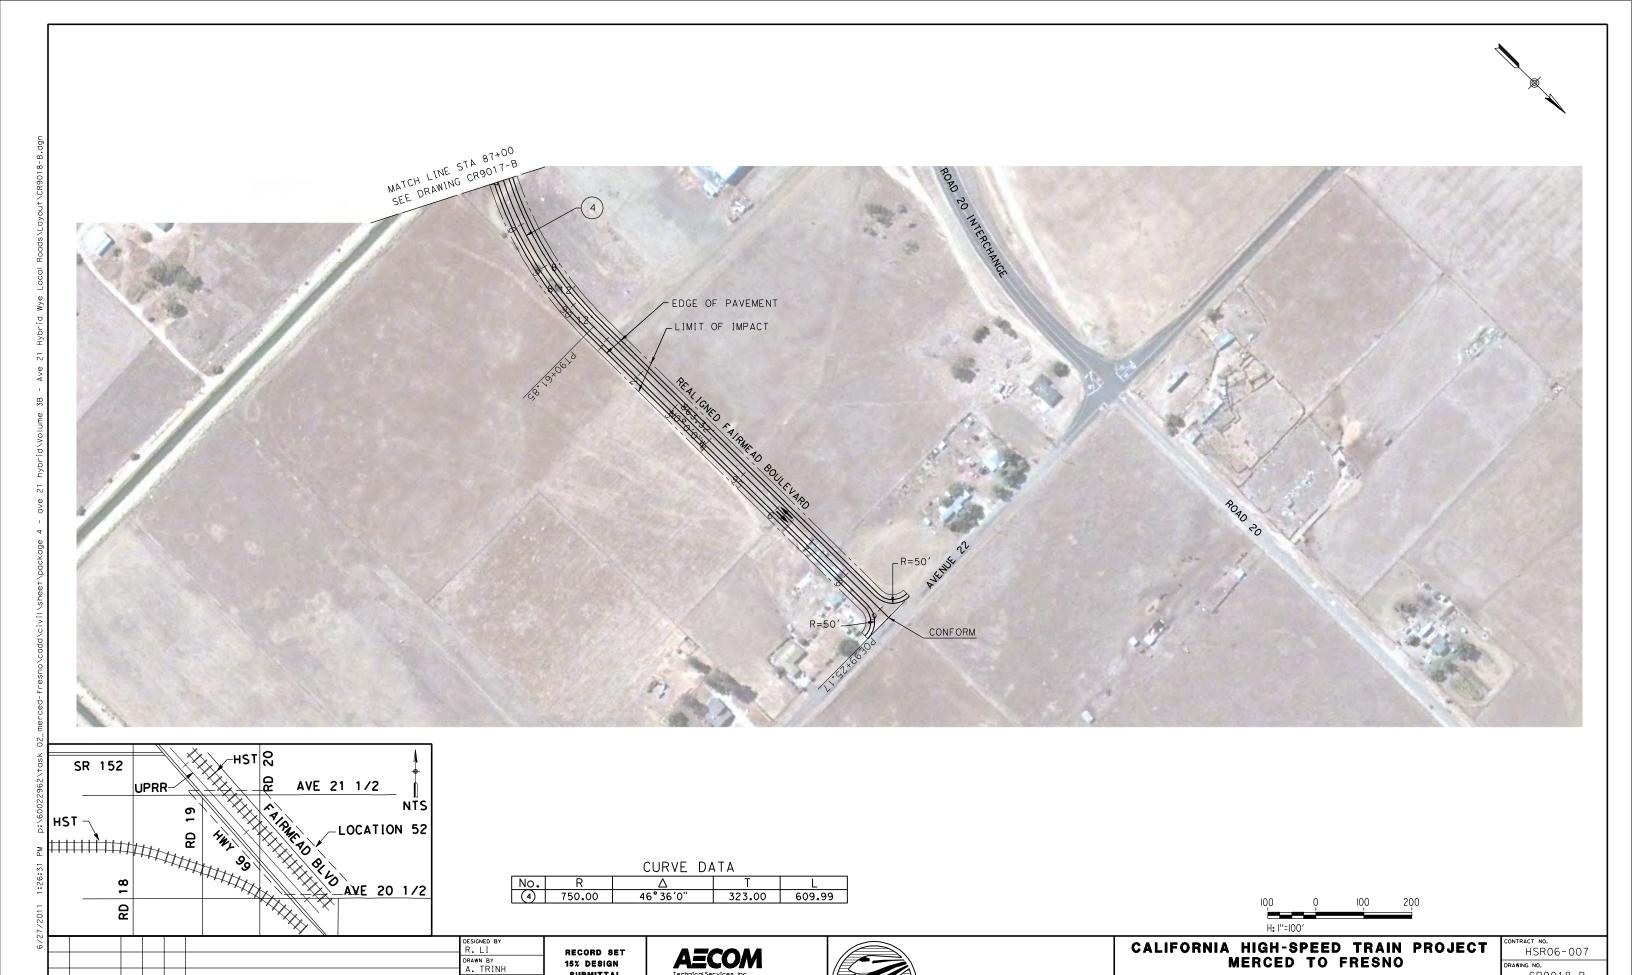

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NOT FOR

CONSTRUCTION

2020 L Street, Suite 300 Sacramento, CA 95811

CH2MHILL

CALIFORNIA HIGH-SPEED RAIL AUTHORITY

CHECKED BY A. SILVER


IN CHARGE A. BOONE DATE 06/30/2011


BY CHK APP


DESCRIPTION


CR9018-B AS SHOWN HEET NO. ### OF ###


UPRR/SR99 MERCED - (AVE 21 HYBRID) FAIRMEAD BLVD LAYOUT SHEET 2 OF 4

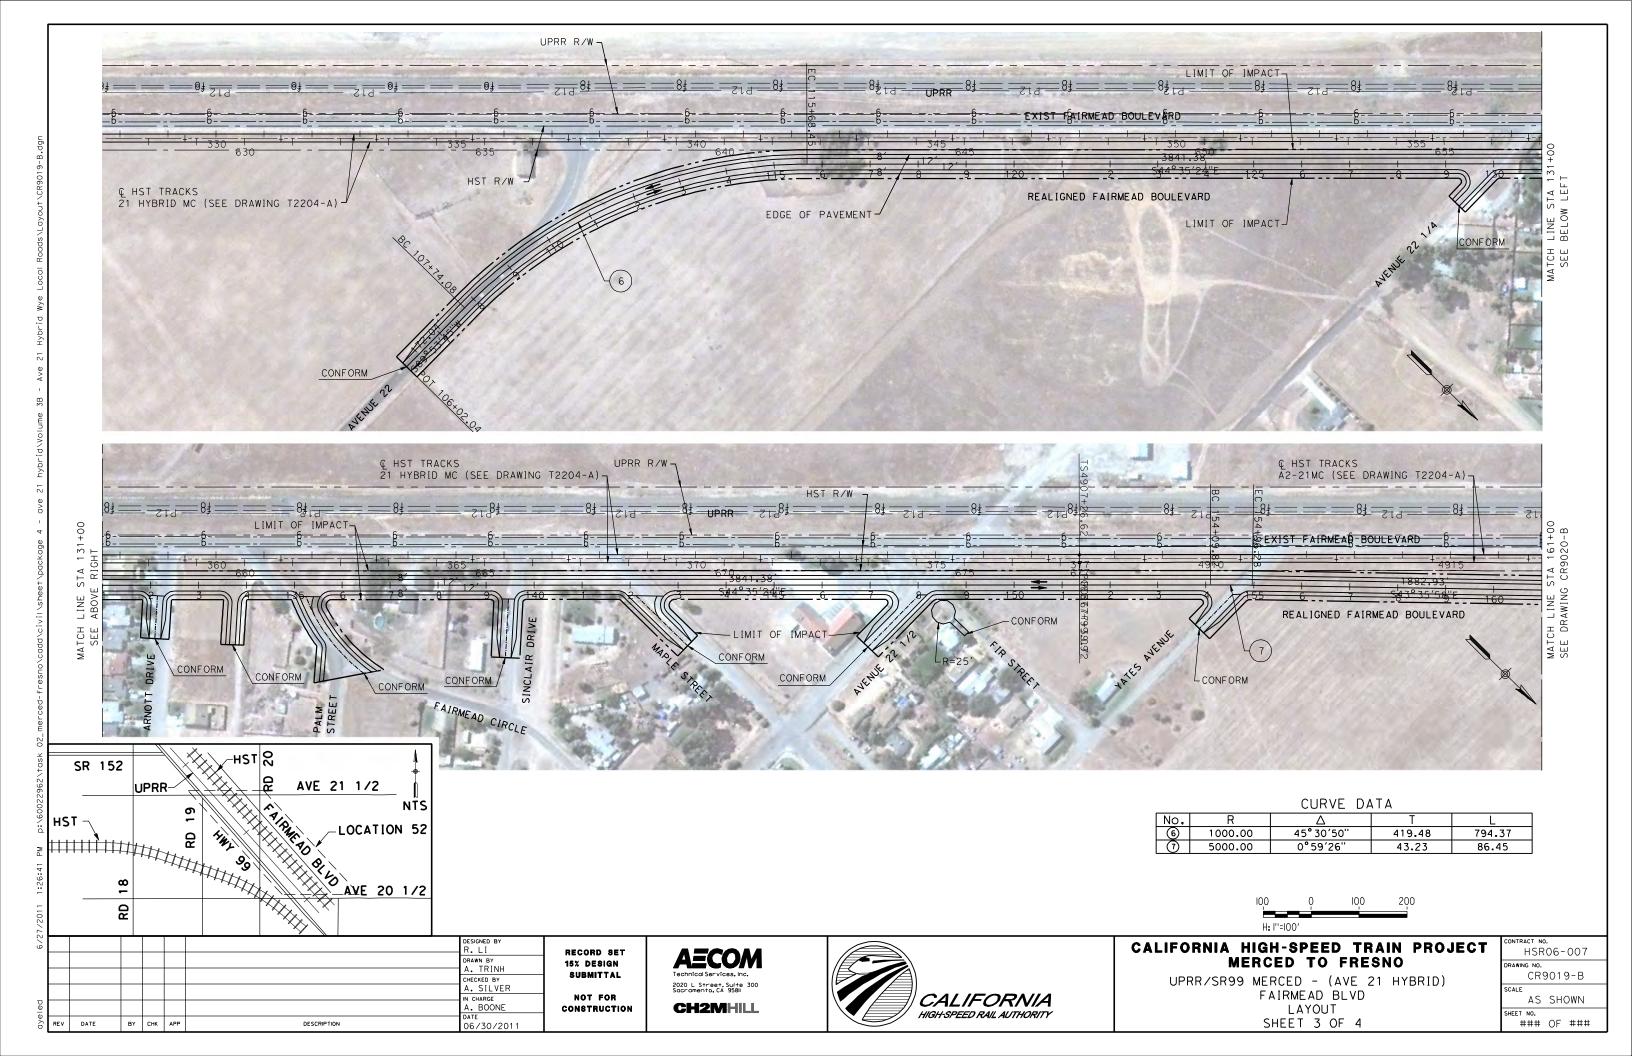


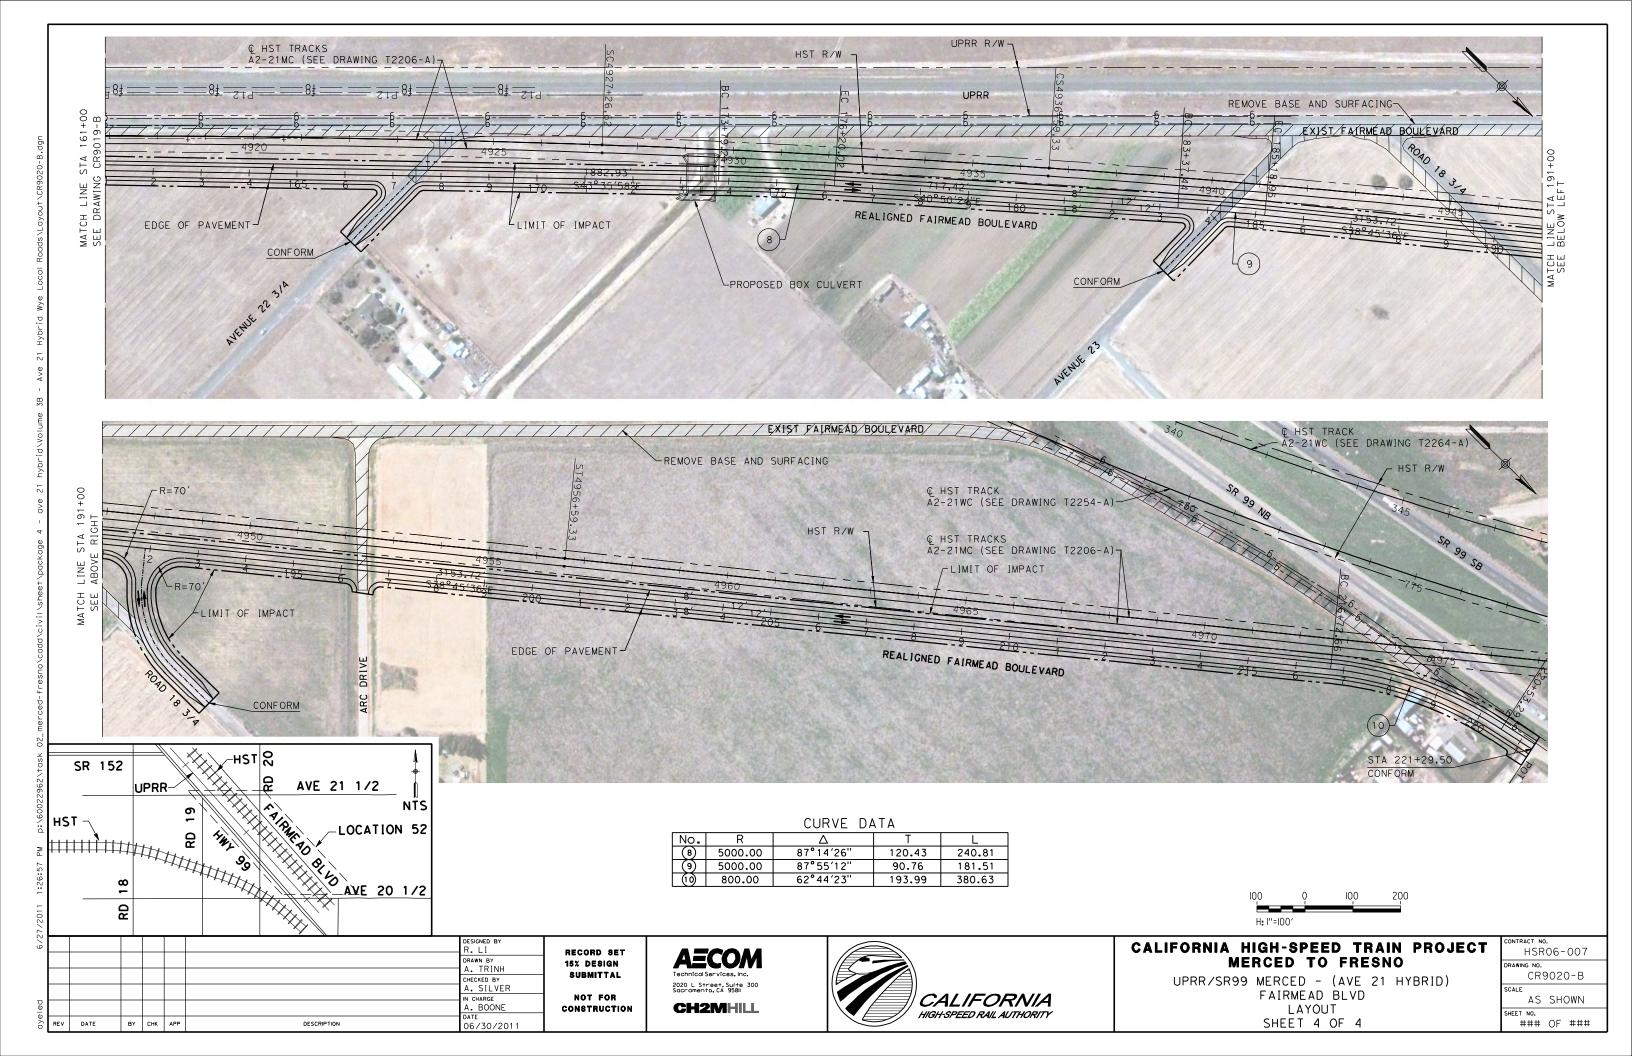


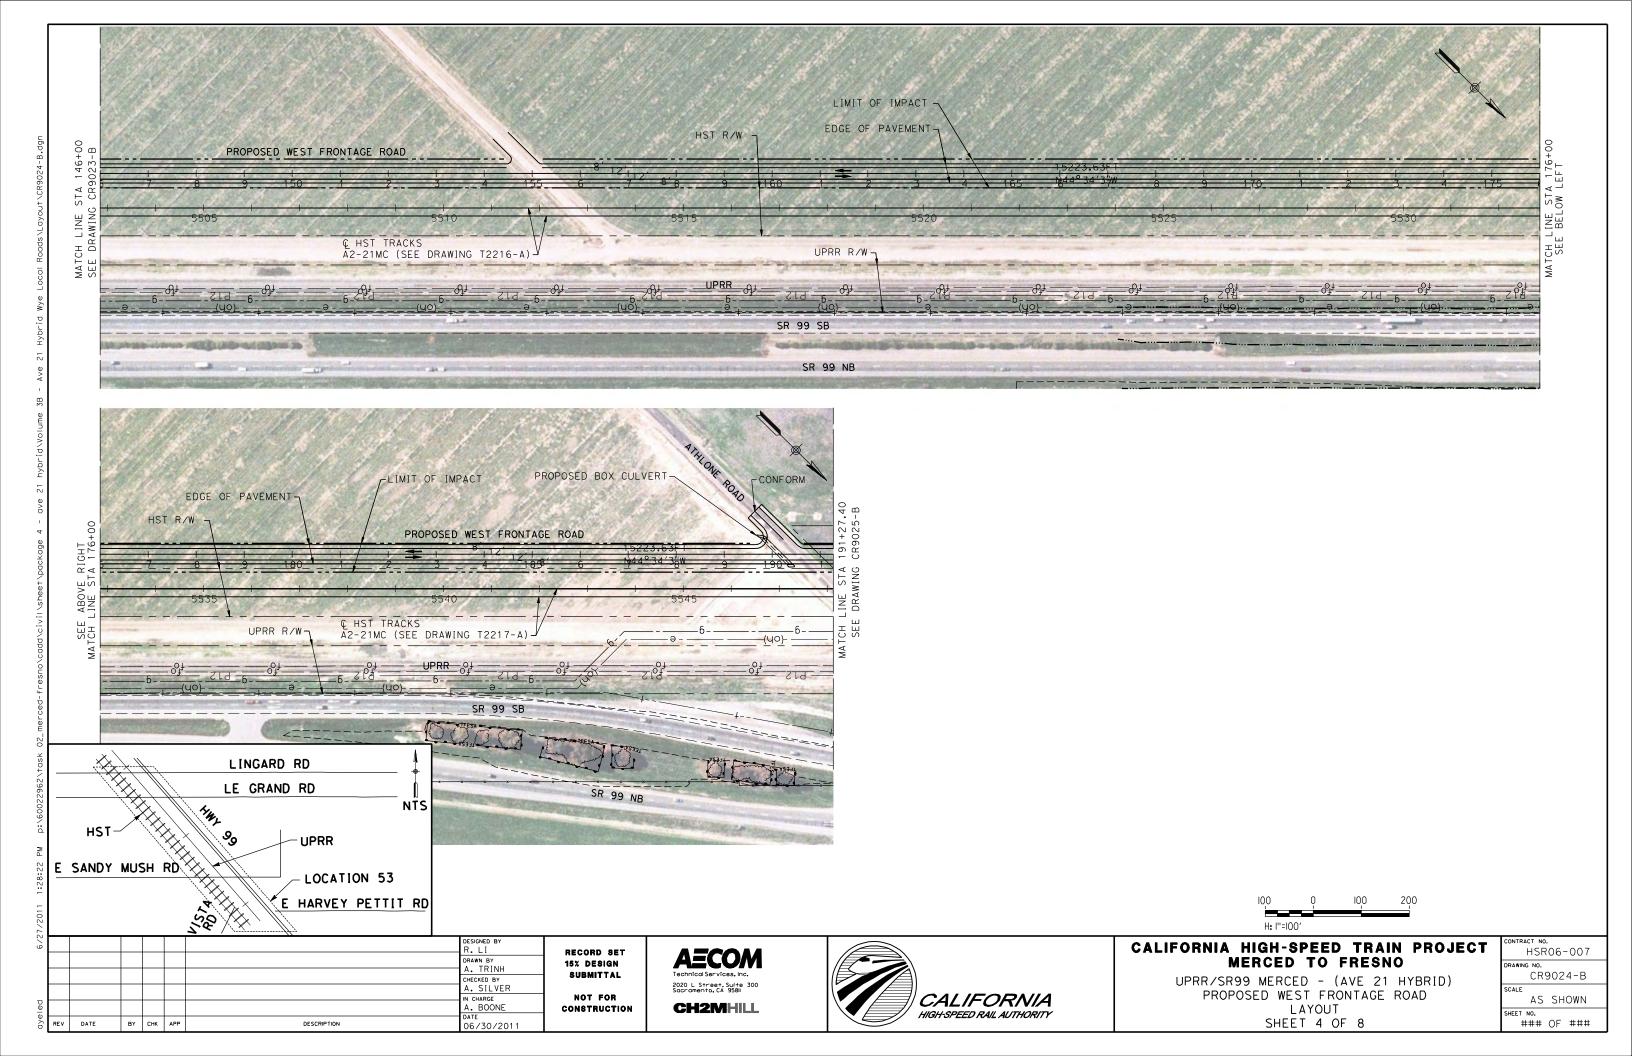

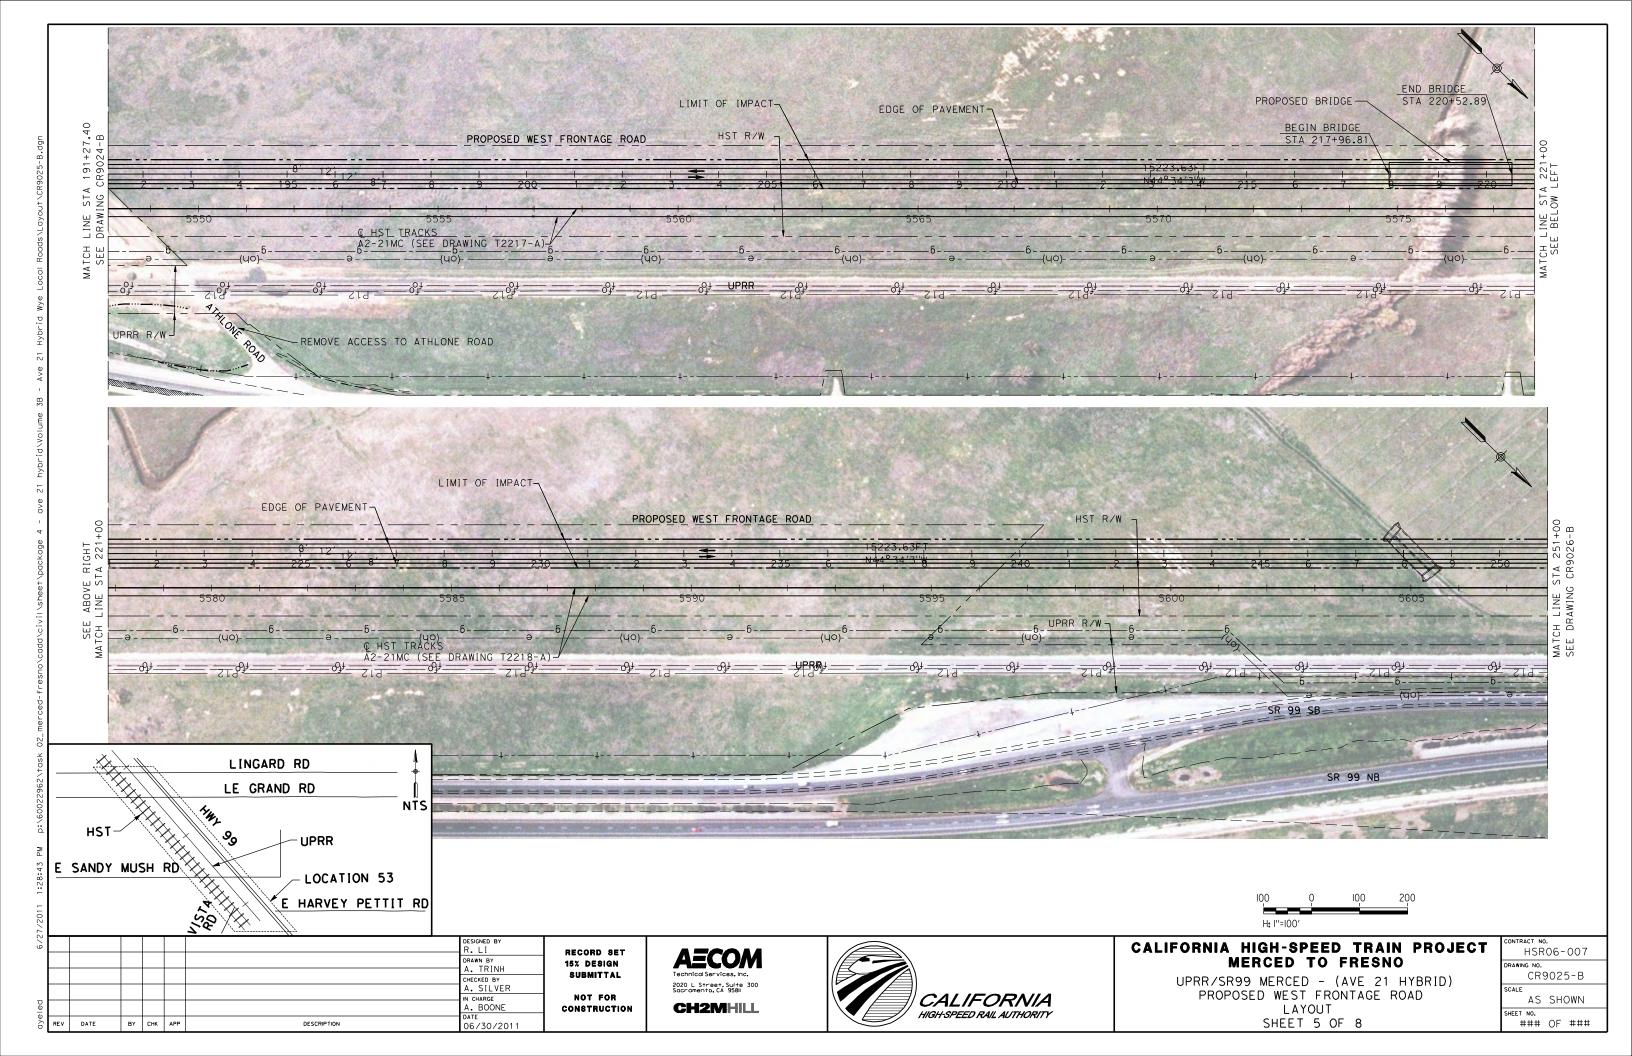

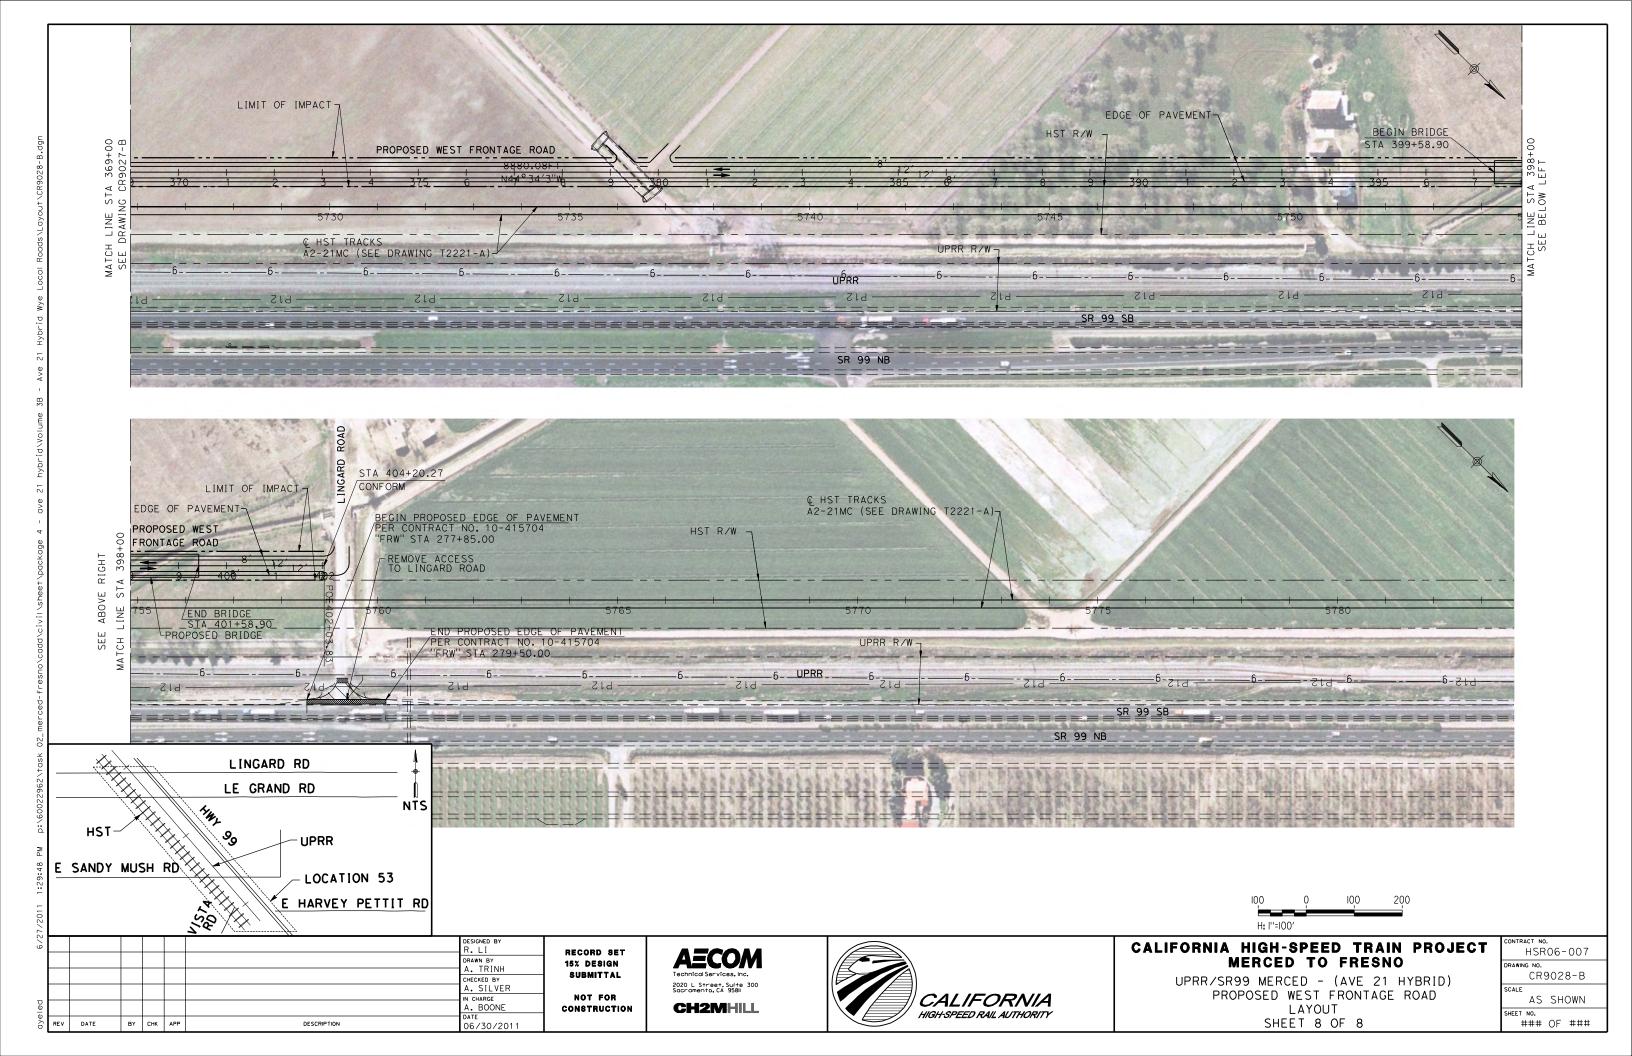

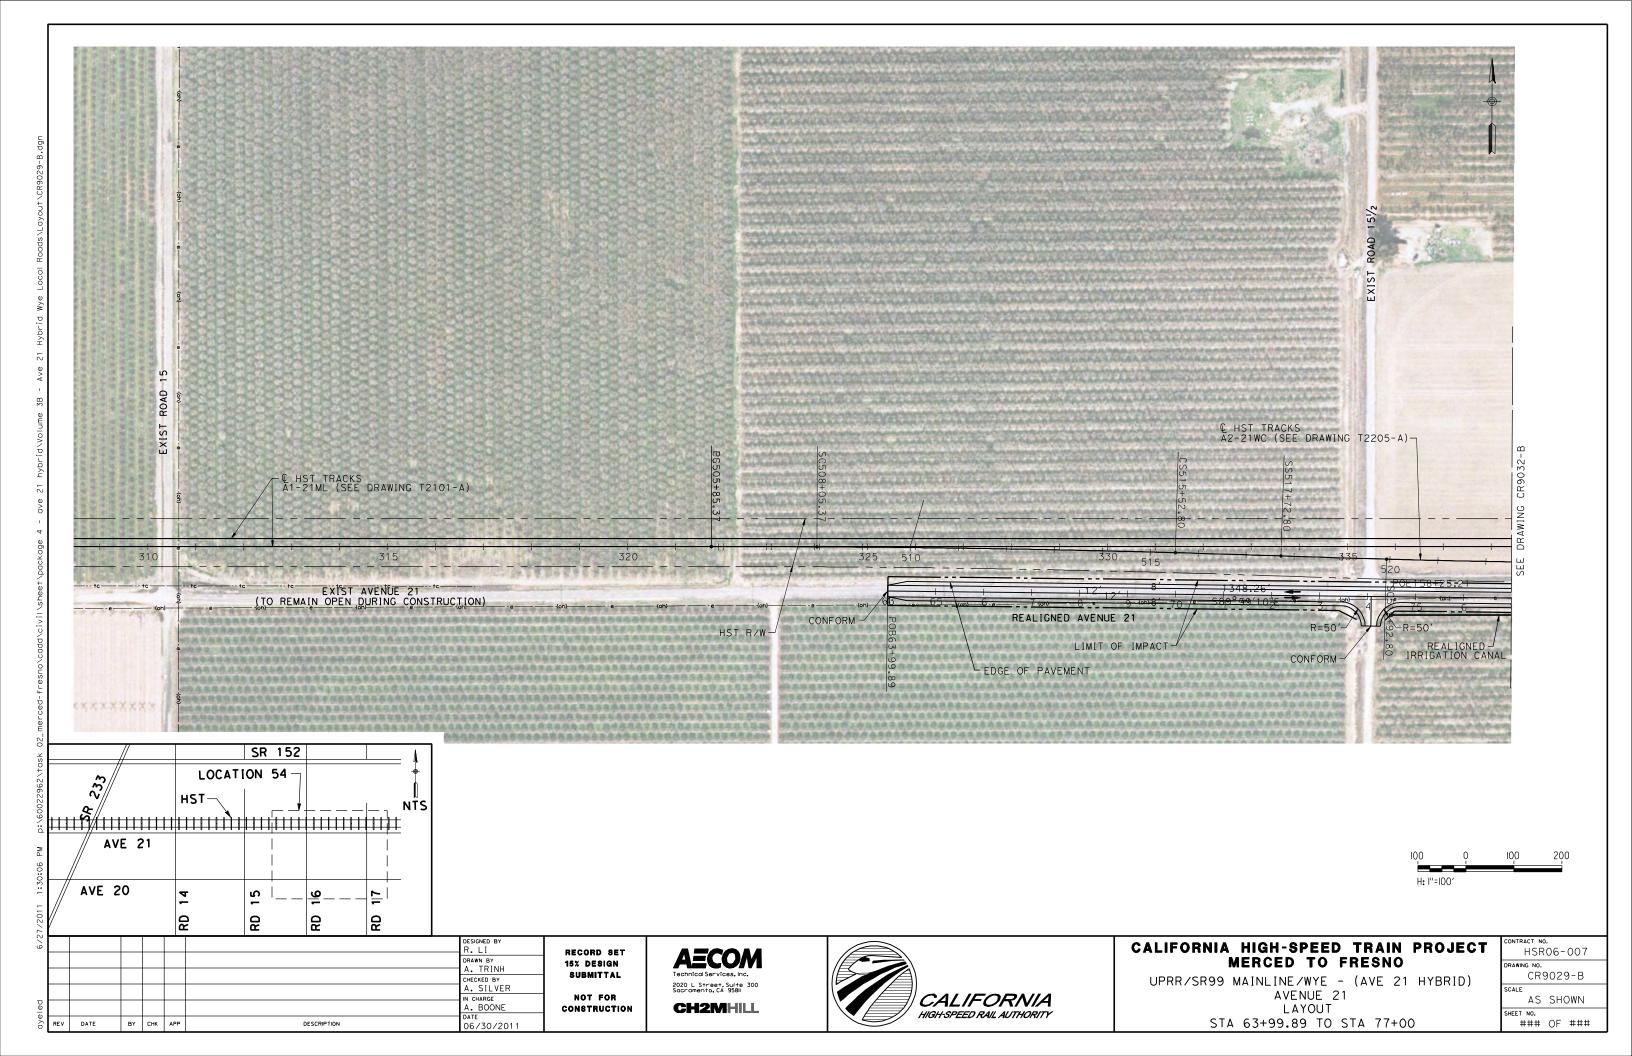

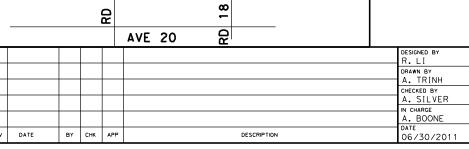

AVE 22

9 NTSI

RECORD SET 15% DESIGN SUBMITTAL NOT FOR CONSTRUCTION





1	CONTRA	ACT NO				
•		HSR06-007				
	DRAWIN	G NO.				
	CR9035-B					
	SCALE					
		AS	SHOWN			

	CALIFORNIA HIGH-SPEED TRAIN PROJECT	CONTRACT NO. HSRO6-007
	MERCED TO FRESNO UPRR/SR99 MAINLINE/WYE - (AVE 21 HYBRID)	DRAWING NO. CR9035-B
CALIFORNIA	ROAD 18	SCALE AS SHOWN
HIGH-SPEED RAIL AUTHORITY	LAYOUT	SHEET NO. ### OF ###

